
### CENTENNIAL HALL IMPROVEMENTS AND RENOVATION

### UNIVERSITY OF MISSOURI - MISSOURI UNIVERSITY OF SCIENCE AND TECHNOLOGY, FOR THE CURATORS OF THE UNIVERSITY OF MISSOURI - RC000638

300 W. 12TH STREET **ROLLA, MO 65409 BID-PERMIT SET** 

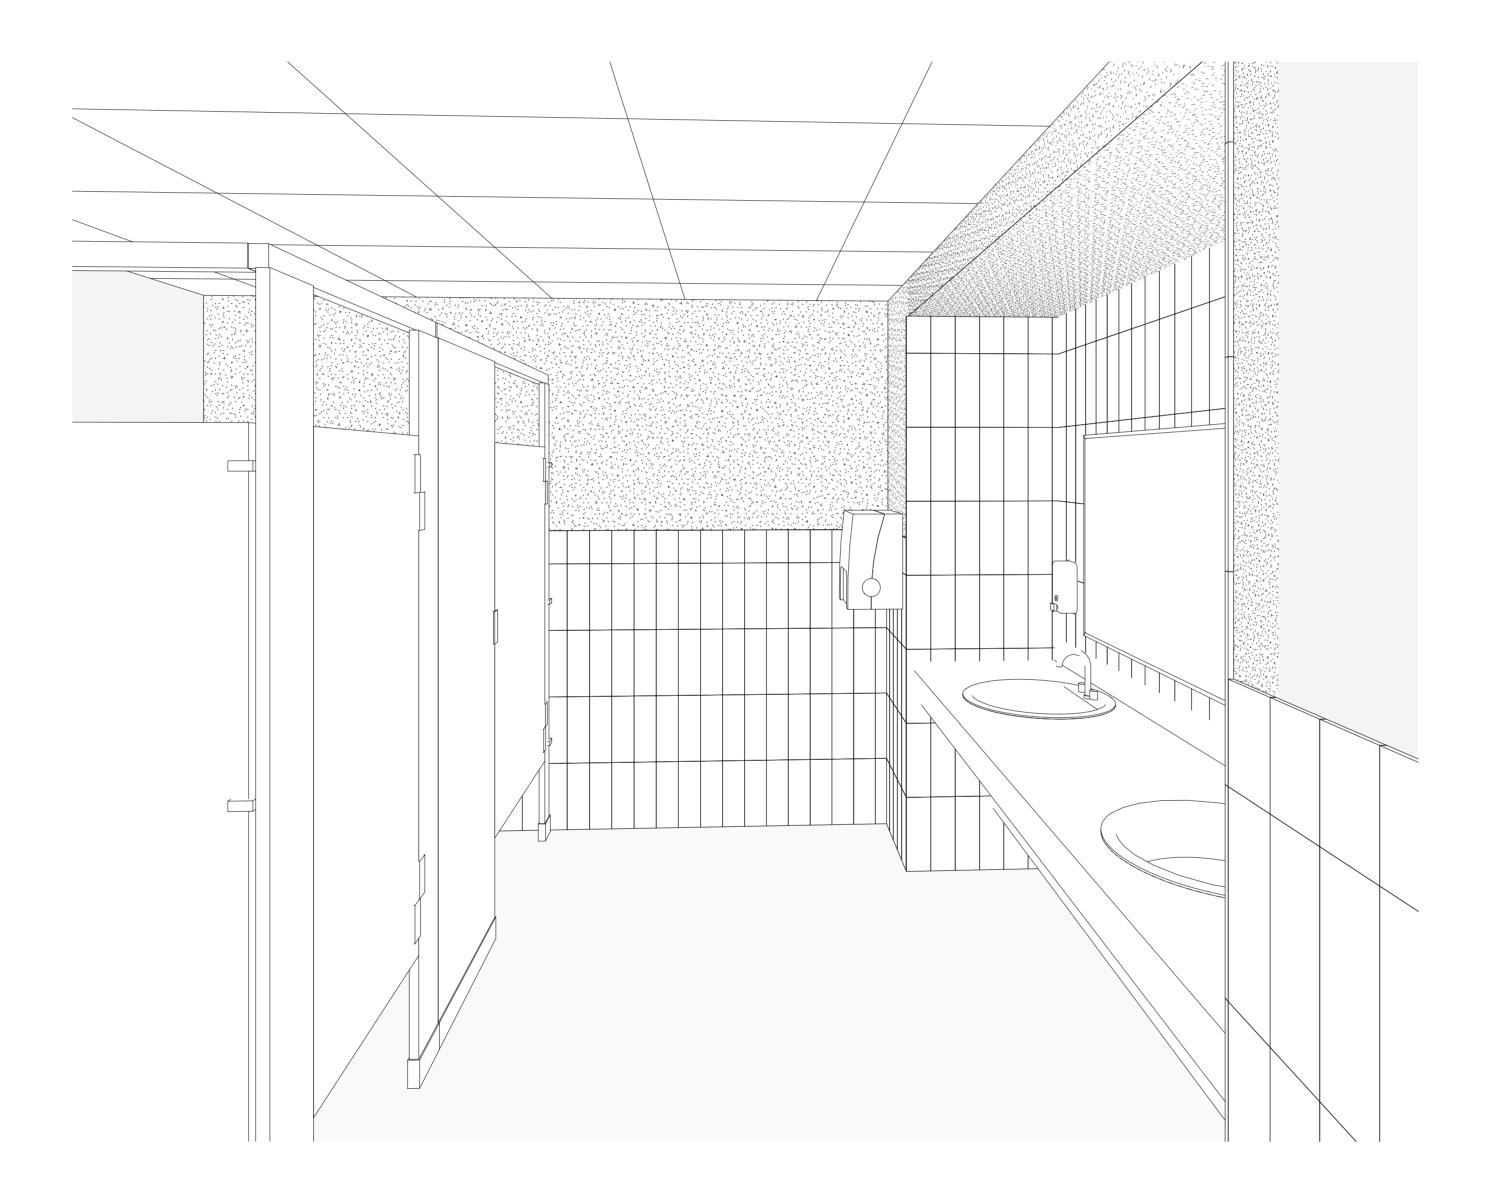

ARCHITECT OF RECORD:	MEP ENGINEER	ELEVATOR CONSULTANT	CIVIL ENGINEER
PARAGON PAGE 11 TECTURE	engineering consultants	Safety. Compliance. Performance.	TARCHER-ELGIN engineering surveying architecture
637 WEST COLLEGE STREET SPRINGFIELD, MO 65806 PH: 417-885-0002	3333 E. BATTLEFIELD RD, SUITE 1000 SPRINGFIELD, MISSOURI 65804 417.881.0020	600 EMERSON RD, SUITE 225 CREVE COEUR, MISSOURI 63141 314.441.3999	310 E. 6TH STREET ROLLA, MISSOURI 65401 573.364.6362

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H201 FIRST FLOOR HVAC PLAN (FOR REFERENCE)

H400 BASEMENT MECH PLAN (FOR REFERENCE)

H202 SECOND FLOOR HVAC PLAN (FOR REFERENCE)

I HEREBY CERTIFY THESE DRAWINGS AND/OR SPECIFICATIONS HAVE

CERTIFY. THAT TO THE BEST OF MY KNOWLEDGE. THESE DRAWINGS

AND/OR SPECIFICATIONS ARE AS REQUIRED BY AND IN COMPLIANCE

BEEN PREPARED BY ME. OR UNDER MY SUPERVISION. I FURTHER

WITH THE BUILDING CODES OF THE UNIVERSITY OF MISSOURI.

ARCHITECTURAL SHEETS-

H404 MEZZANINE MECHANICAL ROOM HVAC PLAN (FOR REFERENCE)

E1-2 FIRST LEVEL ELECTRICAL PLAN

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FOR REFERENCE ONLY

E0-3 SECOND LEVEL ELECTRICAL DEMO PLAN

M1-2 FIRST LEVEL MECHANICAL PLAN

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FP0-2 FIRST & SECOND LEVEL SPRINKLER DEMO PLAN

FP1-1 LOWER LEVEL AND MEZZANINE SPRINKLER PLAN

### ALL WORK BY ALL TRADES SHALL CONFORM TO AND BE COMPLETED IN ACCORDANCE WITH ALL APPLICABLE CODES, ORDINANCES, STANDARDS G0-0 COVER SHEET OR RESTRICTIONS WHETHER INDICATED ON THE DRAWINGS OR NOT. THE G0-1 CODE PLANS MORE STRINGENT TO GOVERN DISCREPANCIES BETWEEN CONTRACT G0-2 CODE CONTINUATION DOCUMENTS AND CODES SHALL BE BROUGHT TO THE ARCHITECTS G0-3 ACCESSIBILITY STANDARDS ATTENTION PROMPTLY AND RESOLUTION OBTAINED BEFORE G0-4 ACCESSIBILITY STANDARDS

THIS PROJECT WITHOUT DIRECT SUPERVISION OF WORK IN PROGRESS. IT IS NEITHER EXPRESSED NOR IMPLIED THAT THE CONTRACTOR CAN CONSTRUCT THIS PROJECT WITHOUT THE ARCHITECT'S FIELD OBSERVATIONS. IF FIELD CONDITIONS ARE UNCOVERED THAT REQUIRE A CHANGE OR ADDITIONAL INFORMATION THE ARCHITECT DOES NOT DELEGATE THEIR AUTHORITY TO ANYONE ELSE FOR DETERMINING THE

MEANING OF THESE PLANS OR SPECIFICATIONS THE CONTRACTOR SHALL VISIT THE SITE AND FAMILIARIZE THEMSELF WITH ALL SITE CONDITIONS. THE CONTRACTOR IS OBLIGATED TO INSPECT FOR EXISTING CONDITIONS

AND AVAILABLE INFORMATION PRIOR TO SUBMITTING A BID. ALL EXISTING CONDITIONS INDICATED ARE BASED UPON INFORMATION PROVIDED BY OTHERS. NOTIFY THE ARCHITECT IF EXISTING CONDITIONS DEVIATE SUBSTANTIALLY FROM THOSE INDICATED. FIELD VERIFY EXISTING CONDITIONS BY DETAILED INSPECTION PRIOR TO BEGINNING

THE CONTRACTOR SHALL FIELD VERIFY ALL DIMENSIONS AND LOCATIONS OF EXISTING CONDITIONS PRIOR TO THE START OF CONSTRUCTION. THE CONTRACTOR SHALL VERIFY LOCATIONS OF ALL EXISTING UTILITIES AND MAKE NEW CONNECTIONS ACCORDING TO LOCAL UTILITY COMPANY REQUIREMENTS.

EXISTING UNDERGROUND INSTALLATIONS SUCH AS WATER LINES. GAS LINES, SEWER LINES, TELEPHONE LINES, POWER LINES, AND BURIED STRUCTURES IN THE VICINITY OF THE WORK TO BE PERFORMED HERE UNDER ARE INDICATED ON THE DRAWINGS ONLY TO THE EXTENT SUCH INFORMATION HAS BEEN MADE AVAILABLE TO OR DISCOVERED BY THE ARCHITECT OR ENGINEERS IN PREPARING THE DRAWINGS. THERE IS NO GUARANTEE AS TO THE ACCURACY OR COMPLETENESS OF SUCH INFORMATION. ALL RESPONSIBILITY FOR THE ACCURACY AND COMPLETENESS THEREOF IS EXPRESSLY DISCLAIMED. THE CONTRACTOR SHALL BE RESPONSIBLE FOR LOCATING ALL EXISTING UNDERGROUND INSTALLATIONS. THIS INCLUDES SERVICE CONNECTIONS, IN ADVANCE OF EXCAVATING OR TRENCHING, BY CONTACTING THE OWNERS THEREOF AND PROSPECTING. THE CONTRACTOR SHALL USE THEIR OWN INFORMATION AND NOT RELY LIPON ANY INFORMATION SHOWN ON THE DRAWINGS CONCERNING EXISTING UNDERGROUND INSTALLATIONS ANY DELAY ADDITIONAL WORK OR EXTRA COST TO THE CONTRACTOR CAUSED BY OR RESULTING FROM DAMAGE TO EXISTING UNDERGROUND INSTALLATIONS SHALL NOT CONSTITUTE A CLAIM FOR EXTRA WORK, ADDITIONAL PAYMENT, OR

SEE INSTRUCTIONS TO BIDDERS INCLUDED IN PROJECT MANUAL FOR ALL KNOWN REQUIREMENTS FOR PERMITS, GOVERNMENTAL FEES, LICENSES AND INSPECTIONS.

DRAWINGS HEREIN ARE NOT ORGANIZED BY TRADE AND EACH CONTRACTOR AND SUB-CONTRACTOR IS REQUIRED TO REVIEW THE DRAWINGS AS A WHOLE AND PROVIDE ANY MISCELLANEOUS ITEMS. MATERIALS, AND WORK REQUIRED TO COMPLETE THE WORK AS SHOWN ON ALL DOCUMENTS. THIS REQUIREMENT APPLIES TO ALL TRADES. STRUCTURAL MECHANICAL ELECTRICAL AND PLUMBING REQUIREMENTS AND RELATED WORK ARE INDICATED THROUGHOUT THE SET OF DRAWINGS AND SHOULD BE REVIEWED WITH THE SPECIFIC MECHANICAL ELECTRICAL, PLUMBING AND STRUCTURAL DRAWINGS FOR OVERALL SCOPE OF WORK. THE CONTRACTOR SHALL PROVIDE AND PAY FOR LABOR, MATERIALS,

CONSTRUCTION EQUIPMENT, MACHINERY, TOOLS, UTILITIES, TRANSPORTATION FOR THE ABOVE MENTIONED, AND ANY OTHER FACILITIES OR SERVICES NECESSARY FOR THE PROPER EXECUTION AND COMPLETION OF THE WORK. THE CONTRACTOR SHALL CAREFULLY STUDY AND COMPARE THE CONSTRUCTION DOCUMENTS AND SPECIFICATIONS WITH THE INFORMATION FURNISHED BY THE OWNER AND IMMEDIATELY NOTIFY THE

DISCOVERED IN WRITING. 3. SHOULD A DISCREPANCY BETWEEN CONTRACT DOCUMENTS AND SPECIFICATIONS OCCUR THE CONTRACTOR SHOULD IMMEDIATELY NOTIFY THE ARCHITECT IN WRITING FOR RESOLUTION BEFORE PROCEEDING WITH WORK

ARCHITECT OF ANY ERRORS, INCONSISTENCIES, OR OMISSIONS

IF A MATERIAL CALL-OUT IS ABSENT FROM ANY DRAWING. DETAIL. OR SPECIFICATION IN THE DOCUMENTS THE CONTRACTOR SHALL REQUEST INFORMATION AND/OR CLARIFICATION FROM THE ARCHITECT IN WRITING PRIOR TO SUBMITTING A BID. FAILURE TO REQUEST INFORMATION AND/OR CLARIFICATION FROM THE ARCHITECT PRIOR TO BIDDING THE PROJECT WARRANTS THAT THE CONTRACTOR HAS THOROUGHLY REVIEWED THE DRAWINGS AND THEIR BID INCLUDES ADEQUATE FUNDS TO COMPLETE THE PROJECT AS REASONABLY INFERRED FROM THE

SPECIFICATIONS OR THE DRAWINGS THE COST FOR THE MORE EXPENSIVE OPTION INCLUDING, BUT NOT LIMITED TO, DETAILS INSTALLATIONS, PROCEDURES, CALL-OUTS, MATERIALS, SCHEDULES, OR SPECIFICATION SHALL BE USED IN THE CONTRACTOR'S BID PRICE FOR THE PROJECT. IF THROUGH CLARIFICATION THE LESSER COST OPTION APPLIES THEN THE CONTRACTOR SHALL ISSUE A COST CREDIT TO THE OWNER FOR THE ACTUAL COST DIFFERENCE PLUS CONTRACTOR MARKUP INCLUDING OVERHEAD AND PROFIT.

16. ALL DETAILS AND SECTIONS SHOWN ON THE DRAWINGS ARE INTENDED TO BE TYPICAL AND SHALL BE CONSTRUED TO APPLY TO SIMILAR CONDITIONS ELSEWHERE. IF A CONDITION EXISTS IN THE DRAWINGS WHERE THE APPLICABLE CONSTRUCTION DETAIL IS UNCLEAR THE CONTRACTOR SHALL REQUEST INFORMATION AND/OR CLARIFICATION FROM THE ARCHITECT IN WRITING PRIOR TO SUBMITTING THE BID FOR CONSTRUCTION OF THE PROJECT.

SPECIFICATIONS, MANUFACTURER'S PUBLISHED INSTRUCTIONS, OR, IF NO INSTRUCTIONS EXIST. INSTALL PER STANDARD INDUSTRY PRACTICE. 18. GUARANTEE ALL MATERIALS AND WORKMANSHIP FREE FROM DEFECTS

SUBSTANTIAL COMPLETION UNLESS OTHERWISE NOTED. 19. CORRECTION OF ANY DEFECTS SHALL BE COMPLETED WITHOUT ADDITIONAL CHARGE AND SHALL INCLUDE REPLACEMENT OR REPAIR OF ANY OTHER PHASE OF THE INSTALLATION WHICH MAY HAVE BEEN

IDENTIFIED IN AIA DOCUMENT A201 SHALL BE BINDING AS PART OF THESE 21. THE ARCHITECT AND THE ARCHITECT'S CONSULTANTS SHALL BE DEEMED THE AUTHORS AND OWNERS OF THEIR RESPECTIVE INSTRUMENTS OF SERVICE, INCLUDING THE DRAWINGS AND SPECIFICATIONS, AND SHALL

RETAIN ALL COMMON LAW, STATUTORY, AND OTHER RESERVED RIGHTS INCLUDING COPYRIGHTS SUBMISSION OR DISTRIBUTION OF INSTRUMENTS OF SERVICE TO MEET OFFICIAL REGULATORY REQUIREMENTS OR FOR SIMILAR PURPOSES IN CONNECTION WITH THE PROJECT IS NOT BE CONSTRUED AS PUBLICATION IN DEROGATION OF THE RESERVED RIGHTS OF THE ARCHITECT AND THE ARCHITECT'S CONSULTANTS.

DRAWINGS ARE NOT TO BE SCALED. DIMENSIONAL DATA SHALL BE OBTAINED FROM WRITTEN INFORMATION ONLY. VERIFY ALL DIMENSIONS BEFORE PROCEEDING. ANY DIMENSIONAL DEVIATION FROM THAT SHOWN ON THE DRAWINGS WHICH MAY AFFECT INTENT OF DESIGN OR PROPER INCORPORATION OF ELEMENTS SHALL BE BROUGHT TO THE ARCHITECT'S ATTENTION PROMPTLY IN WRITING AND RESOLUTION OBTAINED BEFORE PROCEEDING. NOTIFY ARCHITECT IMMEDIATELY OF ANY DIMENSIONAL VARIATIONS ON BETWEEN THE DRAWINGS AND BUILT CONDITIONS.

### PROJECT LOCATION MAP:



637 COLLEGE STREET SPRINGFIELD, MO 65806

PH: 417.885.0002

www.paragonarchitecture.com

MEP ENGINEER RTM ENGINEERING CONSULTANTS 3333 E. BATTLEFIELD RD, SUITE 1000 417.881.0020

**ELEVATOR CONSULTANT** 600 EMERSON RD. SUITE 225 CREVE COEUR, MISSOURI 6314

**CIVIL ENGINEER** ARCHER-ELGIN 310 E. 6TH STREET ROLLA, MISSOURI 65401 573.364.6362

> JARED A. JARED A. YOUNGLOVE, ARCHITECT MO #: A-2017019282

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REVISION SCHEDULE

7. APPLY AND/OR INSTALL ALL PRODUCTS AND MATERIALS ACCORDING TO


FOR A PERIOD OF NOT LESS THAN ONE (1) YEAR FROM DATE OF


20. GENERAL CONDITIONS OF THE CONTRACT FOR CONSTRUCTION AS CONSTRUCTION DOCUMENTS.

DRAWN BY: EBP, CSM, KS CHECKED BY: JY, EBP

PROJECT NUMBER: 22-703A RC000638

SHEET NUMBER:

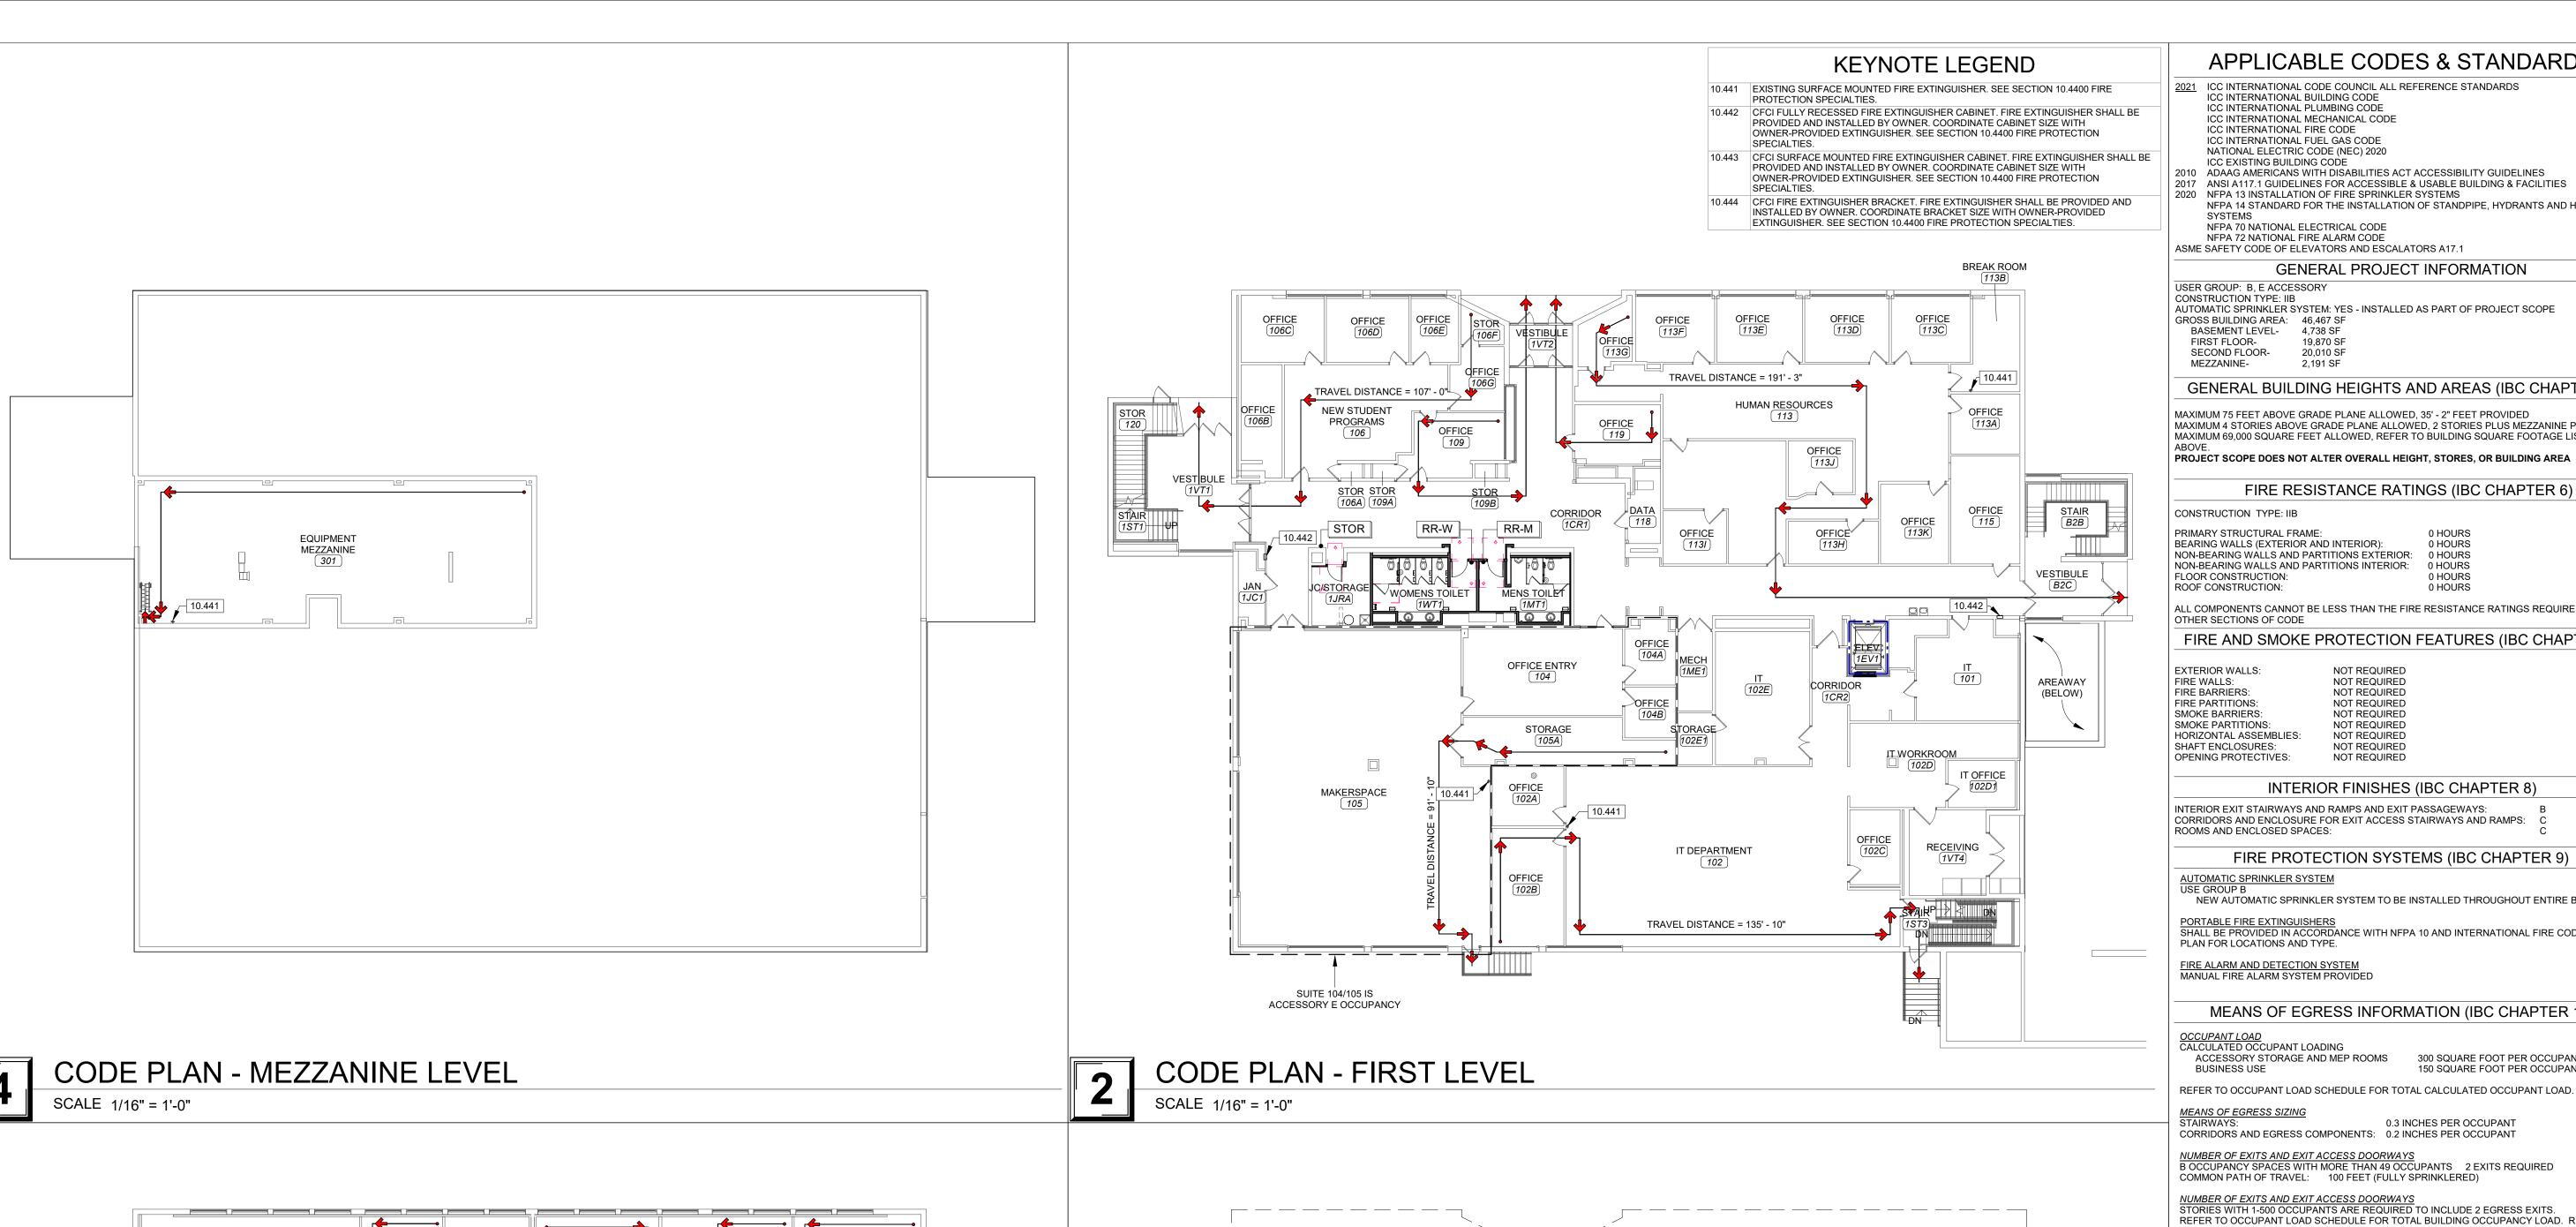

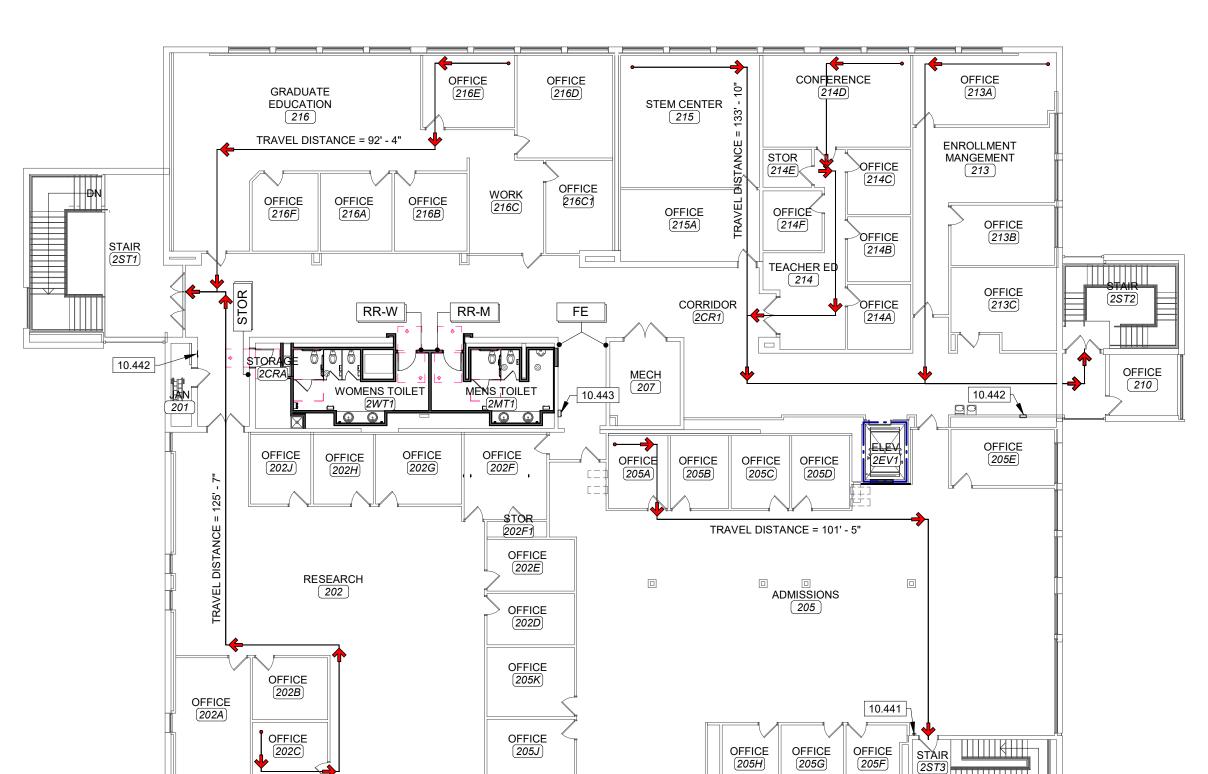

AREAWAY B0 STOR B3A STOR B3B STOR B3C

**CODE PLAN - LOWER LEVEL** 

APPLICABLE CODES & STANDARDS

2021 ICC INTERNATIONAL CODE COUNCIL ALL REFERENCE STANDARDS ICC INTERNATIONAL BUILDING CODE ICC INTERNATIONAL PLUMBING CODE

ICC INTERNATIONAL MECHANICAL CODE ICC INTERNATIONAL FIRE CODE ICC INTERNATIONAL FUEL GAS CODE NATIONAL ELECTRIC CODE (NEC) 2020

ICC EXISTING BUILDING CODE 2010 ADAAG AMERICANS WITH DISABILITIES ACT ACCESSIBILITY GUIDELINES 2017 ANSI A117.1 GUIDELINES FOR ACCESSIBLE & USABLE BUILDING & FACILITIES 2020 NFPA 13 INSTALLATION OF FIRE SPRINKLER SYSTEMS NFPA 14 STANDARD FOR THE INSTALLATION OF STANDPIPE, HYDRANTS AND HOSE

NFPA 70 NATIONAL ELECTRICAL CODE NFPA 72 NATIONAL FIRE ALARM CODE ASME SAFETY CODE OF ELEVATORS AND ESCALATORS A17.1

GENERAL PROJECT INFORMATION USER GROUP: B, E ACCESSORY CONSTRUCTION TYPE: IIB AUTOMATIC SPRINKLER SYSTEM: YES - INSTALLED AS PART OF PROJECT SCOPE GROSS BUILDING AREA: 46,467 SF

BASEMENT LEVEL- 4,738 SF 19.870 SF SECOND FLOOR-20,010 SF

GENERAL BUILDING HEIGHTS AND AREAS (IBC CHAPTER 5)

MAXIMUM 75 FEET ABOVE GRADE PLANE ALLOWED, 35' - 2" FEET PROVIDED MAXIMUM 4 STORIES ABOVE GRADE PLANE ALLOWED, 2 STORIES PLUS MEZZANINE PROVIDED MAXIMUM 69,000 SQUARE FEET ALLOWED, REFER TO BUILDING SQUARE FOOTAGE LISTED

### FIRE RESISTANCE RATINGS (IBC CHAPTER 6)

CONSTRUCTION TYPE: IIB

PRIMARY STRUCTURAL FRAME: BEARING WALLS (EXTERIOR AND INTERIOR): 0 HOURS NON-BEARING WALLS AND PARTITIONS EXTERIOR: 0 HOURS NON-BEARING WALLS AND PARTITIONS INTERIOR: 0 HOURS FLOOR CONSTRUCTION: 0 HOURS ROOF CONSTRUCTION: 0 HOURS

ALL COMPONENTS CANNOT BE LESS THAN THE FIRE RESISTANCE RATINGS REQUIRED BY OTHER SECTIONS OF CODE

FIRE AND SMOKE PROTECTION FEATURES (IBC CHAPTER 7) NOT REQUIRED

NOT REQUIRED NOT REQUIRED NOT REQUIRED NOT REQUIRED NOT REQUIRED HORIZONTAL ASSEMBLIES: NOT REQUIRED SHAFT ENCLOSURES: NOT REQUIRED NOT REQUIRED **OPENING PROTECTIVES:** 

### INTERIOR FINISHES (IBC CHAPTER 8)

INTERIOR EXIT STAIRWAYS AND RAMPS AND EXIT PASSAGEWAYS: CORRIDORS AND ENCLOSURE FOR EXIT ACCESS STAIRWAYS AND RAMPS: ROOMS AND ENCLOSED SPACES:

### FIRE PROTECTION SYSTEMS (IBC CHAPTER 9)

NEW AUTOMATIC SPRINKLER SYSTEM TO BE INSTALLED THROUGHOUT ENTIRE BUILDING

PORTABLE FIRE EXTINGUISHERS
SHALL BE PROVIDED IN ACCORDANCE WITH NFPA 10 AND INTERNATIONAL FIRE CODE. SEE PLAN FOR LOCATIONS AND TYPE.

### FIRE ALARM AND DETECTION SYSTEM MANUAL FIRE ALARM SYSTEM PROVIDED

MEANS OF EGRESS INFORMATION (IBC CHAPTER 10)

OCCUPANT LOAD
CALCULATED OCCUPANT LOADING

ACCESSORY STORAGE AND MEP ROOMS 300 SQUARE FOOT PER OCCUPANT 150 SQUARE FOOT PER OCCUPANT

REFER TO OCCUPANT LOAD SCHEDULE FOR TOTAL CALCULATED OCCUPANT LOAD.

0.3 INCHES PER OCCUPANT

NUMBER OF EXITS AND EXIT ACCESS DOORWAYS
B OCCUPANCY SPACES WITH MORE THAN 49 OCCUPANTS 2 EXITS REQUIRED COMMON PATH OF TRAVEL: 100 FEET (FULLY SPRINKLERED)

NUMBER OF EXITS AND EXIT ACCESS DOORWAYS
STORIES WITH 1-500 OCCUPANTS ARE REQUIRED TO INCLUDE 2 EGRESS EXITS.
REFER TO OCCUPANT LOAD SCHEDULE FOR TOTAL BUILDING OCCUPANCY LOAD. REFER TO CODE PLANS FOR OCCUPANT LOAD PER SPACE AND LEVEL.

EXIT AND EXIT ACCESS DOORWAY CONFIGURATION
EXITS SHALL BE PLACED A DISTANCE APART EQUAL TO NOT LESS THAN ONE THIRD (1/3) OF THE LENGTH OF THE MAXIMUM OVERALL DIAGONAL DIMENSION OF THE BUILDING OR AREA TO BE SERVED MEASURED IN A STRAIGHT LINE BETWEEN THEM.

EXIT ACCESS TRAVEL DISTANCE
SHALL NOT EXCEED 300 FEET IN PROVIDED OCCUPANCY GROUPS.

<u>CORRIDORS</u>
WALLS IN OCCUPANCY GROUP B SERVING MORE THAN 30 OCCUPANTS SHALL BE FIRE

RESISTANT RATED 0 HOUR (FULLY SPRINKLERED) REQUIRED CAPACITY OF CORRIDORS SHALL NOT BE LESS THAN 44". DEAD END CORRIDORS SHALL BE LIMITED TO 50 FEET IN LENGTH (FULLY SPRINKLERED)

### PLUMBING SYSTEMS (IBC CHAPTER 29)

WATER CLOSETS REQUIRED: 14 PROVIDED BUSINESS: 1 PER 25 FIRST 50, 1 PER 50 REMAINDER - 5.44 REQUIRED

EDUCATION: 1 PER 50 - 2.86 REQUIRED

LAVATORIES REQUIRED: 7 REQUIRED 8 PROVIDED BUSINESS: 1 PER 40 FIRST 80, 1 PER 80 REMAINDER - 3.78 REQUIRED

EDUCATION: 1 PER 50 - 2.86 REQUIRED DRINKING FOUNTAINS REQUIRED: 4 REQUIRED BUSINESS: 1 PER 100 - 2.22 REQUIRED

EDUCATION: 1 PER 100 - 1.43 REQUIRED SERVICE SINKS REQUIRED: 2 REQUIRED 2 PROVIDED

### **DEFERRED SUBMITTAL LIST**

THE FOLLOWING LIST OF SUBMITTALS ARE SUBMITTALS THAT THE DESIGN TEAM RECOGNIZES REQUIRE SUBMISSION TO THE AUTHORITY HAVING JURISDICTION FOR REVIEW THAT ARE NOT AVAILABLE BEFORE CONTRACTOR INVOLVEMENT AND/OR CREATION. THE FOLLOWING WILL BE SUBMITTED TO THE AUTHORITY HAVING JURISDICTION DURING CONSTRUCTION FOR REVIEW AND APPROVAL BEFORE CONSTRUCTION OF THE ASSOCIATED BUILDING ELEMENTS.

AUTOMATIC FIRE SUPPRESSION SYSTEM HYDRAULIC ELEVATORS

### FIRE RESISTANCE RATING LEGEND

637 COLLEGE STREET SPRINGFIELD, MO 65806 PH: 417.885.0002

www.paragonarchitecture.com

MEP ENGINEER 3333 E. BATTLEFIELD RD, SUITE 1000 SPRINGFIELD, MISSOURI 65804

417.881.0020 **ELEVATOR CONSULTANT** 600 EMERSON RD SUITE 225

CREVE COEUR, MISSOURI 63141 314.441.3999 **CIVIL ENGINEER** ARCHER-ELGIN 310 E. 6TH STREET ROLLA, MISSOURI 65401 573.364.6362

> JARED A. YOUNGLOVE NUMBER A-2017019282 JARED A. YOUNGLOVE, ARCHITECT MO #: A-2017019282

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REVISION SCHEDULE

IMPROV

PROJECT ARCHITECT: JY DRAWN BY: CHECKED BY:

PROJECT NUMBER: 22-703A

RC000638 DATE:

**CODE PLANS** 

08/28/2023

SHEET NUMBER:

**G0-1** 

**CODE PLAN - SECOND LEVEL** SCALE 1/16" = 1'-0"

THIS WORK IS PROTECTED UNDER U.S. COPYRIGHT LAW AND THE ARCHITECT AGREEMENT (CONSTRUCT ON FILE), OR 5% OF THE COST OF CONSTRUCTION MINIMUM IF CONTRACT IS INPLIED CONSTRUCT SO F THESE DROUMENTS FER FAILURE TO COMPENSATE PARAGON ARCHITECTURE FOR THESE DROUMENTS FOR THE USE OF THESE DOCUMENTS OF THE USE OF THESE DROUMENTS OF THE USE OF THESE DOCUMENTS OF THE USE OF THESE DROUMENTS OF THE USE OF THESE DOCUMENTS OF THE USE OF THESE DROUMENTS OF THE USE OF THESE DOCUMENTS OF THE USE OF THESE DROUMENTS OF THE USE OF THE


-HOUR FIRE RESISTANCE RATING


### PANEL SIGNAGE LEGEND

- . PROVIDE THE FOLLOWING PANEL SIGNS AS INDICATED ON THE CODE PLANS. 2. INSTALL SIGNS (HEIGHTS AND LOCATIONS) AS DIRECTED BY OWNER'S REPRESENTATIVE. SIGNS TO BE PLACED 48" ABOVE FINISH FLOOR AT MINIMUM AND PLACED 60" ABOVE FINISH FLOOR AT MAXIMUM.
- . PROVIDE TACTILE EXIT SIGNAGE AT EACH EXIT DOOR COMPLIANT WITH THE APPLICABLE IBC VERSION, ANSI 117.1. AND AS IDENTIFIED UNDER OTHER APPLICABLE CODES. COLOR OF PANEL SIGNAGE TO BE SELECTED BY ARCHITECT PRIOR TO FABRICATION FROM MANUFACTURER
- STANDARD LINE OF COLORS. 5. SIGNS SHALL BE ONE PIECE CONSTRUCTION WITH THE EXCEPTION OF APPLIED VINYL LETTERS AND CHARACTERS.
- 6. ALL SIGNAGE TO BE ADA AND ANSI COMPLIANT.
  7. ALL SIGNAGE TO BE 1/8" THICK COLORED ACRYLIC WITH COLORED MATTE FINISH.
  8. ALL SIGNAGE EDGES TO BE POLISHED.
- 9. CHARACTERS TO BE CUT VINYL APPLIED. COLOR OF CHARACTERS TO BE SELECTED BY ARCHITECT FROM MANUFACTURER STANDARD LINE OF COLORS. 10. LETTERS TO BE 3/4" CUT VINYL APPLIED. LETTERS TO BE A FONT AND COLOR SELECTED BY ARCHITECT
- FROM MANUFACTURERS STANDARD LINE OF COLORS. 11. ALL ROOM DESIGNATIONS ARE TO BE PROVIDED BY OWNER.
- 12. PROVIDE RAISED BRAILLE CHARACTERS ON ALL PANEL SIGNS.
- 13. SEE SPECIFICATIONS FOR MORE INFORMATION. 14. SEE FINISH FLOOR PLANS FOR ANY ADDITIONAL NON-CODE RELATED SIGNAGE.

### PANEL SIGNAGE TAGS

PROVIDE ONE (1) SIGN PER \_\_\_\_\_COMPLYING WITH ADA LOCAL CODE. SIGN TO HAVE RAISED CHARACTERS AND PICTORIAL SYMBOL OF ACCESSIBILITY IN ACCORDANCE WITH ANSI AND ADA GUIDELINES. SIGN FINISHES TO BE SELECTED BY A.O.R.

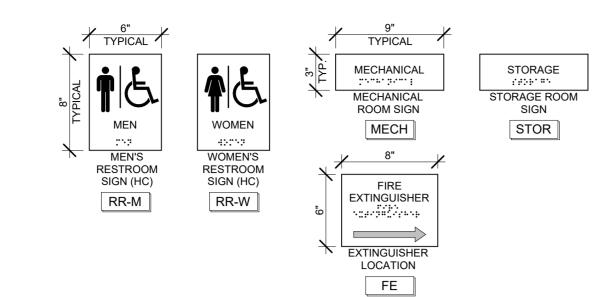

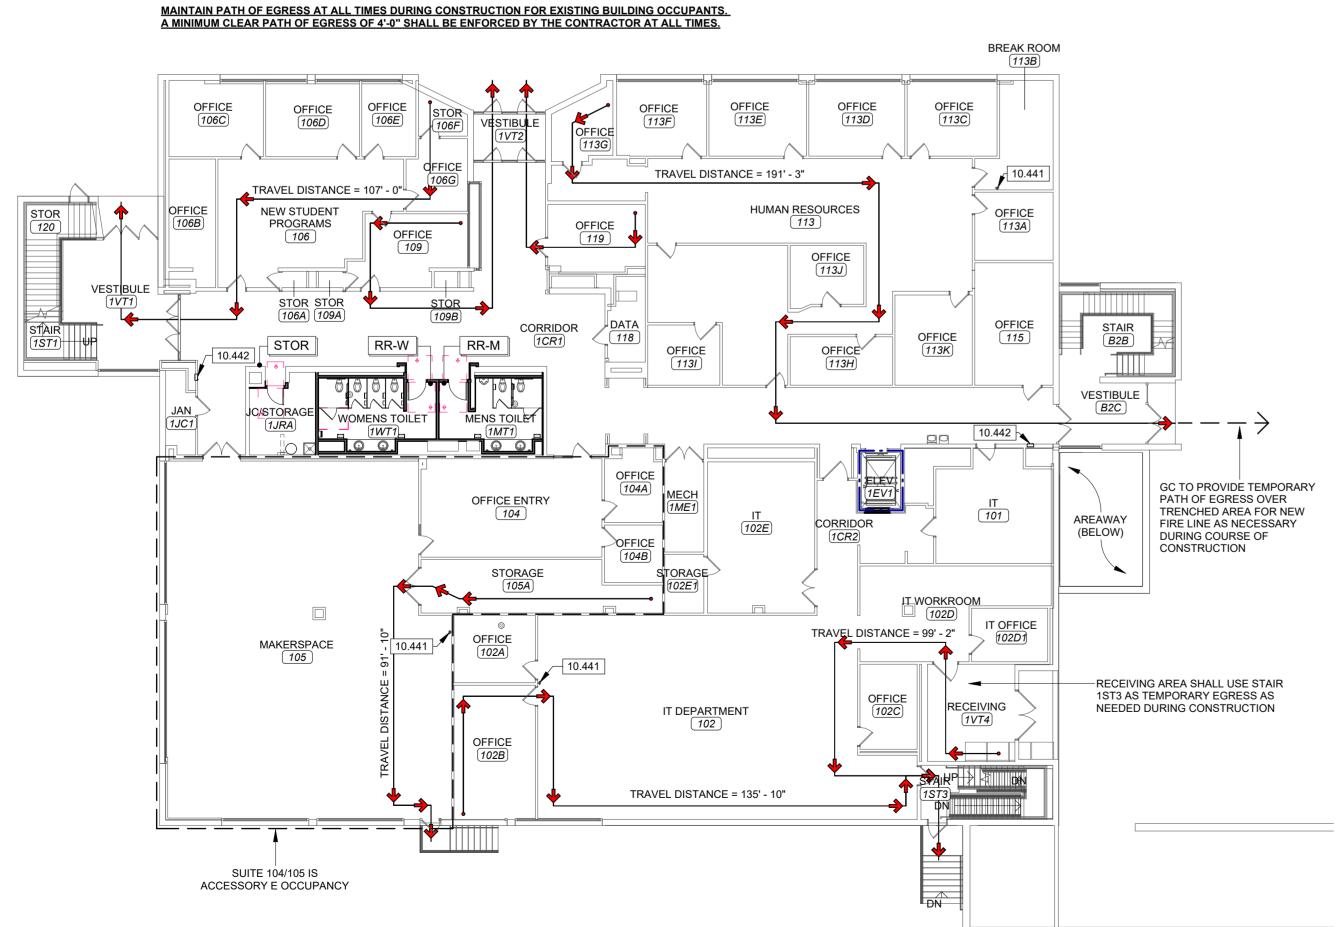

	ROOM INFORMATIO		IBC CHAPTER 10		
				OCCUPANT LOAD	OCCUPAN <sup>*</sup>
NO. WER LE	NAME	AREA	FUNCTION OF SPACE	FACTOR	COUNT
B0 B1	AREAWAY STOR		UNOCCUPIED ACCESSORY STORAGE AREAS, MECHANICAL EQUIPMENT ROOM	0 SF 300 SF	
B2 B2A	MECH MACHINE		ACCESSORY STORAGE AREAS, MECHANICAL EQUIPMENT ROOM ACCESSORY STORAGE AREAS, MECHANICAL EQUIPMENT ROOM	300 SF 300 SF	
B3A B3B	STOR STOR		ACCESSORY STORAGE AREAS, MECHANICAL EQUIPMENT ROOM ACCESSORY STORAGE AREAS, MECHANICAL EQUIPMENT ROOM	300 SF 300 SF	
B3C BCR1	STOR CORR		ACCESSORY STORAGE AREAS, MECHANICAL EQUIPMENT ROOM UNOCCUPIED	300 SF 0 SF	
BEV1 BST1	ELEV STAIR		UNOCCUPIED UNOCCUPIED	0 SF 0 SF	
BVT1	VEST		UNOCCUPIED	0 SF	
1CR1 1CR2	CORRIDOR CORRIDOR		UNOCCUPIED UNOCCUPIED	0 SF 0 SF	
1EV1 1JC1	ELEV JAN	58 SF	UNOCCUPIED ACCESSORY STORAGE AREAS, MECHANICAL EQUIPMENT ROOM	0 SF 300 SF	
1JRA 1ME1	JC/STORAGE MECH	134 SF	ACCESSORY STORAGE AREAS, MECHANICAL EQUIPMENT ROOM ACCESSORY STORAGE AREAS, MECHANICAL EQUIPMENT ROOM	300 SF 300 SF	
1MT1 1ST1	MENS TOILET STAIR	182 SF	UNOCCUPIED UNOCCUPIED	0 SF 0 SF	
1ST3 1VT1	STAIR VESTIBULE	198 SF	UNOCCUPIED UNOCCUPIED	0 SF 0 SF	
1VT2 1VT4	VESTIBULE VESTIBULE RECEIVING	90 SF	UNOCCUPIED	0 SF 300 SF	
1WT1	WOMENS TOILET	212 SF	ACCESSORY STORAGE AREAS, MECHANICAL EQUIPMENT ROOM UNOCCUPIED	0 SF	
101	IT DEPARTMENT	1,973 SF	BUSINESS AREAS - IBC 2018 AND LATER BUSINESS AREAS - IBC 2018 AND LATER BUSINESS AREAS - IBC 2018 AND LATER	150 SF 150 SF	
102A 102B	OFFICE OFFICE	303 SF	BUSINESS AREAS - IBC 2018 AND LATER BUSINESS AREAS - IBC 2018 AND LATER	150 SF 150 SF	
102C 102D	OFFICE IT WORKROOM	377 SF	BUSINESS AREAS - IBC 2018 AND LATER BUSINESS AREAS - IBC 2018 AND LATER	150 SF 150 SF	
102D1 102E	IT OFFICE IT	446 SF	BUSINESS AREAS - IBC 2018 AND LATER BUSINESS AREAS - IBC 2018 AND LATER	150 SF 150 SF	
102E1 104	STORAGE OFFICE ENTRY	491 SF	ACCESSORY STORAGE AREAS, MECHANICAL EQUIPMENT ROOM BUSINESS AREAS - IBC 2018 AND LATER	300 SF 150 SF	
104A 104B	OFFICE OFFICE		BUSINESS AREAS - IBC 2018 AND LATER BUSINESS AREAS - IBC 2018 AND LATER	150 SF 150 SF	
105 105A	MAKERSPACE STORAGE	2,690 SF	EDUCATIONAL - CLASSROOM AREA ACCESSORY STORAGE AREAS, MECHANICAL EQUIPMENT ROOM	20 SF 300 SF	
106 106A	NEW STUDENT PROGRAMS STOR	525 SF	BUSINESS AREAS - IBC 2018 AND LATER ACCESSORY STORAGE AREAS, MECHANICAL EQUIPMENT ROOM	150 SF 300 SF	
106B 106C	OFFICE OFFICE	157 SF	BUSINESS AREAS - IBC 2018 AND LATER BUSINESS AREAS - IBC 2018 AND LATER	150 SF 150 SF	
106C 106D 106E	OFFICE OFFICE	189 SF	BUSINESS AREAS - IBC 2018 AND LATER BUSINESS AREAS - IBC 2018 AND LATER BUSINESS AREAS - IBC 2018 AND LATER	150 SF 150 SF	
106E 106F 106G	STOR OFFICE	46 SF	ACCESSORY STORAGE AREAS, MECHANICAL EQUIPMENT ROOM BUSINESS AREAS - IBC 2018 AND LATER	300 SF 150 SF	
109	OFFICE	205 SF	BUSINESS AREAS - IBC 2018 AND LATER	150 SF 300 SF	
109A 109B	STOR STOR	11 SF	ACCESSORY STORAGE AREAS, MECHANICAL EQUIPMENT ROOM ACCESSORY STORAGE AREAS, MECHANICAL EQUIPMENT ROOM	300 SF	
113 113A	HUMAN RESOURCES OFFICE	148 SF	BUSINESS AREAS - IBC 2018 AND LATER BUSINESS AREAS - IBC 2018 AND LATER	150 SF 150 SF	
113B 113C	BREAK ROOM OFFICE	188 SF	BUSINESS AREAS - IBC 2018 AND LATER BUSINESS AREAS - IBC 2018 AND LATER	150 SF 150 SF	
113D 113E	OFFICE OFFICE		BUSINESS AREAS - IBC 2018 AND LATER BUSINESS AREAS - IBC 2018 AND LATER	150 SF 150 SF	
113F 113G	OFFICE OFFICE		BUSINESS AREAS - IBC 2018 AND LATER BUSINESS AREAS - IBC 2018 AND LATER	150 SF 150 SF	
113H 113I	OFFICE OFFICE		BUSINESS AREAS - IBC 2018 AND LATER BUSINESS AREAS - IBC 2018 AND LATER	150 SF 150 SF	
113J 113K	OFFICE OFFICE		BUSINESS AREAS - IBC 2018 AND LATER BUSINESS AREAS - IBC 2018 AND LATER	150 SF 150 SF	
115 118	OFFICE DATA		BUSINESS AREAS - IBC 2018 AND LATER ACCESSORY STORAGE AREAS, MECHANICAL EQUIPMENT ROOM	150 SF 300 SF	
119 120	OFFICE STOR	177 SF	BUSINESS AREAS - IBC 2018 AND LATER ACCESSORY STORAGE AREAS, MECHANICAL EQUIPMENT ROOM	150 SF 300 SF	
B2B B2C	STAIR VESTIBULE	286 SF	UNOCCUPIED UNOCCUPIED	0 SF 0 SF	
COND L			UNOCCUPIED	0 SF	
2CRA 2EV1	STORAGE ELEV	78 SF	ACCESSORY STORAGE AREAS, MECHANICAL EQUIPMENT ROOM UNOCCUPIED	300 SF 0 SF	
2MT1 2ST1	MENS TOILET STAIR	208 SF	UNOCCUPIED UNOCCUPIED	0 SF 0 SF	
2ST2 2ST3	STAIR STAIR STAIR	290 SF	UNOCCUPIED UNOCCUPIED	0 SF 0 SF	
2WT1	WOMENS TOILET	214 SF	UNOCCUPIED	0 SF	
201	JAN RESEARCH	1,987 SF	ACCESSORY STORAGE AREAS, MECHANICAL EQUIPMENT ROOM BUSINESS AREAS - IBC 2018 AND LATER	300 SF 150 SF	
202A 202B	OFFICE OFFICE	130 SF	BUSINESS AREAS - IBC 2018 AND LATER BUSINESS AREAS - IBC 2018 AND LATER	150 SF 150 SF	
202C 202D	OFFICE OFFICE	125 SF	BUSINESS AREAS - IBC 2018 AND LATER BUSINESS AREAS - IBC 2018 AND LATER	150 SF 150 SF	
202E 202F	OFFICE OFFICE		BUSINESS AREAS - IBC 2018 AND LATER BUSINESS AREAS - IBC 2018 AND LATER	150 SF 150 SF	
202F1 202G	STOR OFFICE		ACCESSORY STORAGE AREAS, MECHANICAL EQUIPMENT ROOM BUSINESS AREAS - IBC 2018 AND LATER	300 SF 150 SF	
202H 202J	OFFICE OFFICE	116 SF	BUSINESS AREAS - IBC 2018 AND LATER BUSINESS AREAS - IBC 2018 AND LATER	150 SF 150 SF	
205 205A	ADMISSIONS OFFICE	3,376 SF	BUSINESS AREAS - IBC 2018 AND LATER BUSINESS AREAS - IBC 2018 AND LATER	150 SF 150 SF	
205B 205C	OFFICE OFFICE	118 SF	BUSINESS AREAS - IBC 2018 AND LATER BUSINESS AREAS - IBC 2018 AND LATER BUSINESS AREAS - IBC 2018 AND LATER	150 SF 150 SF 150 SF	
205D 205E	OFFICE OFFICE	117 SF	BUSINESS AREAS - IBC 2018 AND LATER BUSINESS AREAS - IBC 2018 AND LATER BUSINESS AREAS - IBC 2018 AND LATER	150 SF 150 SF	
205E 205F 205G	OFFICE OFFICE	101 SF	BUSINESS AREAS - IBC 2018 AND LATER BUSINESS AREAS - IBC 2018 AND LATER BUSINESS AREAS - IBC 2018 AND LATER	150 SF 150 SF	
205H	OFFICE	103 SF	BUSINESS AREAS - IBC 2018 AND LATER	150 SF	
205J 205K	OFFICE OFFICE	168 SF	BUSINESS AREAS - IBC 2018 AND LATER BUSINESS AREAS - IBC 2018 AND LATER BUSINESS AREAS - IBC 2018 AND LATER	150 SF 150 SF	
210	MECH OFFICE ENDOLLMENT MANGEMENT	118 SF	BUSINESS AREAS - IBC 2018 AND LATER BUSINESS AREAS - IBC 2018 AND LATER BUSINESS AREAS - IBC 2018 AND LATER	150 SF 150 SF	
213 213A	OFFICE	276 SF	BUSINESS AREAS - IBC 2018 AND LATER BUSINESS AREAS - IBC 2018 AND LATER BUSINESS AREAS - IBC 2018 AND LATER	150 SF 150 SF	
213B 213C	OFFICE OFFICE	218 SF	BUSINESS AREAS - IBC 2018 AND LATER BUSINESS AREAS - IBC 2018 AND LATER BUSINESS AREAS - IBC 2018 AND LATER	150 SF 150 SF	
214 214A	TEACHER ED OFFICE	114 SF	BUSINESS AREAS - IBC 2018 AND LATER BUSINESS AREAS - IBC 2018 AND LATER	150 SF 150 SF	
214B 214C	OFFICE OFFICE	113 SF	BUSINESS AREAS - IBC 2018 AND LATER BUSINESS AREAS - IBC 2018 AND LATER	150 SF 150 SF	
214D 214E	CONFERENCE STOR	51 SF	BUSINESS AREAS - IBC 2018 AND LATER ACCESSORY STORAGE AREAS, MECHANICAL EQUIPMENT ROOM	150 SF 300 SF	
214F 215	OFFICE STEM CENTER	98 SF	BUSINESS AREAS - IBC 2018 AND LATER BUSINESS AREAS - IBC 2018 AND LATER	150 SF 150 SF	
215A	OFFICE GRADUATE EDUCATION	277 SF	BUSINESS AREAS - IBC 2018 AND LATER BUSINESS AREAS - IBC 2018 AND LATER	150 SF 150 SF	
216	OFFICE OFFICE	155 SF	BUSINESS AREAS - IBC 2018 AND LATER BUSINESS AREAS - IBC 2018 AND LATER	150 SF 150 SF	
		107 01			
216 216A 216B 216C	WORK		BUSINESS AREAS - IBC 2018 AND LATER BUSINESS AREAS - IBC 2018 AND LATER	150 SF	
216 216A 216B		170 SF 272 SF	BUSINESS AREAS - IBC 2018 AND LATER	150 SF 150 SF 150 SF 150 SF	

OCCUPANT LOAD											
USE GROUP OCCUPANT COUNT											
В	222										
E - CLASS	143										



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**ELEVATOR CONSULTANT** ATIS 600 EMERSON RD, SUITE 225

CREVE COEUR, MISSOURI 63141 314.441.3999 **CIVIL ENGINEER** ARCHER-ELGIN 310 E. 6TH STREET ROLLA, MISSOURI 65401

> JARED A. YOUNGLOVE NUMBER

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TENNIAL HALL IMPROVEMEN

PROJECT ARCHITECT: JY DRAWN BY: EBP, CSM, KS

JY, EBP

PROJECT NUMBER: 22-703A RC000638

CHECKED BY:

08/28/2023

CODE CONTINUATION

SHEET NUMBER:

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310 E. 6TH STREET


ROLLA, MISSOURI 65401 573.364.6362

> YOUNGLOVE JARED A. YOUNGLOVE, ARCHITECT MO #: A-2017019282

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ACCESSIBLE LAVATORY SCALE 3/8" = 1'-0"

1. COUNTERTOP MOUNTED LAVATORIES ARE TO BE MOUNTED WITH SAME

3. IF OPTIONAL VANITY BASE COVER IS NOT INSTALLED, A PVC PTRAP IS

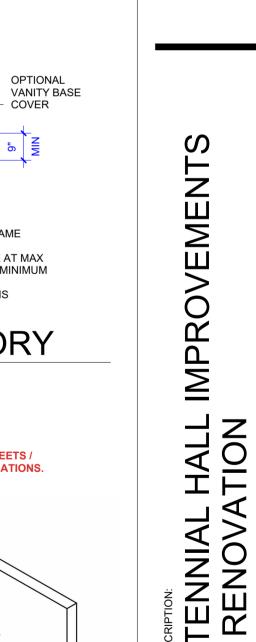2. FOR CHILDREN THE LAVATORY RIM/COUNTERTOP HEIGHT SHALL BE AT MAX


31" FOR AGES 6-12 AND KNEE CLEARANCE BELOW SINK SHALL BE A MINIMUM

REQUIRED CLEAR FLOOR SPACE

30" MAX

CLEARANCES, REQUIREMENTS, ETC.

DETAILS ARE FOR REFERENCE ONLY, SEE A1 SERIES SHEETS / SPECIFICATIONS FOR EXACT MODELS AND MOUNTING LOCATIONS.

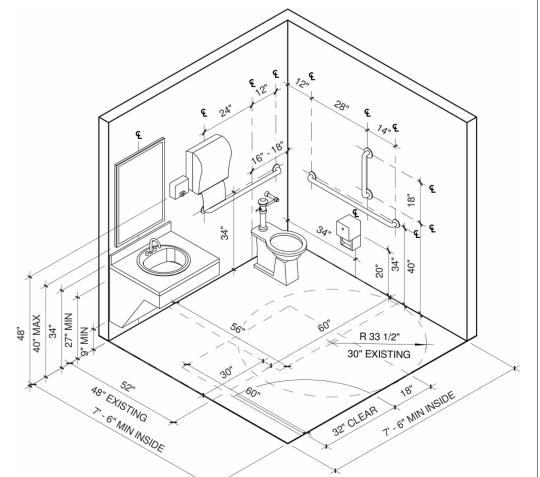

1. REFER TO GRAB BAR DETAILS FOR MOUNTING HRIGHTS AND SIZES REFER TO PLAN FOR ADDITIONAL DOOR INFORMATION
 REFER TO VANITY DETAIL FOR ADDITIONAL VANITY INFORMATION

SHEET NUMBER: **G0-3** 

PROJECT ARCHITECT: JY

EBP, CSM, KS

JY, EBP

DRAWN BY:

22-703A

RC000638

08/28/2023

**ACCESSIBILITY** 

STANDARDS


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CLEARANCE FOR WATER CLOSET ADA RESTROOM - SINGLE THIS WORK IS PROTECTED UNDER U.S. COPYRIGHT LAW AND THE ARCHITECTURAL WORKS COPYRIGHT PROTECTION ACT OF 1990. FAILURE TO COMPENSATE PARAGON ARCHITECT CONSTITUTES OF THESE DOCUMENTS AFTER FAILURE TO COMPENSATE INFLIGHED CONTRACT AND THE LOSS OF PERMISSION TO USE THESE DOCUMENTS AFTER FAILURE TO COMPENSATE PARAGON ARCHITECT AGREEMENT (CONSTITUTES OF THESE DOCUMENTS AFTER FAILURE TO COMPENSATE THE LOSS OF PERMISSION TO USE THESE DOCUMENTS AFTER FAILURE TO COMPENSATE THE LOSS OF PERMISSION TO USE THESE DOCUMENTS AFTER FAILURE TO COMPENSATE THE LOSS OF PERMISSION TO USE THESE DOCUMENTS AFTER FAILURE TO COMPENSATE THE LOSS OF PERMISSION TO USE THESE DOCUMENTS AFTER FAILURE TO COMPENSATE THE LOSS OF PERMISSION TO USE THESE DOCUMENTS AFTER FAILURE TO COMPENSATE THE LOSS OF PERMISSION TO USE THESE DOCUMENTS AFTER FAILURE TO COMPENSATE THE LOSS OF PERMISSION TO USE THESE DOCUMENTS AFTER FAILURE TO COMPENSATE THE LOSS OF PERMISSION TO USE THESE DOCUMENTS AFTER FAILURE TO COMPENSATE THE LOSS OF PERMISSION TO USE THESE DOCUMENTS AFTER FAILURE TO COMPENSATE THE LOSS OF PERMISSION TO USE THESE DOCUMENTS AFTER FAILURE TO COMPENSATE THE LOSS OF PERMISSION TO USE THESE DOCUMENTS AFTER FAILURE TO COMPENSATE THE LOSS OF PERMISSION TO USE THE LOSS OF THE LOSS O



ACCESSIBLE RESTROOM ACCESSORIES




NOTE:

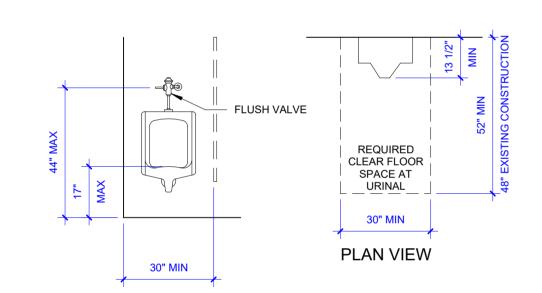1. A MIN OF ONE URINAL PER EACH MEN'S ACCESSIBLE RESTROOM SHALL BE MOUNTED AT 17" HEIGHT IF MORE THAN ONE URINAL IS PROVIDED.


WEIGHT SHALL BE 36" MAY FOR AGES 3-4: 40" MAX FOR AGES 1.1. A MIN FOR AG 2. FLUSH CONTROL HEIGHT SHALL BE 36" MAX FOR AGES 3-4; 40" MAX FOR AGES 5-8; AND 44" FOR AGES 9 AND UP. 3. SEE PLANS FOR ADDITION INFORMATION ON URINAL SCREEN LOCATIONS

ACCESSIBLE URINAL

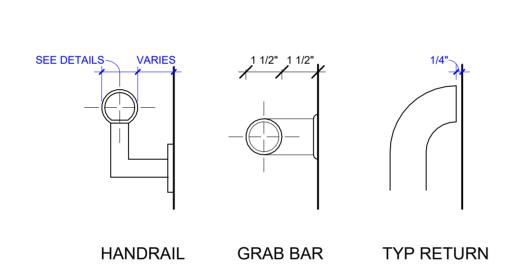


. GRAB BAR SHALL BE DESIGNED TO WITHSTAND A 250LB. LOAD. COORDINATE NECESSARY BLOCKING IN WALL WITH FRAMING CONTRACTOR. 2. HANDRAILS SHALL BE SPACED 2 1/4" AWAY FROM WALL FOR STAIRS AND 1 1/2" FOR RAMPS. SEE HANDRAIL DETAIL FOR MOUNTING HEIGHT.

ADA GRAB BARS /HANDRAILS

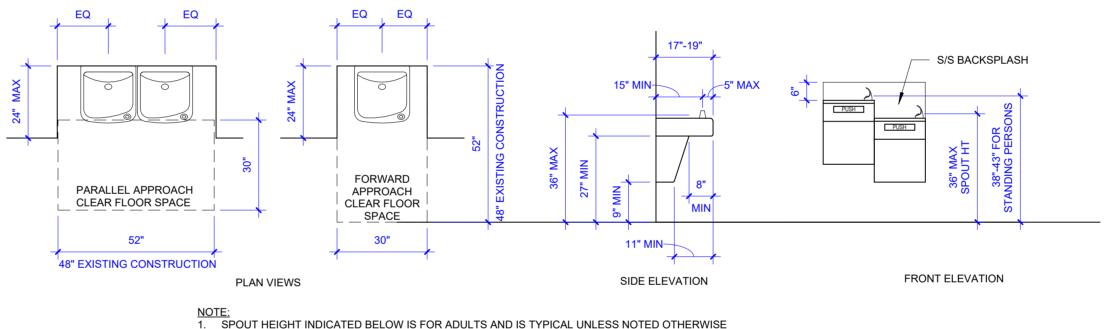


1. SPOUT HEIGHT INDICATED BELOW IS FOR ADULTS AND IS TYPICAL UNLESS NOTED OTHERWISE
2. SPOUT HEIGHT FOR CHILDREN'S USE SHALL BE 30" MAX WITH A PARALLEL APPROACH ONLY
3. DOUBLE HEIGHT DRINKING FOUNTAIN UNLESS OTHERWISE SPECIFIED, SINGLE UNIT SPOUT HEIGHT SHALL BE 36" A.F.F. 4. FOUNTAIN CANNOT BE PLACED IN EGRESS PATH, PROVIDE ALCOVE AND RECESS FOUNTAIN

ADA DRINKING FOUNTAIN

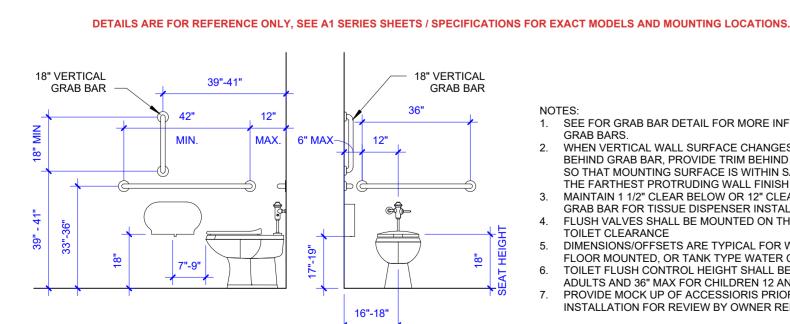

1. SEE FOR GRAB BAR DETAIL FOR MORE INFORMATION ON WHEN VERTICAL WALL SURFACE CHANGES IN PLANE BEHIND GRAB BAR, PROVIDE TRIM BEHIND BAR MOUNTING SO THAT MOUNTING SURFACE IS WITHIN SAME PLANE AS THE FARTHEST PROTRUDING WALL FINISH MATERIAL. MAINTAIN 1 1/2" CLEAR BELOW OR 12" CLEAR ABOVE THE GRAB BAR FOR TISSUE DISPENSER INSTALLATION FLUSH VALVES SHALL BE MOUNTED ON THE WIDE SIDE OF DIMENSIONS/OFFSETS ARE TYPICAL FOR WALL MOUNTED FLOOR MOUNTED, OR TANK TYPE WATER CLOSETS. TOILET FLUSH CONTROL HEIGHT SHALL BE 44" MAX FOR ADULTS AND 36" MAX FOR CHILDREN 12 AND UNDER. PROVIDE MOCK UP OF ACCESSIORIS PRIOR TO INSTALLATION FOR REVIEW BY OWNER REPRESENTATIVE

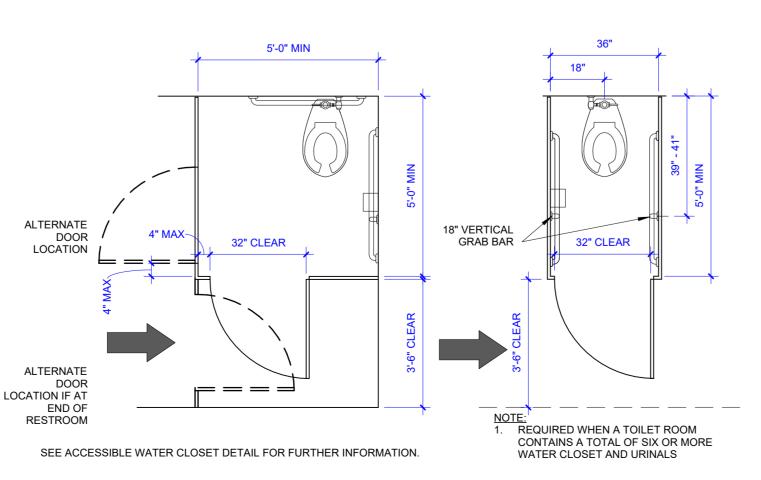

OTHER FIXTURES NOT ALLOWED WITHIN THIS AREA CLEAR FLOOR SPACE 60" MIN SEE ACCESSIBLE WATER CLOSET DETAIL FOR FURTHER INFORMATION.

ACCESSIBLE AND AMBULATORY STALL

ACCESSIBLE WATER CLOSET



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JARED A.

YOUNGLOVE

NUMBER

A-2017019282

8.28.23

JARED A. YOUNGLOVE, ARCHITECT

MO #: A-2017019282

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REVISION SCHEDULE

FIRE EXTINGUISHER EXTINGUISHER CABINET

FIRE EXTINGUISHER SHOULDSHER CABINET

COAT HOOKS

COAT HOOKS

7 ACCESSIBLE ACCESSORIES TYPICAL

SCALE 3/8" = 1'-0"


ADA TURN RADIUS

SCALE 3/8" = 1'-0"

OVERLAP OF KNEE AND TOE CLEARANCE


60" MIN.

EXISTING CONSTRUCTION

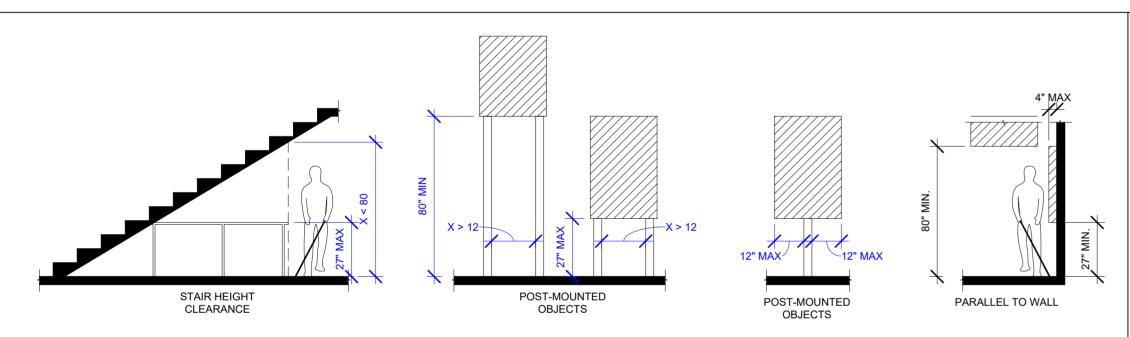


PROTRUDING OBJECT CLEARANCE

SCALE 1/4" = 1'-0"

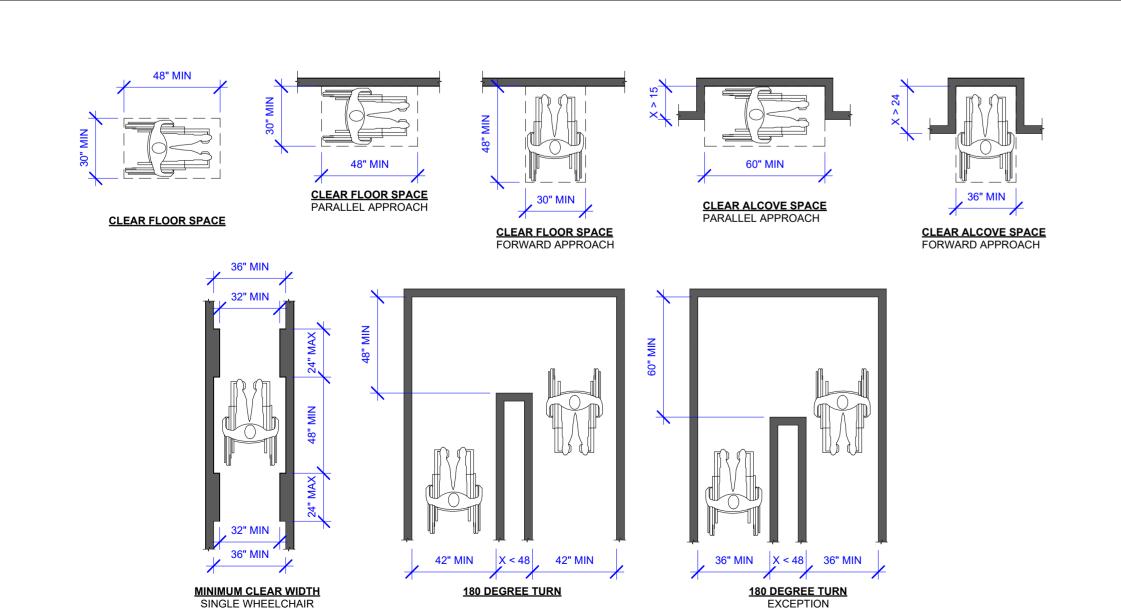


CLEAR FLOOR SPACE & MANEUVERING ACCESS

SCALE 1/4" = 1'-0"

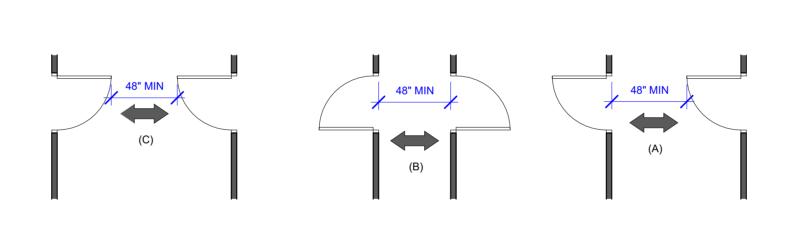


4 CORRIDOR DOOR CLEARANCES

SCALE 3/16" = 1'-0"

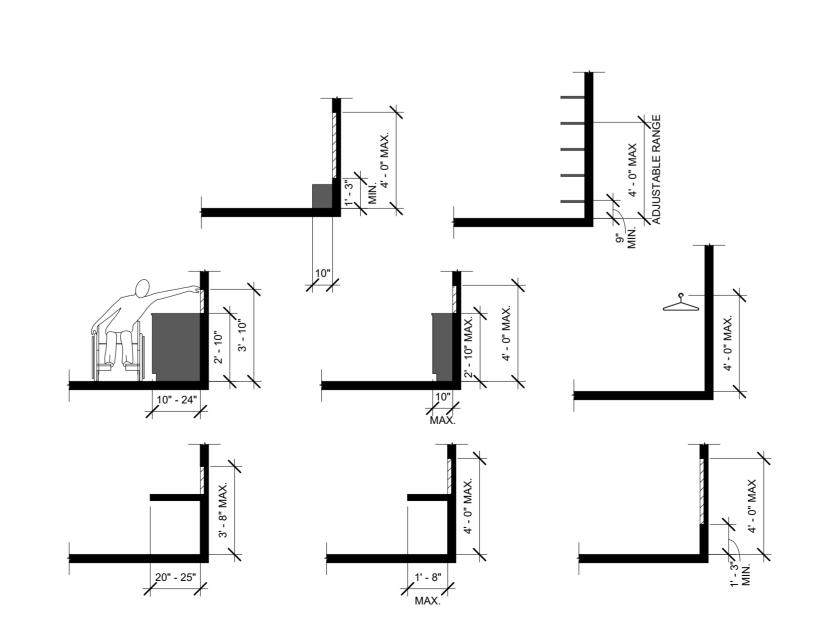

ADA REACH CLEARANCE

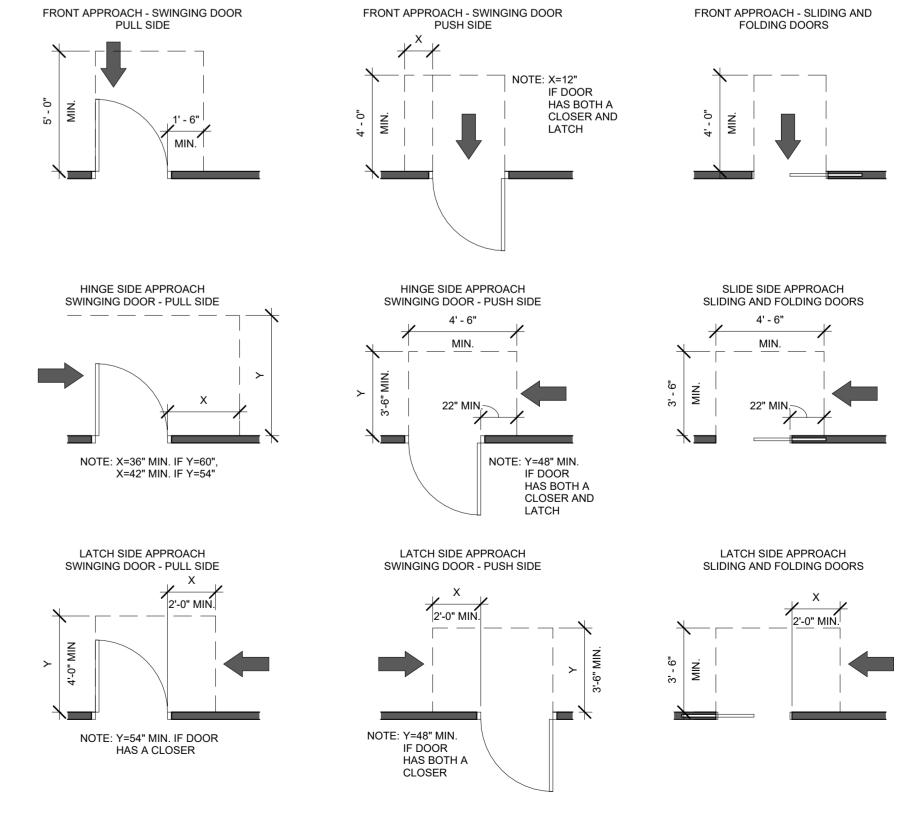

ADA APPROACH DIAGRAM

ENTENNIAL HALL IMPROVEMENTS
ND RENOVATION

ACCESSIBILITY STANDARDS

PROJECT ARCHITECT: JY

DRAWN BY:

CHECKED BY:

PROJECT NUMBER: 22-703A RC000638


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EBP, CSM, KS


JY, EBP

SHEET NUMBER:

**G0-4** 

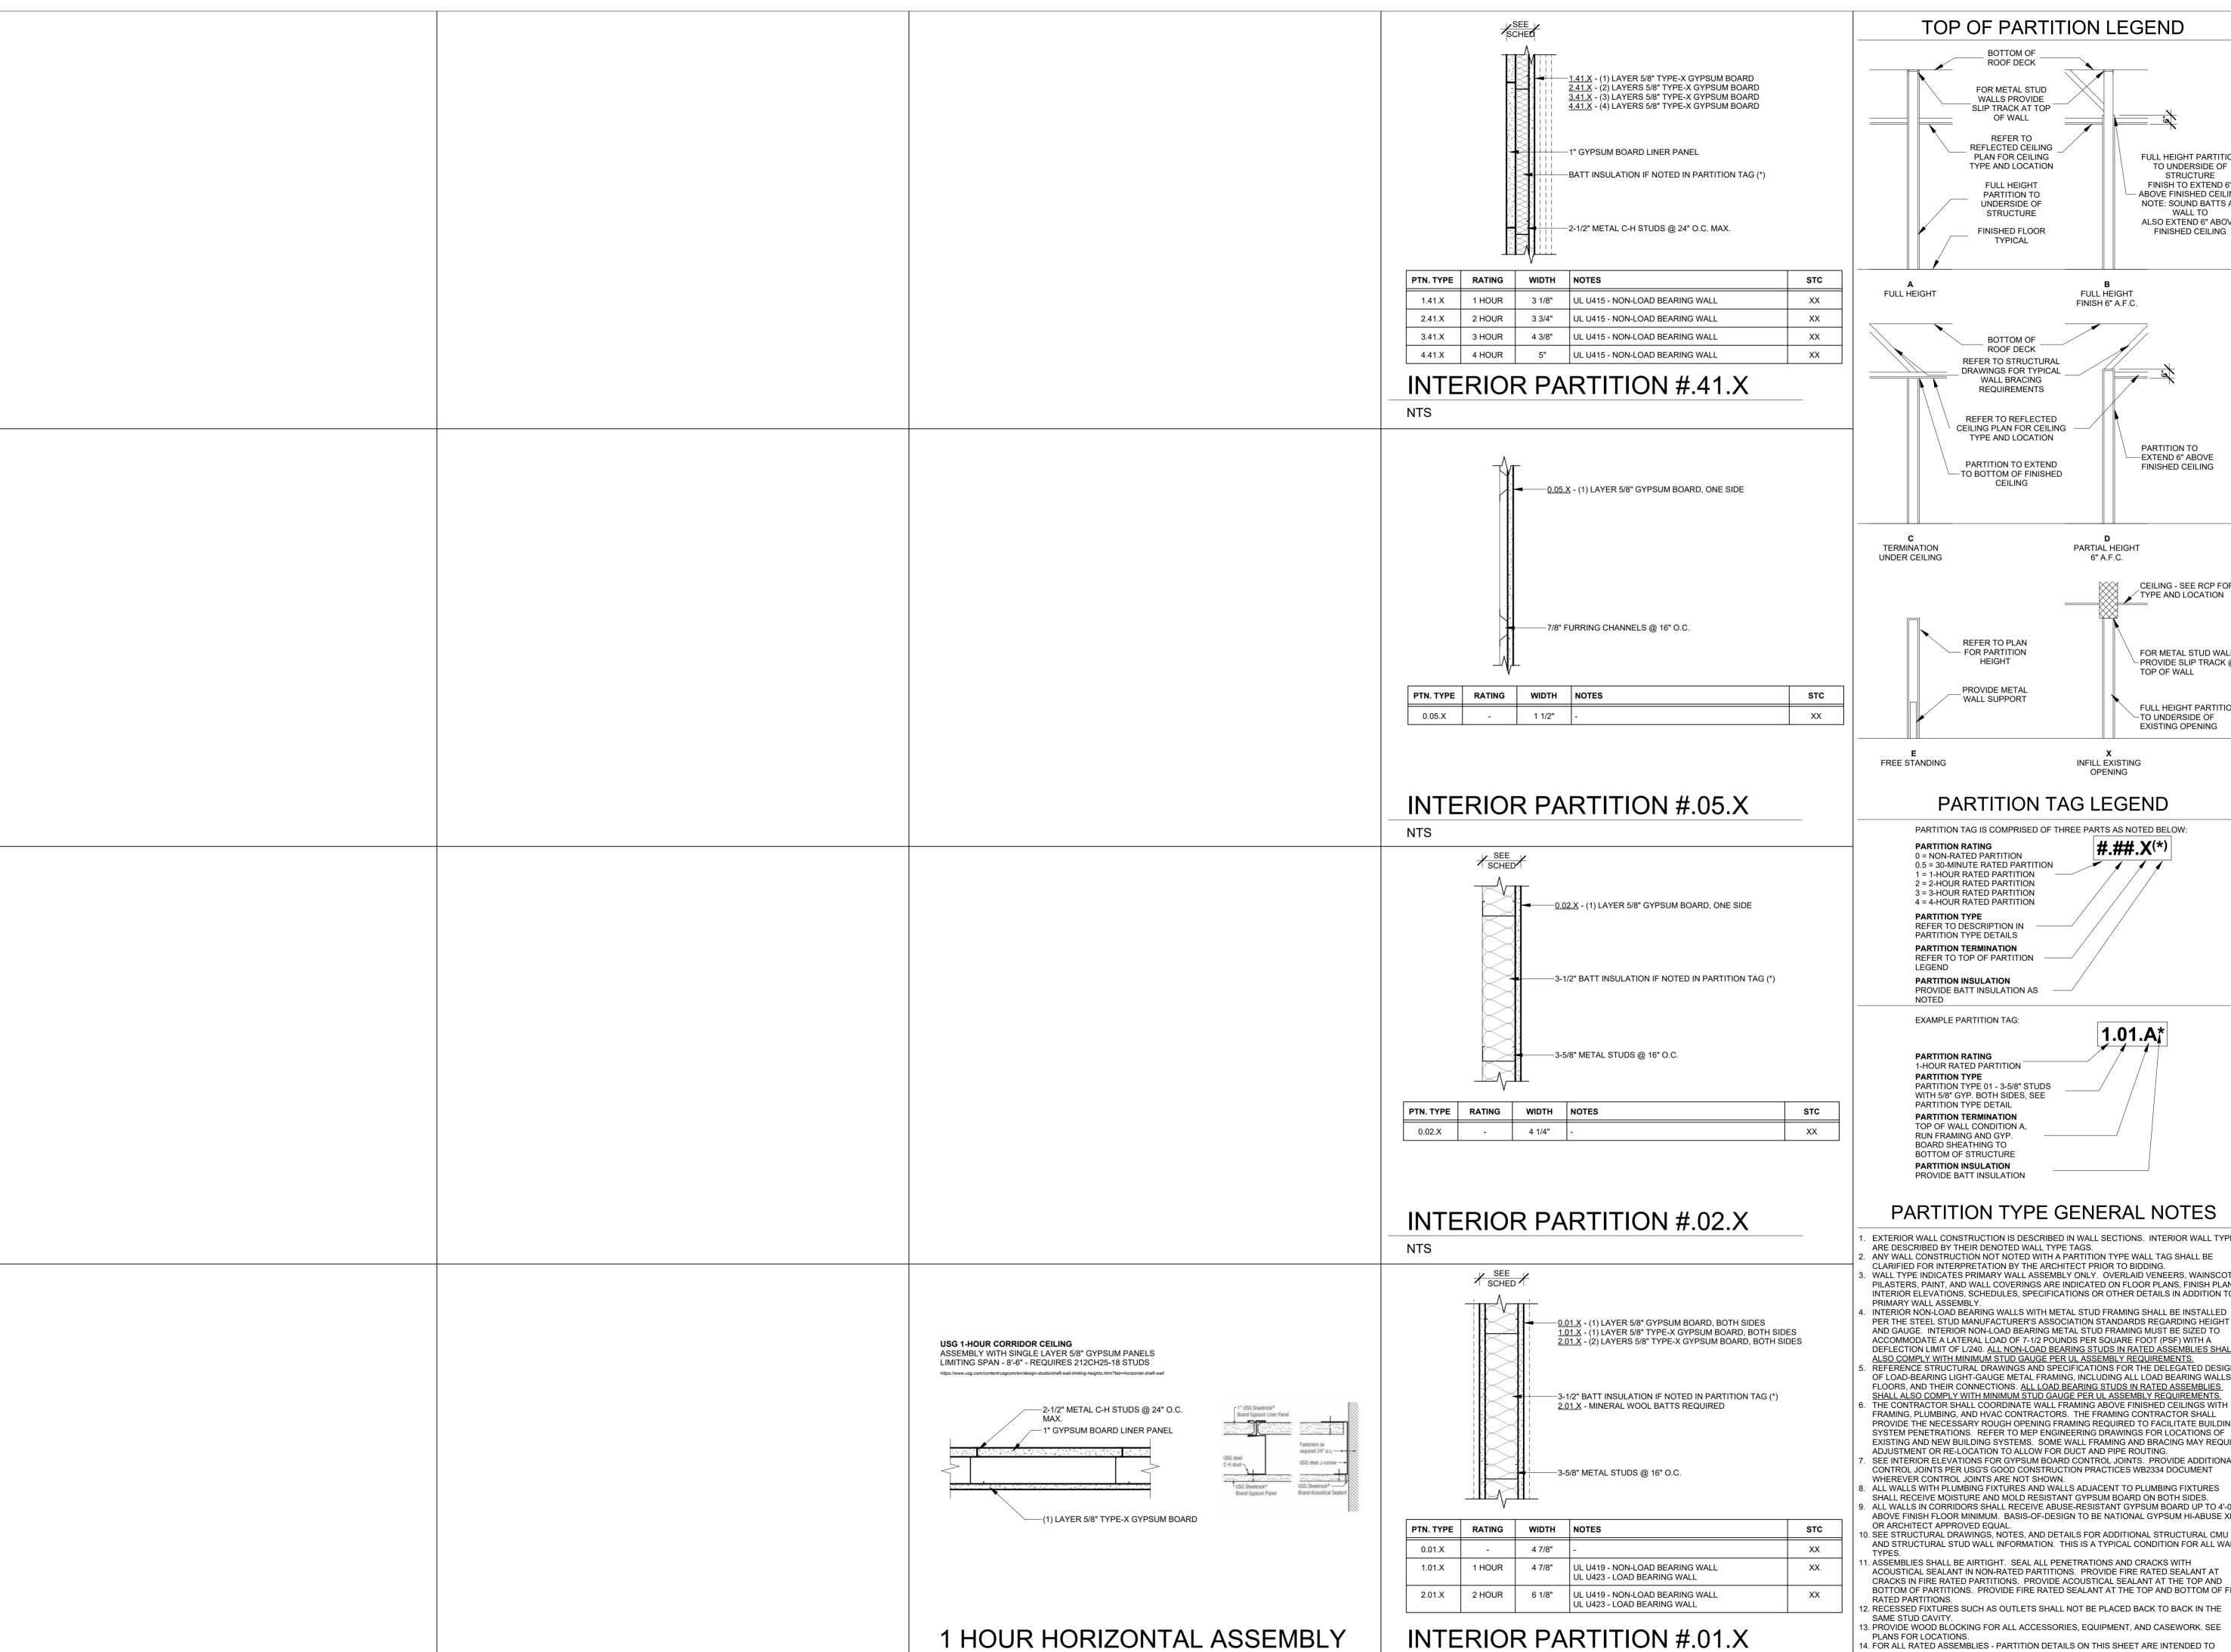

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1.01.A\*

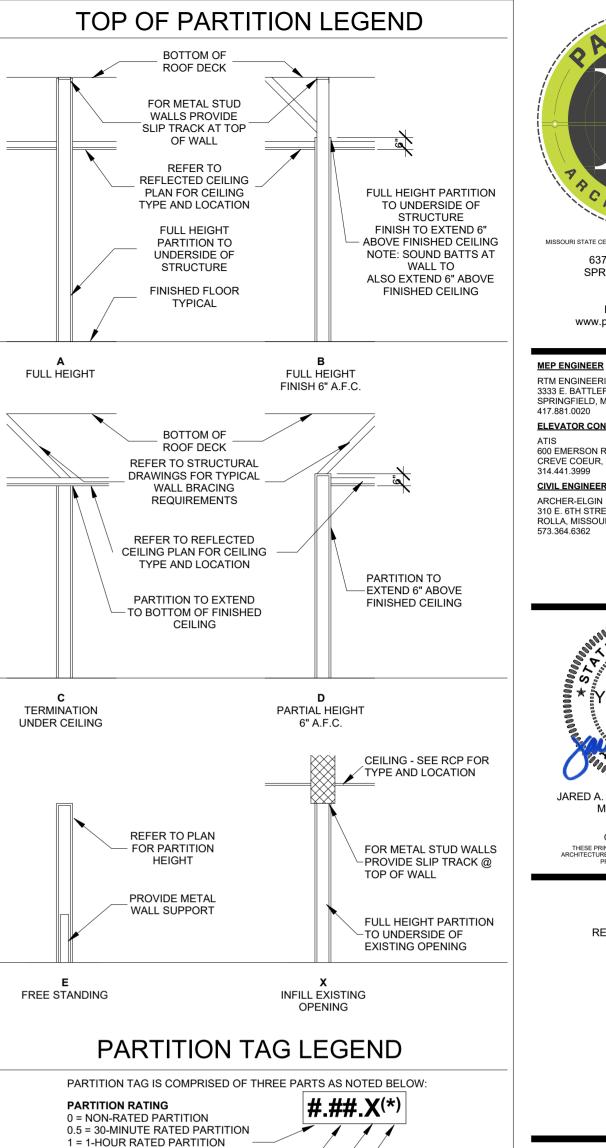EXTERIOR WALL CONSTRUCTION IS DESCRIBED IN WALL SECTIONS. INTERIOR WALL TYPES ARE DESCRIBED BY THEIR DENOTED WALL TYPE TAGS. ANY WALL CONSTRUCTION NOT NOTED WITH A PARTITION TYPE WALL TAG SHALL BE CLARIFIED FOR INTERPRETATION BY THE ARCHITECT PRIOR TO BIDDING. WALL TYPE INDICATES PRIMARY WALL ASSEMBLY ONLY. OVERLAID VENEERS, WAINSCOT, PILASTERS, PAINT, AND WALL COVERINGS ARE INDICATED ON FLOOR PLANS, FINISH PLANS, INTERIOR ELEVATIONS, SCHEDULES, SPECIFICATIONS OR OTHER DETAILS IN ADDITION TO PRIMARY WALL ASSEMBLY.

INTERIOR NON-LOAD BEARING WALLS WITH METAL STUD FRAMING SHALL BE INSTALLED PER THE STEEL STUD MANUFACTURER'S ASSOCIATION STANDARDS REGARDING HEIGHT AND GAUGE. INTERIOR NON-LOAD BEARING METAL STUD FRAMING MUST BE SIZED TO ACCOMMODATE A LATERAL LOAD OF 7-1/2 POUNDS PER SQUARE FOOT (PSF) WITH A DEFLECTION LIMIT OF L/240. ALL NON-LOAD BEARING STUDS IN RATED ASSEMBLIES SHALL ALSO COMPLY WITH MINIMUM STUD GAUGE PER UL ASSEMBLY REQUIREMENTS. REFERENCE STRUCTURAL DRAWINGS AND SPECIFICATIONS FOR THE DELEGATED DESIGN OF LOAD-BEARING LIGHT-GAUGE METAL FRAMING, INCLUDING ALL LOAD BEARING WALLS, FLOORS, AND THEIR CONNECTIONS. <u>ALL LOAD BEARING STUDS IN RATED ASSEMBLIES</u> SHALL ALSO COMPLY WITH MINIMUM STUD GAUGE PER UL ASSEMBLY REQUIREMENTS. THE CONTRACTOR SHALL COORDINATE WALL FRAMING ABOVE FINISHED CEILINGS WITH FRAMING, PLUMBING, AND HVAC CONTRACTORS. THE FRAMING CONTRACTOR SHALL PROVIDE THE NECESSARY ROUGH OPENING FRAMING REQUIRED TO FACILITATE BUILDING SYSTEM PENETRATIONS. REFER TO MEP ENGINEERING DRAWINGS FOR LOCATIONS OF EXISTING AND NEW BUILDING SYSTEMS. SOME WALL FRAMING AND BRACING MAY REQUIRE ADJUSTMENT OR RE-LOCATION TO ALLOW FOR DUCT AND PIPE ROUTING. SEE INTERIOR ELEVATIONS FOR GYPSUM BOARD CONTROL JOINTS. PROVIDE ADDITIONAL

- CONTROL JOINTS PER USG'S GOOD CONSTRUCTION PRACTICES WB2334 DOCUMENT WHEREVER CONTROL JOINTS ARE NOT SHOWN. ALL WALLS WITH PLUMBING FIXTURES AND WALLS ADJACENT TO PLUMBING FIXTURES SHALL RECEIVE MOISTURE AND MOLD RESISTANT GYPSUM BOARD ON BOTH SIDES.
- ALL WALLS IN CORRIDORS SHALL RECEIVE ABUSE-RESISTANT GYPSUM BOARD UP TO 4'-0" ABOVE FINISH FLOOR MINIMUM. BASIS-OF-DESIGN TO BE NATIONAL GYPSUM HI-ABUSE XP OR ARCHITECT APPROVED EQUAL.
- AND STRUCTURAL STUD WALL INFORMATION. THIS IS A TYPICAL CONDITION FOR ALL WALL
- . ASSEMBLIES SHALL BE AIRTIGHT. SEAL ALL PENETRATIONS AND CRACKS WITH ACOUSTICAL SEALANT IN NON-RATED PARTITIONS. PROVIDE FIRE RATED SEALANT AT CRACKS IN FIRE RATED PARTITIONS. PROVIDE ACOUSTICAL SEALANT AT THE TOP AND BOTTOM OF PARTITIONS. PROVIDE FIRE RATED SEALANT AT THE TOP AND BOTTOM OF FIRE 2. RECESSED FIXTURES SUCH AS OUTLETS SHALL NOT BE PLACED BACK TO BACK IN THE
- B. PROVIDE WOOD BLOCKING FOR ALL ACCESSORIES, EQUIPMENT, AND CASEWORK. SEE

4. FOR ALL RATED ASSEMBLIES - PARTITION DETAILS ON THIS SHEET ARE INTENDED TO ILLUSTRATE BASIC WALL ASSEMBLY. REFER TO UL LISTING DETAILS FOR SPECIFIC INSTRUCTION REGARDING ATTACHMENT, MATERIAL AND MANUFACTURER SELECTION, ETC.

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REVISION SCHEDULE

**IMPROVEMEN** TENNIAL F

> PROJECT ARCHITECT: JY DRAWN BY: EBP, CSM, KS CHECKED BY: JY, EBP


PROJECT NUMBER: 22-703A

RC000638

08/28/2023

**INTERIOR** 

SHEET NUMBER:

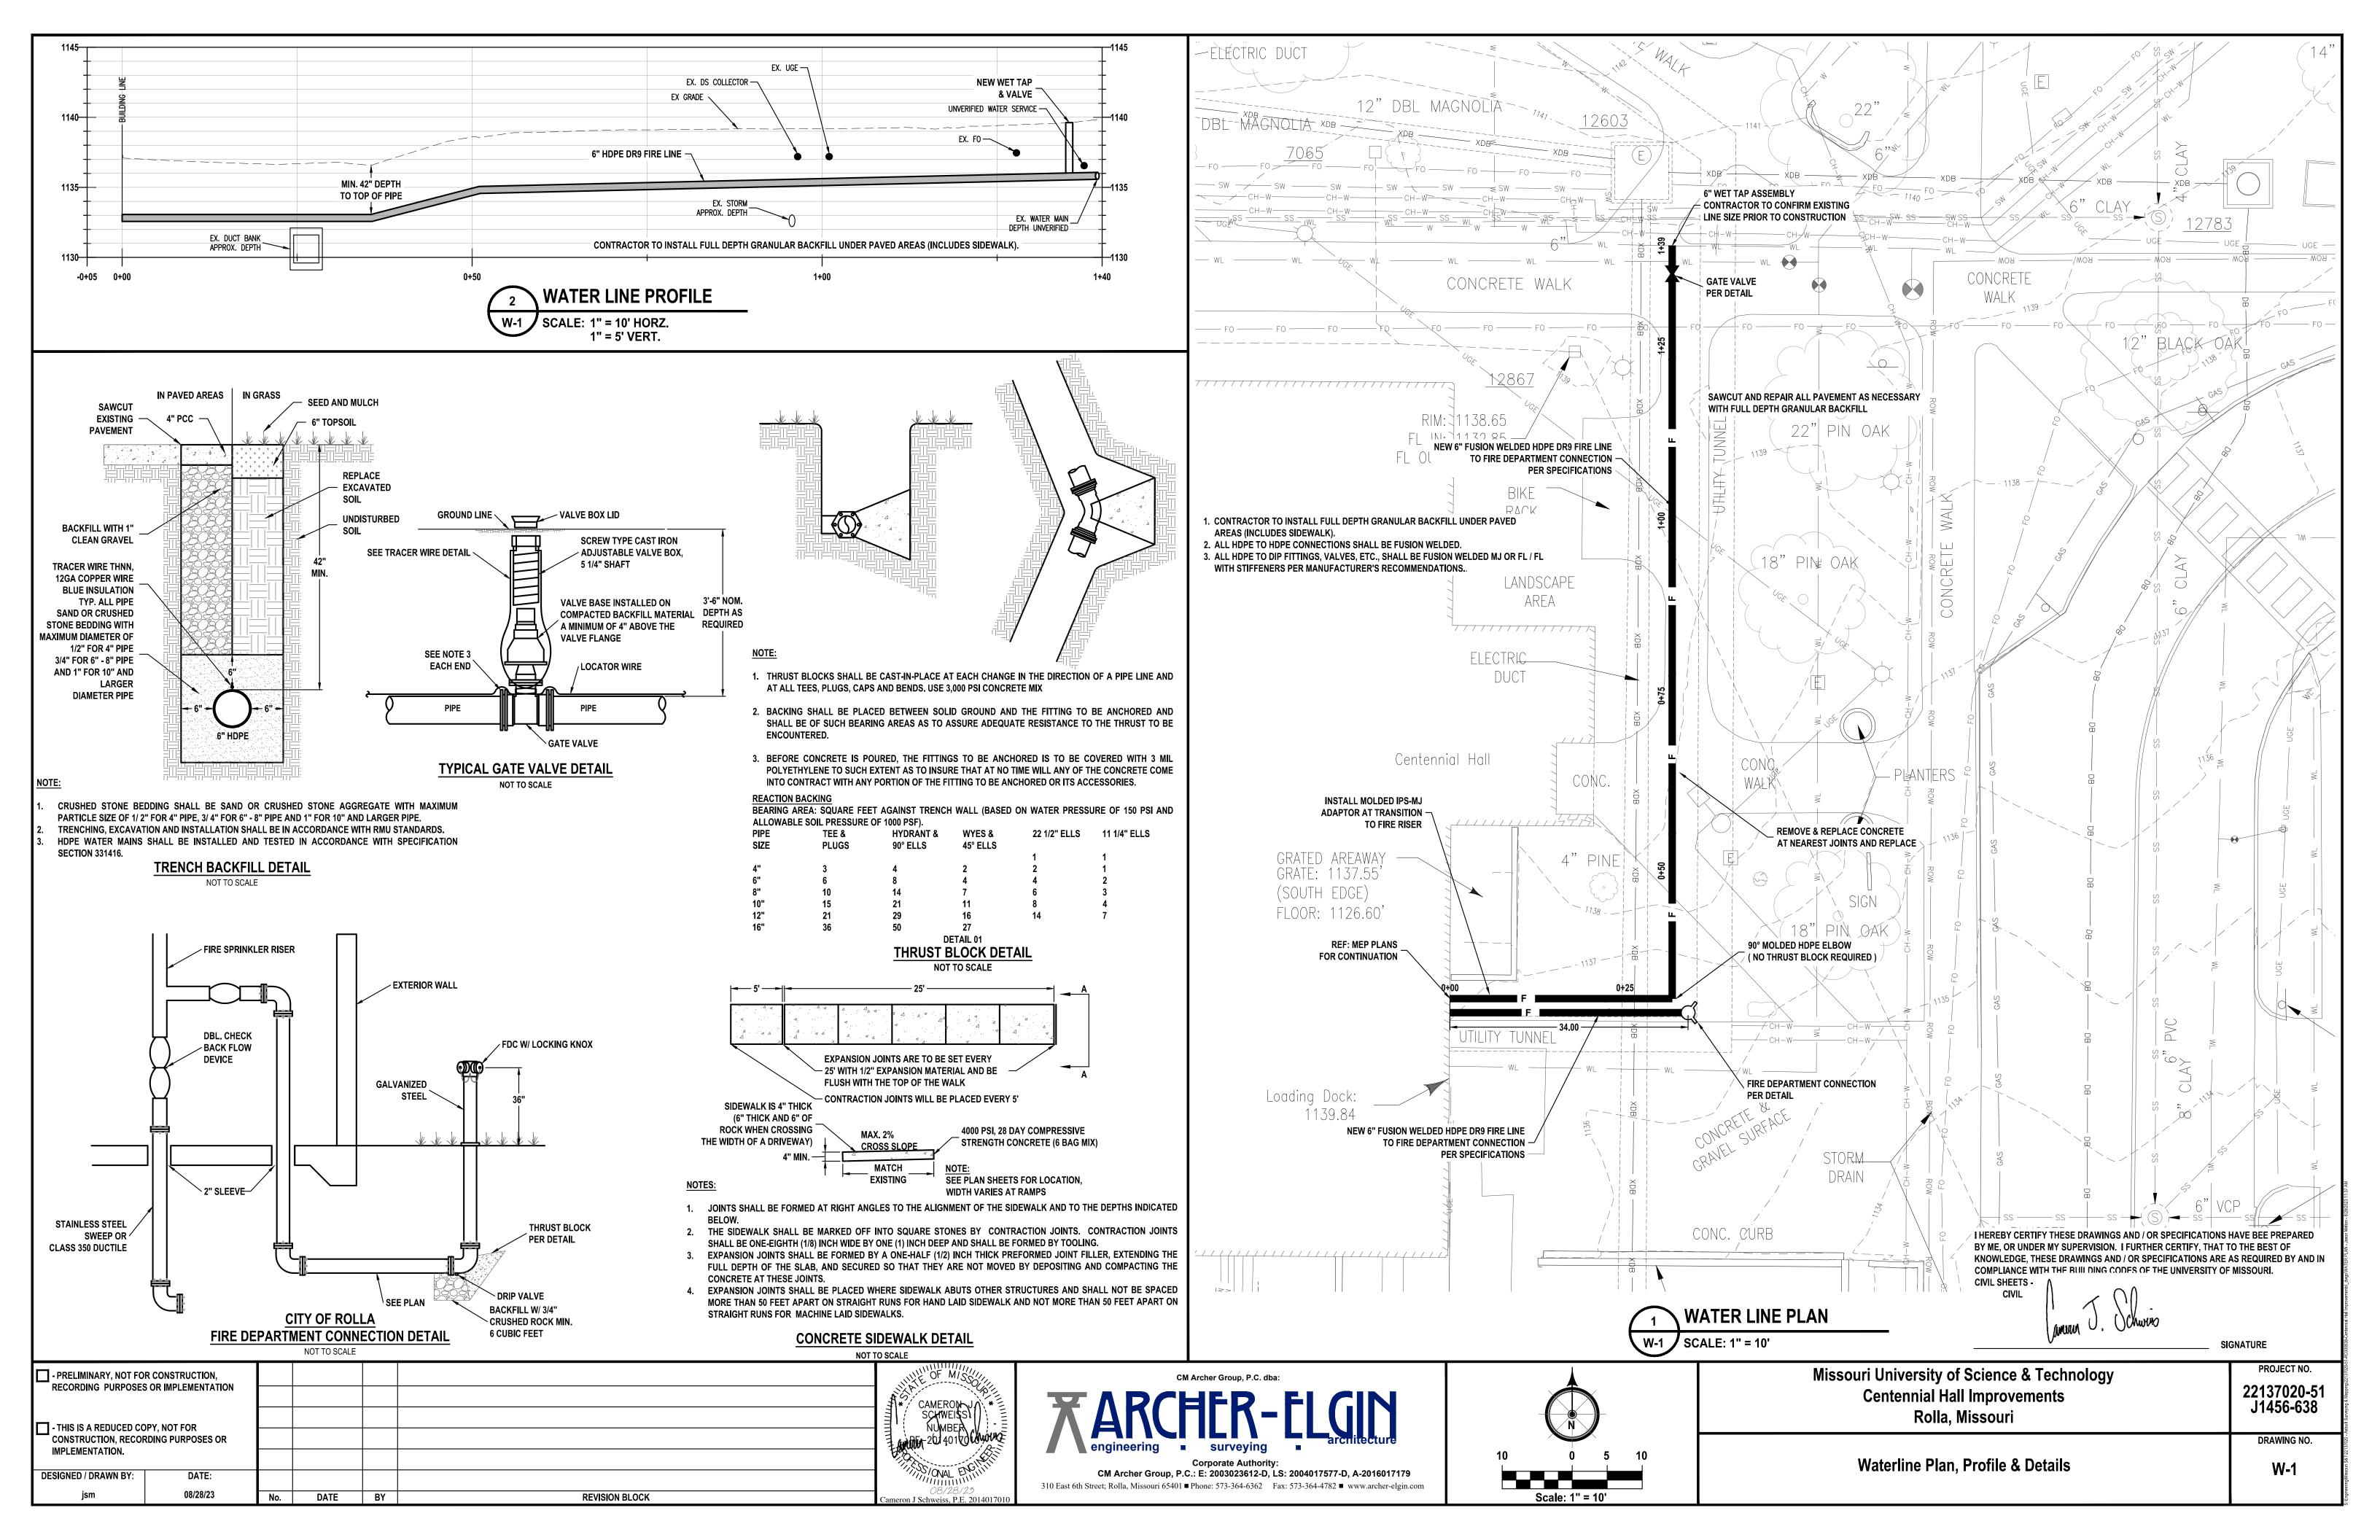



02.411 REMOVE EXISTING FIRE HOSE CABINET. PREPARE OPENING FOR NEW FINISH. PAINT TO MATCH EXISTING WALL FINISH WHERE APPLICABLE. SEE SECTION 02.4100 DEMOLITION. 09.216 ALIGN FINISH FACE OF NEW WALL ASSEMBLY WITH FINISH FACE OF EXISTING WALL. SEE

22.471 REMOVE EXISTING DRINKING FOUNTAINS. PROVIDE NEW HI-LOW ADA COMPLIANT DRINKING FOUNTAIN WITH BOTTLE FILLER. PROVIDE STAINLESS STEEL PLATE AT EXISTING WALL BEHIND NEW FOUNTAINS. SEE MEP. SEE DIVISION 22.0000



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TENNIAL HALL IMPROVEMENTS
RENOVATION

PROJECT NUMBER: 22-703A RC000638

08/28/2023


**KEYPLANS** 

SHEET NUMBER:


**A0-0** 



EXISTING SECOND FLOOR DRINKING FOUNTAINS INSTALLED IN EXISTING STUD WALL

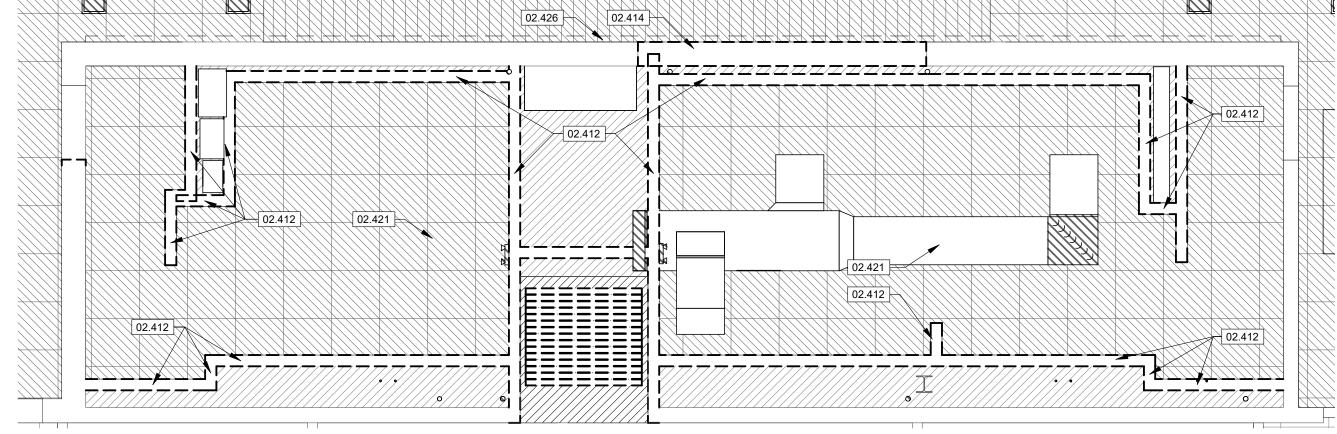


SECOND FLOOR RESTROOM REFLECTED CEILING DEMOLITION PLAN SCALE 1/4" = 1'-0"

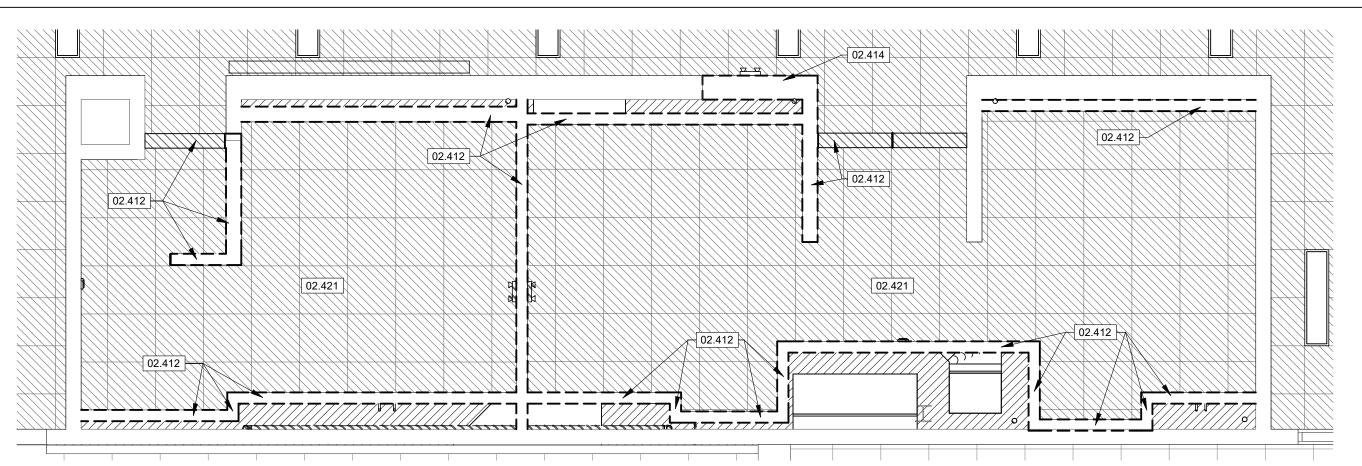




FIRST FLOOR RESTROOM REFLECTED CEILING DEMOLITION PLAN

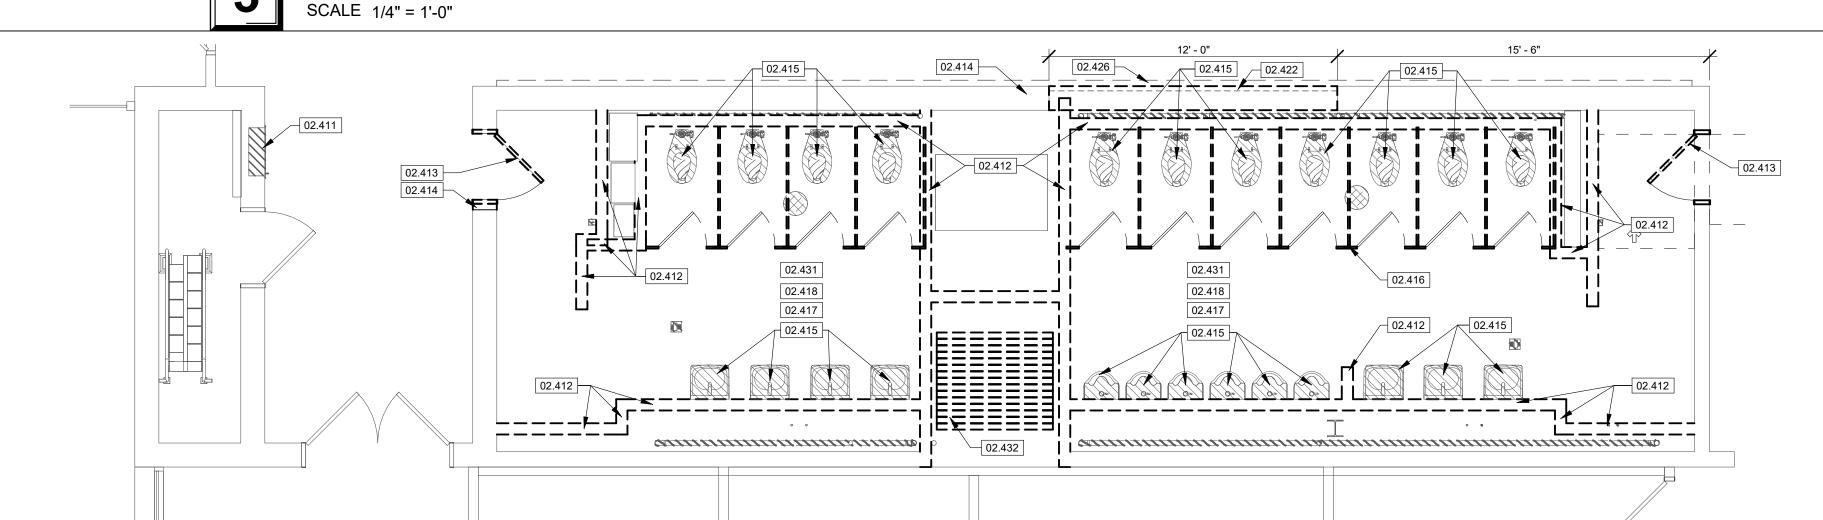

### SECOND FLOOR RESTROOM DEMOLITION PLAN SCALE 1/4" = 1'-0"

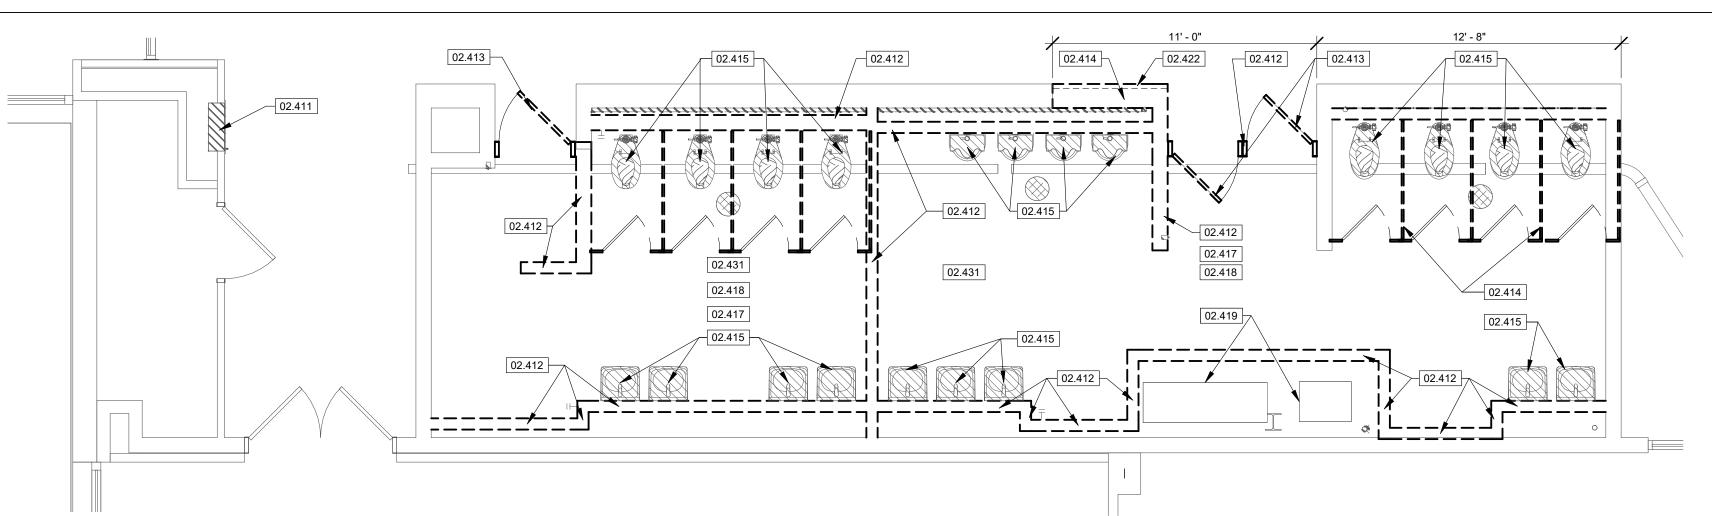

FIRST FLOOR RESTROOM DEMOLITION PLAN SCALE 1/4" = 1'-0"

02.411 REMOVE EXISTING FIRE HOSE CABINET. PREPARE OPENING FOR NEW FINISH. PAINT TO MATCH EXISTING WALL FINISH WHERE APPLICABLE. SEE SECTION 02.4100 DEMOLITION. 02.412 REMOVE PARTITION COMPLETE. PREPARE ADJACENT SURFACES FOR NEW FINISH. SEE SECTION 02.4100 DEMOLITION

**KEYNOTE LEGEND** 

- REMOVE DOOR AND FRAME. PREPARE ADJACENT SURFACE FOR NEW FINISH. SEE SECTION 02.4100 DEMOLITION.
- 02.414 REMOVE PORTION OF PARTITION. PREPARE ADJACENT SURFACE FOR NEW FINISH. SEE
  - SECTION 02.4100 DEMOLITION.
- REMOVE EXISTING PLUMBING FIXTURE. SEE SECTION 02.4100 DEMOLITION. 02.416 REMOVE RESTROOM PARTITIONS. SEE SECTION 02.4100 DEMOLITION.
- 02.417 REMOVE EXISTING FLOORING. PREPARE AREA FOR NEW FLOORING FINISH. SEE SECTION 02 4100 DEMOLITION
- 02.418 REMOVE EXISTING RESTROOM ACCESSORIES. COORDINATE WITH OWNER FOR SALVAGE OF ANY REMOVED ITEMS. SEE SECTION 02.4100 DEMOLITION. 02.419 DUCTWORK TO REMAIN. PROTECT DURING CONSTRUCTION. 02.421 FULLY REMOVE EXISTING CEILING SYSTEM. SEE SECTION 02.4100 DEMOLITION.
- SALVAGE EXISTING BRICK FOR REUSE ON PROJECT. SEE SECTION 02.4100 DEMOLITION CAREFULLY REMOVE EXISTING WALL FEATURE. CLEAN AND REPAIR SUBSURFACE AS NEEDED TO ACHIEVE NEW FINISH LEVEL ON EXTERIOR. SEE SECTION 02.4100 02.431 REMOVE EXISTING FLOORING. CLEAN CONCRETE SLAB TO BE FREE OF GLUE AND
- DEMOLITION. 02.432 REMOVE EXISTING FOLDING PARTITION. TRACK TO REMAIN. SEE SECTION 02.4100

OTHER FOREIGN DEBRIS. PATCH EXISTING CONCRETE IN PREPARATION TO ACCEPT NEW FINISHES. PROTECT EXISTING WALLS TO REMAIN. SEE SECTION 02.4100

- CAREFULLY REMOVE EXISTING DRINKING FOUNTAINS AND ASSOCIATED BACKING
- PANELS. SEE SECTION 02.4100 DEMOLITION. CUT EXISTING WALL AS NECESSARY FOR REMOVAL OF EXISTING AND INSTALLATION C NEW DRINKING FOUNTAINS.



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### **DEMOLITION GENERAL NOTES**

THE CONTRACTOR SHALL PROVIDE ALL TEMPORARY PARTITIONS AND TEMPORARY DOORS AS DEEMED NECESSARY BY THE ARCHITECT, ENGINEERS, AND OWNER, TEMPORARY DOORS SHALL BE WELL MAINTAINED AND ANY DAMAGE REPAIRED IMMEDIATELY TO AVOID MIGRATION OF DUST INTO ADJOINING AREAS. THE CONTRACTOR SHALL ERECT AND MAINTAIN TEMPORARY DUST PROOF PARTITIONS TO LIMIT DUST AND NOISE FROM ENTERING ADJACENT OCCUPIED SPACES. DUST PROOF PARTITIONS SHALL BE CONSTRUCTED WITH WOOD STUD FRAMING, PLYWOOD, BATT INSULATION, AND POLYETHYLENE PLASTIC SHEETING AS NEEDED TO CREATE A DUST-PROOF BARRIER.

THE CONTRACTOR SHALL COORDINATE ALL DEMOLITION WORK IN OCCUPIED SPACES INCLUDING ABOVE AND BELOW THE AREA OF WORK WITH SUB-CONTRACTORS AND OWNER. DEMOLITION WORK. SPACES ADJACENT TO, ABOVE, AND BELOW THE AREA OF WORK ARE INTENDED TO REMAIN OCCUPIED DURING DEMOLITION ACTIVITIES AND ALL WORK SHALL BE PERFORMED IN SUCH A MANNER AS TO MINIMIZE DISRUPTIONS TO OCCUPANTS. PROTECT EXISTING FLOOR FINISHES FROM CONSTRUCTION TRAFFIC THROUGH OCCUPIED AREAS. EXISTING WALL, FLOOR, AND CEILING FINISHES TO REMAIN SHALL BE PROTECTED AND ANY DAMAGE RESULTING FROM DEMOLITION WORK SHALL BE REPAIRED BY THE CONTRACTOR

AT CONTRACTOR'S EXPENSE. EACH CONTRACTOR WILL BE EXPECTED TO STOP WORK IN AREAS ADJACENT TO OCCUPIED SPACES WHEN CONSTRUCTION NOISE, ODORS, AND/OR DUST INTERRUPTS NORMAL BUILDING OCCUPANCY

MAINTAIN PATH OF EGRESS AT ALL TIMES DURING CONSTRUCTION FOR EXISTING BUILDING OCCUPANTS. A MINIMUM CLEAR PATH OF EGRESS OF 4'-0" SHALL BE ENFORCED BY THE CONTRACTOR AT ALL TIMES.
WHEN DEMOLITION CAUSES DAMAGE TO FLOOR, WALL, OR CEILING SURFACES THAT WILL REMAIN EXPOSED IN THE FINISHED WORK SUCH DAMAGE SHALL BE REPAIRED AS REQUIRED TO RECEIVE NEW FINISHES.

CONTRACTOR SHALL PROTECT ANY EXISTING WALLS, DOORS, HARDWARE, LIGHTS, FIXTURES, FINISHES, CEILINGS, WINDOWS OR GLASS IN DOORS OR ANY OTHER EXISTING ELEMENTS TO REMAIN AND/OR DIRECTLY ADJACENT TO CONSTRUCTION AREAS PROTECTION SHALL INCLUDE PLYWOOD OR OTHER SOLID PROTECTION AS NECESSARY TO PREVENT DAMAGE BY DEBRIS AND CONSTRUCTION ACTIVITIES. THE CONTRACTOR SHALL COVER AND PROTECT OWNER'S EQUIPMENT WHICH CANNOT BE REMOVED FROM THE PROJECT AREA.

CONTRACTOR SHALL COORDINATE ALL DEMOLITION WITH ANY PHASING AS REQUIRED TO WHERE EXTERIOR WALLS, DOORS, AND/OR WINDOWS ARE TO BE REMOVED OR MODIFIED THE CONTRACTOR SHALL TAKE ALL NECESSARY PRECAUTIONS TO ENSURE THAT THE EXISTING BUILDING REMAINS SECURE, WEATHER-TIGHT, AND WITHOUT DRAFTS WHEN

0. MAKE ALL DEMOLITION CLEAN AND COMPLETE AND IN A MANNER SUITABLE TO ACCEPT NEW FINISHES AND FINISHED SURFACES. . REMOVE ALL EXISTING WALL MOUNTED ITEMS WITHIN THE PROJECT AREA WHICH ARE NOT NOTED TO REMAIN. THE CONTRACTOR SHALL DISPOSE OF THESE ITEMS AFTER INSPECTION BY THE OWNER FOR FUTURE USE OR STORAGE. IF ITEMS ARE REMOVED FROM WALLS

THAT ARE TO REMAIN THE CONTRACTOR SHALL PATCH WALLS AS REQUIRED TO RECEIVE NEW FINISHES AND/OR FINISHED SURFACES. 2. DEMOLITION FOR BUILDING SERVICES AND UTILITIES SHALL BE PERFORMED BY THE TRADE RESPONSIBLE FOR THAT UTILITY. FOR EXAMPLE, PLUMBING FIXTURES SHALL BE DEMOLISHED BY THE PLUMBING CONTRACTOR. OPENINGS FOR DEMOLISHED UTILITIES SHALL BE INFILLED BY TRADE RESPONSIBLE FOR PIPING, DUCT, OR CONDUIT DEMOLITION.

OPENINGS THROUGH FIRE-RATED CONSTRUCTION SHALL BE PATCHED TO MATCH EXISTING CONSTRUCTION OR BE FIRESTOPPED AS REQUIRED BY APPLICABLE CODES. . REROUTE OR TERMINATE ALL CONNECTIONS OF BUILDING SYSTEMS PRIOR TO DEMOLITION. EXISTING BUILDING SYSTEMS SHALL REMAIN ACTIVE AT ALL TIMES OF REGULAR BUILDING USE UNLESS PROPER, SCHEDULED, AND TEMPORARY SHUTDOWN IS COORDINATED AND

APPROVED BY OWNER AND CONTRACTOR. 4. IF CONTRACTOR ENCOUNTERS DEMOLITION WHICH IS STRUCTURAL AND/OR LOAD BEARING THAT HAS NOT BEEN IDENTIFIED IN DRAWINGS AS LOAD BEARING THE CONTRACTOR MUST CONTACT ARCHITECT IMMEDIATELY AND DOCUMENT CONDITIONS IN WRITING 5. PROVIDE TEMPORARY SHORING OR BRACING OF EXISTING STRUCTURAL SYSTEMS AS

REQUIRED FOR INSTALLATION OF NEW CONSTRUCTION. 6. SEE FLOOR PLANS, ELEVATIONS, DETAILS, AND OTHER DRAWINGS INCLUDED HEREIN FOR NEW CONSTRUCTION AND ITS EFFECT ON DEMOLITION ITEMS DESCRIBED HEREIN. 7. SEE SPECIFICATIONS FOR DISPOSAL OR SALVAGE OF ALL DEMOLISHED MATERIALS AND DEBRIS. ALL DEMOLISHED ITEMS AND MATERIALS THAT ARE NOT TURNED OVER TO OWNER SHALL BE REMOVED FROM THE BUILDING AND PROJECT SITE AND DISPOSED OF OFF-SITE IN A PROPER AND LEGAL MANNER.

B. DEMOLITION IDENTIFIED AS "COMPLETE" IS TO BE FULLY DEMOLISHED INCLUDING ASSOCIATED FASTENERS, MASTIC, BLOCKING, AND ACCESSORIES TO THAT ITEM OR ITEMS. 9. ANY ITEM OR ITEMS INDICATED TO BE SALVAGED FOR REINSTALLATION OR TURNED OVER TO OWNER SHOULD BE PHOTOGRAPHED AND COPIES OF THE PHOTOGRAPHS SENT TO THE ARCHITECT AND OWNER WITHIN 10 DAYS OF REMOVAL ITEMS TO BE SALVAGED SHALL BE CAREFULLY REMOVED AND PROPERLY STORED BY CONTRACTOR UNTIL TURNED OVER TO OWNER, COORDINATE STORAGE AND TIMELINE WITH OWNER FOR TRANSFER OF SALVAGED IF CONTRACTOR ENCOUNTERS HAZARDOUS MATERIALS, THEN THE WORK IN THE AREA IS

TO BE SUSPENDED AND CONTRACTOR MUST NOTIFY THE OWNER AND ARCHITECT FOR

MP

SHEET NUMBER:

**DEMO PLANS -**

**RESTROOMS** 

PROJECT ARCHITECT: JY

EBP, CSM, KS

JY, EBP

DRAWN BY:

22-703A

RC000638

08/28/2023

CHECKED BY:

PROJECT NUMBER:



### **KEYNOTE LEGEND**

02.420 EXISTING SOFFIT TO REMAIN.

02.427 CAREFULLY REMOVE AND SALVAGE EXISTING LIGHT FIXTURES STORE FOR REINSTALLATION. SEE SECTION 02.4100 DEMOLITION.

02.428 CAREFULLY REMOVE AND SALVAGE EXISTING DIFFUSERS AND STORE FOR REINSTALLATION. SEE SECTION 02.4100 DEMOLITION.



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REMAIN IN PLACE. REINSTALL CEILING TILES AFTER INSTALLATION OF SPRINKLER SYSTEM IS COMPLETE. CONTRACTOR TO REVIEW REQUIRED DEMOLITION ON SITE AND PROVIDE BASE BID FOR

EXPECTED AREA OF DEMO. CONTRACTOR TO PROVIDE ANTICIPATED REPLACEMENT AMOUNTS OF CEILINGS TILES BASED ON SCOPE OF WORK. PROVIDE FIELD VERIFICATION PRIOR TO START OF DEMOLITION WITH DEFINED AREA OF CEILING DEMO CORRESPONDING TO BASE BID AREA OF EXPECTED DEMO. CONTRACTOR TO RECEIVE APPROVAL FROM OWNER'S REP FOR REPLACEMENT GREATER THAN BASE BID AMOUNT PRIOR TO REMOVAL. CONTRACTOR TO UNIT PRICING FOR THE FOLLOWING ITEMS:

**CEILING DEMOLITION LEGEND** 

FROM MAIN LINE. SEE MEP SHEETS FOR MORE INFORMATION.

INSTALLATION OF SPRINKLER SYSTEM IS COMPLETE.

FULLY REMOVE CEILING TILES AND GRID SYSTEM. NOTE LOCATION OF ALL LIGHTING FIXTURES AND DIFFUSERS. REMOVE AND STORE ALL LIGHTING AND DEFUSERS TO BE REINSTALLED WITH NEW ACCUSTICAL CEILING AFTER

CARFULLY REMOVE AND STORE PORTION OF EXISTING CEILING GRID / TILES AS NECESSARY FOR SECONDARY SPRINKLER LINES, REINSTALL REMOVED PORTION AFTER INSTALLATION OF SPRINKLER SYSTEM IS COMPLETE AREA SHOWN REPRESENTS AN APPROXIMATE LOCATION OF SECONDARY LINES

CAREFULLY REMOVE AND STORE EXISTING CEILING TILES AS NECESSARY TO COMPLETE THE INSTALLATION SPRINKLER SYSTEM. CEILING GRID IS TO

CEILING TILE REPLACEMEN CEILING GRID REPLACEMENT

### DEMOLITION GENERAL NOTES

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5. PROVIDE TEMPORARY SHORING OR BRACING OF EXISTING STRUCTURAL SYSTEMS AS REQUIRED FOR INSTALLATION OF NEW CONSTRUCTION. 6. SEE FLOOR PLANS, ELEVATIONS, DETAILS, AND OTHER DRAWINGS INCLUDED HEREIN FOR NEW CONSTRUCTION AND ITS EFFECT ON DEMOLITION ITEMS DESCRIBED HEREIN. 7. SEE SPECIFICATIONS FOR DISPOSAL OR SALVAGE OF ALL DEMOLISHED MATERIALS AND DEBRIS. ALL DEMOLISHED ITEMS AND MATERIALS THAT ARE NOT TURNED OVER TO OWNER SHALL BE REMOVED FROM THE BUILDING AND PROJECT SITE AND DISPOSED OF OFF-SITE

IN A PROPER AND LEGAL MANNER

8. DEMOLITION IDENTIFIED AS "COMPLETE" IS TO BE FULLY DEMOLISHED INCLUDING ASSOCIATED FASTENERS, MASTIC, BLOCKING, AND ACCESSORIES TO THAT ITEM OR ITEMS 9 ANY ITEM OR ITEMS INDICATED TO BE SALVAGED FOR REINSTALLATION OR TURNED OVER TO OWNER SHOULD BE PHOTOGRAPHED AND COPIES OF THE PHOTOGRAPHS SENT TO THE ARCHITECT AND OWNER WITHIN 10 DAYS OF REMOVAL. ITEMS TO BE SALVAGED SHALL BE CAREFULLY REMOVED AND PROPERLY STORED BY CONTRACTOR UNTIL TURNED OVER TO OWNER. COORDINATE STORAGE AND TIMELINE WITH OWNER FOR TRANSFER OF SALVAGED ITEMS TO OWNER. IF CONTRACTOR ENCOUNTERS HAZARDOUS MATERIALS, THEN THE WORK IN THE AREA IS

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> PROJECT ARCHITECT: JY DRAWN BY: EBP, CSM, KS CHECKED BY: JY, EBP

PROJECT NUMBER: 22-703A RC000638

08/28/2023

**DEMO RCP** 

SHEET NUMBER:

### **KEYNOTE LEGEND**

02.420 EXISTING SOFFIT TO REMAIN.

02.428 CAREFULLY REMOVE AND SALVAGE EXISTING DIFFUSERS AND STORE FOR REINSTALLATION. SEE SECTION 02.4100 DEMOLITION. 02.433 REMOVE EXISTING LIGHT FIXTURES. SEE SECTION 02.4100 DEMOLITION.



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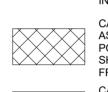
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### **CEILING DEMOLITION LEGEND**

FULLY REMOVE CEILING TILES AND GRID SYSTEM. NOTE LOCATION OF ALL LIGHTING FIXTURES AND DIFFUSERS. REMOVE AND STORE ALL LIGHTING AND DEFUSERS TO BE REINSTALLED WITH NEW ACCUSTICAL CEILING AFTER INSTALLATION OF SPRINKLER SYSTEM IS COMPLETE.



CEILING GRID REPLACEMENT

CARFULLY REMOVE AND STORE PORTION OF EXISTING CEILING GRID / TILES AS NECESSARY FOR SECONDARY SPRINKLER LINES. REINSTALL REMOVED PORTION AFTER INSTALLATION OF SPRINKLER SYSTEM IS COMPLETE. AREA SHOWN REPRESENTS AN APPROXIMATE LOCATION OF SECONDARY LINES FROM MAIN LINE. SEE MEP SHEETS FOR MORE INFORMATION CAREFULLY REMOVE AND STORE EXISTING CEILING TILES AS NECESSARY TO COMPLETE THE INSTALLATION SPRINKLER SYSTEM. CEILING GRID IS TO REMAIN IN PLACE. REINSTALL CEILING TILES AFTER INSTALLATION OF SPRINKLER SYSTEM IS COMPLETE

CONTRACTOR TO REVIEW REQUIRED DEMOLITION ON SITE AND PROVIDE BASE BID FOR EXPECTED AREA OF DEMO. CONTRACTOR TO PROVIDE ANTICIPATED REPLACEMENT AMOUNTS OF CEILINGS TILES BASED ON SCOPE OF WORK, PROVIDE FIELD VERIFICATION PRIOR TO START OF DEMOLITION WITH DEFINED AREA OF CEILING DEMO CORRESPONDING TO BASE BID AREA OF EXPECTED DEMO. CONTRACTOR TO RECEIVE APPROVAL FROM OWNER'S REP FOR REPLACEMENT GREATER THAN BASE BID AMOUNT PRIOR TO REMOVAL. CONTRACTOR TO UNIT PRICING FOR THE FOLLOWING ITEMS: CEILING TILE REPLACEMENT

CEILING DEMOLITION OF SECOND FLOOR MAY VARY ON FINAL EXTENT OF CEILING DEMOLITION COMPLETED DURING ROOF REPLACEMENT PROJECT.

### DEMOLITION GENERAL NOTES

- THE CONTRACTOR SHALL PROVIDE ALL TEMPORARY PARTITIONS AND TEMPORARY DOORS AS DEEMED NECESSARY BY THE ARCHITECT, ENGINEERS, AND OWNER. TEMPORARY DOORS SHALL BE WELL MAINTAINED AND ANY DAMAGE REPAIRED IMMEDIATELY TO AVOID MIGRATION OF DUST INTO ADJOINING AREAS. THE CONTRACTOR SHALL ERECT AND MAINTAIN TEMPORARY DUST PROOF PARTITIONS TO LIMIT DUST AND NOISE FROM ENTERING ADJACENT OCCUPIED SPACES. DUST PROOF PARTITIONS SHALL BE CONSTRUCTED WITH WOOD STUD FRAMING, PLYWOOD, BATT INSULATION, AND POLYETHYLENE PLASTIC SHEETING AS NEEDED TO CREATE A DUST-PROOF BARRIER. THE CONTRACTOR SHALL COORDINATE ALL DEMOLITION WORK IN OCCUPIED SPACES INCLUDING ABOVE AND BELOW THE AREA OF WORK WITH SUB-CONTRACTORS AND OWNER. THE CONTRACTOR SHALL NOTIFY THE OWNER TWO WEEKS PRIOR TO COMMENCING DEMOLITION WORK. SPACES ADJACENT TO, ABOVE, AND BELOW THE AREA OF WORK ARE INTENDED TO REMAIN OCCUPIED DURING DEMOLITION ACTIVITIES AND ALL WORK SHALL BE PERFORMED IN SUCH A MANNER AS TO MINIMIZE DISRUPTIONS TO OCCUPANTS. PROTECT EXISTING FLOOR FINISHES FROM CONSTRUCTION TRAFFIC THROUGH OCCUPIED AREAS. EXISTING WALL FLOOR AND CEILING FINISHES TO REMAIN SHALL BE PROTECTED AND ANY DAMAGE RESULTING FROM DEMOLITION WORK SHALL BE REPAIRED BY THE CONTRACTOR AT CONTRACTOR'S EXPENSE.
- EACH CONTRACTOR WILL BE EXPECTED TO STOP WORK IN AREAS ADJACENT TO OCCUPIED SPACES WHEN CONSTRUCTION NOISE, ODORS, AND/OR DUST INTERRUPTS NORMAL BUILDING OCCUPANCY. MAINTAIN PATH OF EGRESS AT ALL TIMES DURING CONSTRUCTION FOR EXISTING
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- 5. PROVIDE TEMPORARY SHORING OR BRACING OF EXISTING STRUCTURAL SYSTEMS AS REQUIRED FOR INSTALLATION OF NEW CONSTRUCTION. 6. SEE FLOOR PLANS, ELEVATIONS, DETAILS, AND OTHER DRAWINGS INCLUDED HEREIN FOR NEW CONSTRUCTION AND ITS EFFECT ON DEMOLITION ITEMS DESCRIBED HEREIN. 7. SEE SPECIFICATIONS FOR DISPOSAL OR SALVAGE OF ALL DEMOLISHED MATERIALS AND
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PROJECT ARCHITECT: JY DRAWN BY: EBP, CSM, KS CHECKED BY: JY, EBP


PROJECT NUMBER: 22-703A

RC000638 08/28/2023

**DEMO RCP** 

SHEET NUMBER:

DEMOLITION REFLECTED CEILING PLAN SECOND LEVEL

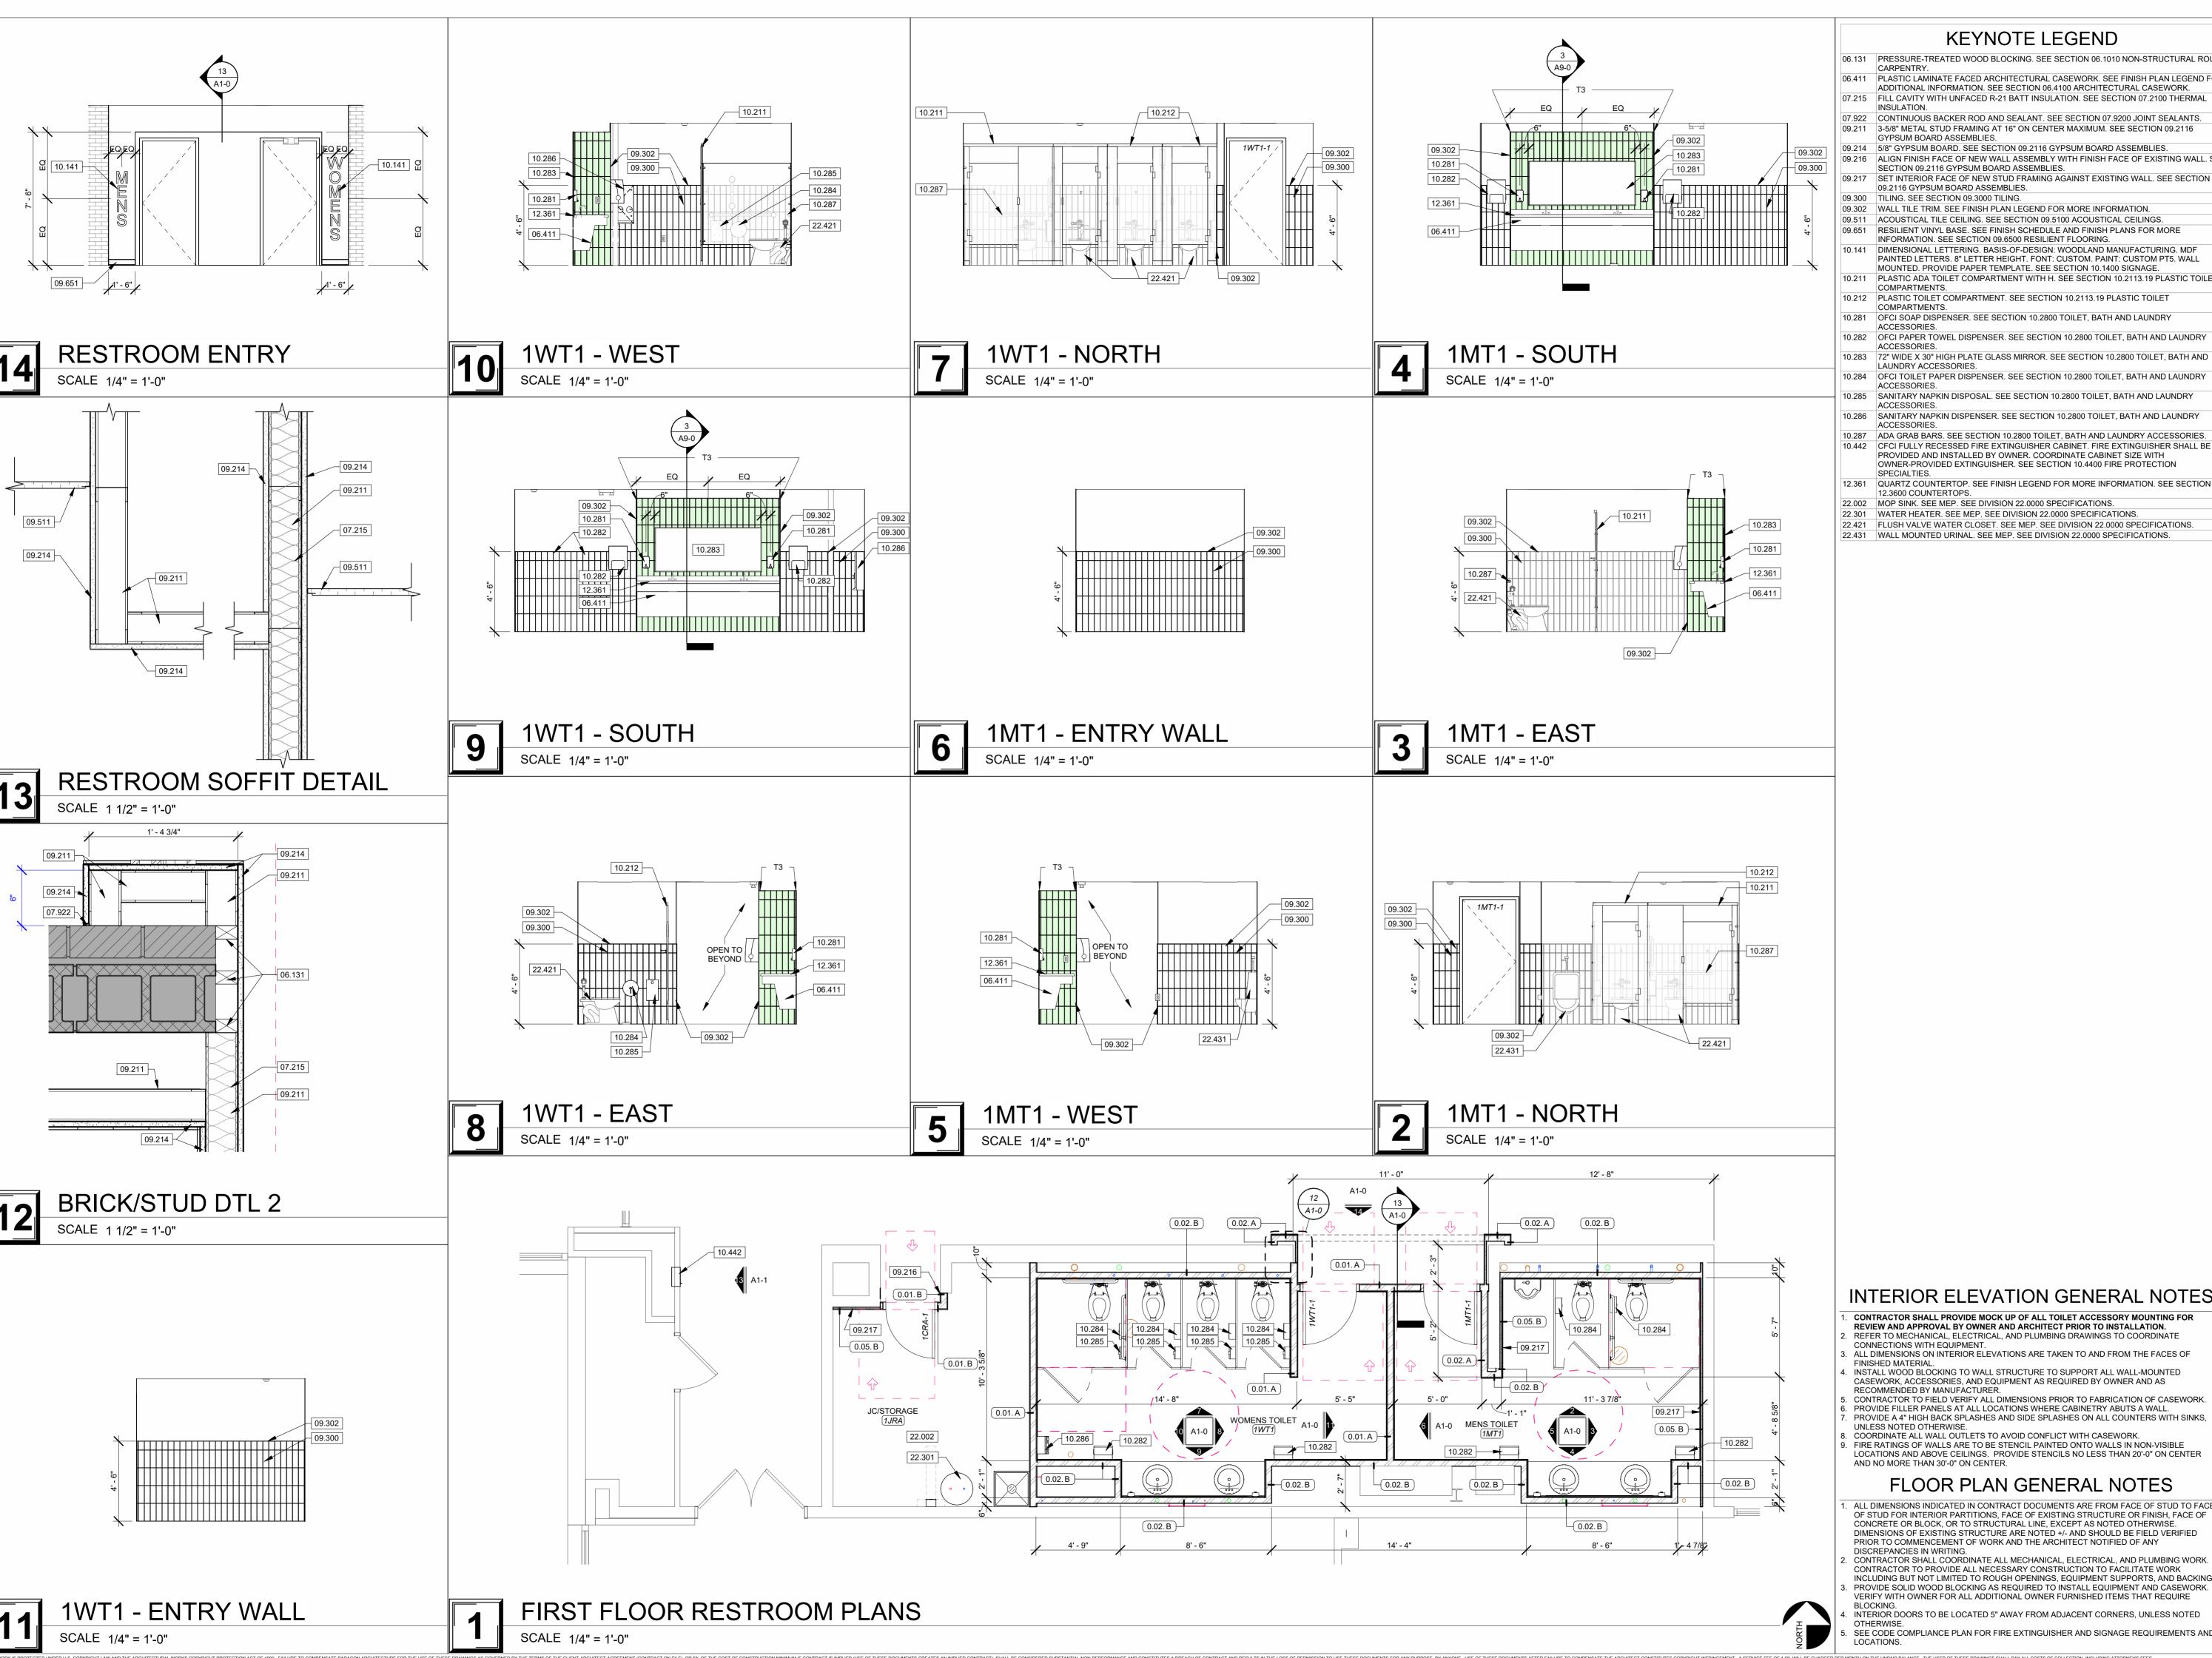

### **KEYNOTE LEGEND**

- 06.131 PRESSURE-TREATED WOOD BLOCKING. SEE SECTION 06.1010 NON-STRUCTURAL ROUGH 06.411 PLASTIC LAMINATE FACED ARCHITECTURAL CASEWORK. SEE FINISH PLAN LEGEND FOR
- ADDITIONAL INFORMATION. SEE SECTION 06.4100 ARCHITECTURAL CASEWORK. 07.215 FILL CAVITY WITH UNFACED R-21 BATT INSULATION. SEE SECTION 07.2100 THERMAL
- 07.922 CONTINUOUS BACKER ROD AND SEALANT. SEE SECTION 07.9200 JOINT SEALANTS. 09.211 3-5/8" METAL STUD FRAMING AT 16" ON CENTER MAXIMUM. SEE SECTION 09.2116
- GYPSUM BOARD ASSEMBLIES. 09.214 5/8" GYPSUM BOARD. SEE SECTION 09.2116 GYPSUM BOARD ASSEMBLIES. 09.216 ALIGN FINISH FACE OF NEW WALL ASSEMBLY WITH FINISH FACE OF EXISTING WALL. SEE
- SECTION 09.2116 GYPSUM BOARD ASSEMBLIES. SET INTERIOR FACE OF NEW STUD FRAMING AGAINST EXISTING WALL. SEE SECTION 09.2116 GYPSUM BOARD ASSEMBLIES.
- 09.300 TILING. SEE SECTION 09.3000 TILING. 09.302 WALL TILE TRIM. SEE FINISH PLAN LEGEND FOR MORE INFORMATION.
- 09.511 ACOUSTICAL TILE CEILING. SEE SECTION 09.5100 ACOUSTICAL CEILINGS. 09.651 RESILIENT VINYL BASE. SEE FINISH SCHEDULE AND FINISH PLANS FOR MORE INFORMATION. SEE SECTION 09.6500 RESILIENT FLOORING.
- PAINTED LETTERS. 8" LETTER HEIGHT. FONT: CUSTOM. PAINT: CUSTOM PT5. WALL MOUNTED. PROVIDE PAPER TEMPLATE. SEE SECTION 10.1400 SIGNAGE. 10.211 PLASTIC ADA TOILET COMPARTMENT WITH H. SEE SECTION 10.2113.19 PLASTIC TOILET
- 10.212 PLASTIC TOILET COMPARTMENT. SEE SECTION 10.2113.19 PLASTIC TOILET COMPARTMENTS 10.281 OFCI SOAP DISPENSER. SEE SECTION 10.2800 TOILET, BATH AND LAUNDRY
- 10.282 OFCI PAPER TOWEL DISPENSER. SEE SECTION 10.2800 TOILET, BATH AND LAUNDRY
- 10.283 72" WIDE X 30" HIGH PLATE GLASS MIRROR. SEE SECTION 10.2800 TOILET, BATH AND LAUNDRY ACCESSORIES. 10.284 OFCI TOILET PAPER DISPENSER. SEE SECTION 10.2800 TOILET, BATH AND LAUNDRY
- 10.285 SANITARY NAPKIN DISPOSAL. SEE SECTION 10.2800 TOILET, BATH AND LAUNDRY
- 10.286 SANITARY NAPKIN DISPENSER, SEE SECTION 10.2800 TOILET, BATH AND LAUNDRY ACCESSORIES. 10.287 ADA GRAB BARS. SEE SECTION 10.2800 TOILET, BATH AND LAUNDRY ACCESSORIES.
- 10.442 CFCI FULLY RECESSED FIRE EXTINGUISHER CABINET. FIRE EXTINGUISHER SHALL BE PROVIDED AND INSTALLED BY OWNER. COORDINATE CABINET SIZE WITH OWNER-PROVIDED EXTINGUISHER. SEE SECTION 10.4400 FIRE PROTECTION
- 12.361 QUARTZ COUNTERTOP. SEE FINISH LEGEND FOR MORE INFORMATION. SEE SECTION
- 22.002 MOP SINK. SEE MEP. SEE DIVISION 22.0000 SPECIFICATIONS. 22.301 WATER HEATER. SEE MEP. SEE DIVISION 22.0000 SPECIFICATIONS.
- 22.421 FLUSH VALVE WATER CLOSET. SEE MEP. SEE DIVISION 22.0000 SPECIFICATIONS. 22.431 WALL MOUNTED URINAL. SEE MEP. SEE DIVISION 22.0000 SPECIFICATIONS.

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MO #: A-2017019282

REVISION SCHEDULE XXXX-XX-XX

### CENTENNIAL HALL IMPROVEMEN AND RENOVATION

### INTERIOR ELEVATION GENERAL NOTES

- CONTRACTOR SHALL PROVIDE MOCK UP OF ALL TOILET ACCESSORY MOUNTING FOR REVIEW AND APPROVAL BY OWNER AND ARCHITECT PRIOR TO INSTALLATION. REFER TO MECHANICAL, ELECTRICAL, AND PLUMBING DRAWINGS TO COORDINATE
- ALL DIMENSIONS ON INTERIOR ELEVATIONS ARE TAKEN T INSTALL WOOD BLOCKING TO WALL STRUCTURE TO SUPPORT ALL WALL-MOUNTED
- CASEWORK, ACCESSORIES, AND EQUIPMENT AS REQUIRED BY OWNER AND AS RECOMMENDED BY MANUFACTURER. CONTRACTOR TO FIELD VERIFY ALL DIMENSIONS PRIOR TO FABRICATION OF CASEWORK.
- PROVIDE FILLER PANELS AT ALL LOCATIONS WHERE CABINETRY ABUTS A WALL. PROVIDE A 4" HIGH BACK SPLASHES AND SIDE SPLASHES ON ALL COUNTERS WITH SINKS, UNLESS NOTED OTHERWISE. COORDINATE ALL WALL OUTLETS TO AVOID CONFLICT WITH CASEWORK. FIRE RATINGS OF WALLS ARE TO BE STENCIL PAINTED ONTO WALLS IN NON-VISIBLE

### LOCATIONS AND ABOVE CEILINGS. PROVIDE STENCILS NO LESS THAN 20'-0" ON CENTER AND NO MORE THAN 30'-0" ON CENTER. FLOOR PLAN GENERAL NOTES

- ALL DIMENSIONS INDICATED IN CONTRACT DOCUMENTS ARE FROM FACE OF STUD TO FACE OF STUD FOR INTERIOR PARTITIONS, FACE OF EXISTING STRUCTURE OR FINISH, FACE OF CONCRETE OR BLOCK OR TO STRUCTURAL LINE EXCEPT AS NOTED OTHERWISE DIMENSIONS OF EXISTING STRUCTURE ARE NOTED +/- AND SHOULD BE FIELD VERIFIED PRIOR TO COMMENCEMENT OF WORK AND THE ARCHITECT NOTIFIED OF ANY DISCREPANCIES IN WRITING.
- CONTRACTOR SHALL COORDINATE ALL MECHANICAL, ELECTRICAL, AND PLUMBING WORK. CONTRACTOR TO PROVIDE ALL NECESSARY CONSTRUCTION TO FACILITATE WORK INCLUDING BUT NOT LIMITED TO ROUGH OPENINGS, EQUIPMENT SUPPORTS, AND BACKING.
- INTERIOR DOORS TO BE LOCATED 5" AWAY FROM ADJACENT CORNERS. UNLESS NOTED

FIRST FLOOR PLAN AND ELEVATIONS

EBP, CSM, KS

JY, EBP

SHEET NUMBER:

PROJECT ARCHITECT: JY

DRAWN BY:


22-703A

RC000638

08/28/2023

CHECKED BY:

PROJECT NUMBER:

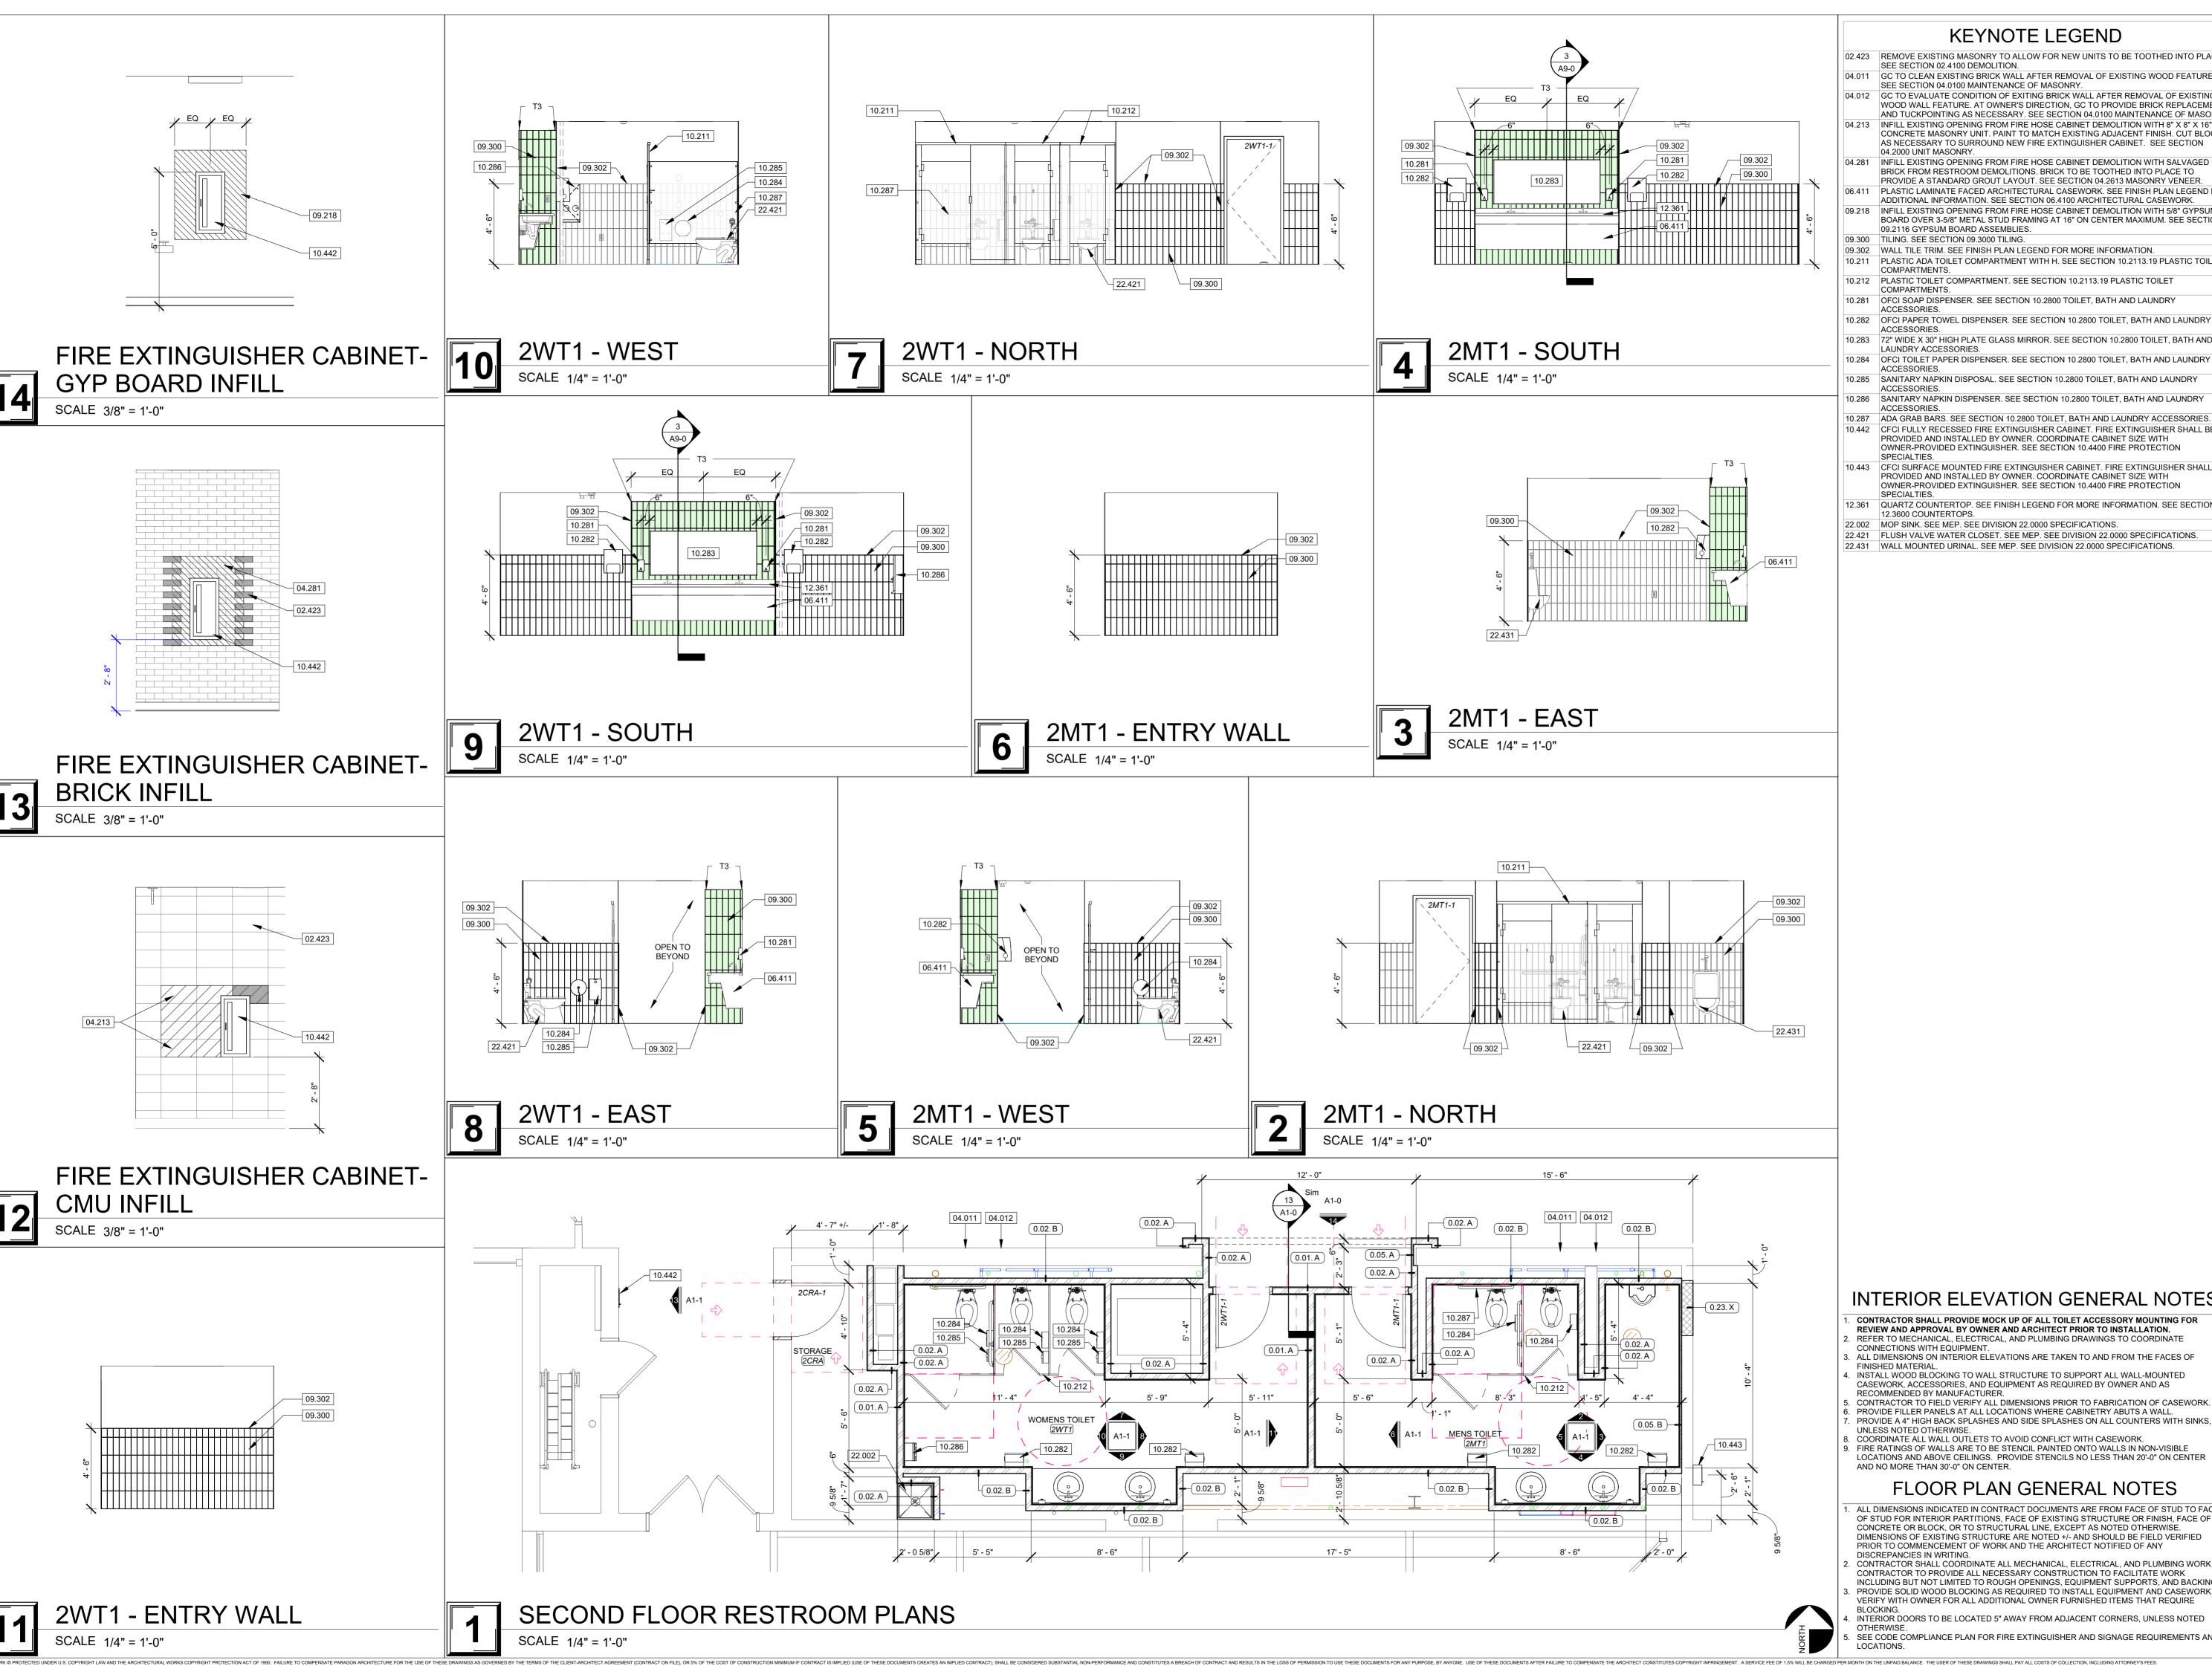

### **KEYNOTE LEGEND**

- 02.423 REMOVE EXISTING MASONRY TO ALLOW FOR NEW UNITS TO BE TOOTHED INTO PLACE SEE SECTION 02.4100 DEMOLITION. 04.011 GC TO CLEAN EXISTING BRICK WALL AFTER REMOVAL OF EXISTING WOOD FEATURE.
- SEE SECTION 04.0100 MAINTENANCE OF MASONRY. 04.012 GC TO EVALUATE CONDITION OF EXITING BRICK WALL AFTER REMOVAL OF EXISTING WOOD WALL FEATURE. AT OWNER'S DIRECTION, GC TO PROVIDE BRICK REPLACEMENT AND TUCKPOINTING AS NECESSARY. SEE SECTION 04.0100 MAINTENANCE OF MASONRY
- 04.213 INFILL EXISTING OPENING FROM FIRE HOSE CABINET DEMOLITION WITH 8" X 8" X 16" CONCRETE MASONRY UNIT. PAINT TO MATCH EXISTING ADJACENT FINISH. CUT BLOCK AS NECESSARY TO SURROUND NEW FIRE EXTINGUISHER CABINET. SEE SECTION 04.2000 UNIT MASONRY.
- 04.281 INFILL EXISTING OPENING FROM FIRE HOSE CABINET DEMOLITION WITH SALVAGED BRICK FROM RESTROOM DEMOLITIONS, BRICK TO BE TOOTHED INTO PLACE TO PROVIDE A STANDARD GROUT LAYOUT. SEE SECTION 04.2613 MASONRY VENEER. PLASTIC LAMINATE FACED ARCHITECTURAL CASEWORK. SEE FINISH PLAN LEGEND FOR ADDITIONAL INFORMATION. SEE SECTION 06.4100 ARCHITECTURAL CASEWORK. INFILL EXISTING OPENING FROM FIRE HOSE CABINET DEMOLITION WITH 5/8" GYPSUM
- BOARD OVER 3-5/8" METAL STUD FRAMING AT 16" ON CENTER MAXIMUM. SEE SECTION 09.2116 GYPSUM BOARD ASSEMBLIES. 09.300 TILING. SEE SECTION 09.3000 TILING.
- 09.302 WALL TILE TRIM. SEE FINISH PLAN LEGEND FOR MORE INFORMATION. 10.211 PLASTIC ADA TOILET COMPARTMENT WITH H. SEE SECTION 10.2113.19 PLASTIC TOILET
- 10.212 PLASTIC TOILET COMPARTMENT. SEE SECTION 10.2113.19 PLASTIC TOILET
- 10.281 OFCI SOAP DISPENSER. SEE SECTION 10.2800 TOILET, BATH AND LAUNDRY ACCESSORIES.
- ACCESSORIES. 10.283 72" WIDE X 30" HIGH PLATE GLASS MIRROR. SEE SECTION 10.2800 TOILET, BATH AND LAUNDRY ACCESSORIES.
- 10.284 OFCI TOILET PAPER DISPENSER. SEE SECTION 10.2800 TOILET, BATH AND LAUNDRY ACCESSORIES 10.285 SANITARY NAPKIN DISPOSAL. SEE SECTION 10.2800 TOILET, BATH AND LAUNDRY
- ACCESSORIES. 10.286 SANITARY NAPKIN DISPENSER. SEE SECTION 10.2800 TOILET, BATH AND LAUNDRY ACCESSORIES.
- 10.442 CFCI FULLY RECESSED FIRE EXTINGUISHER CABINET. FIRE EXTINGUISHER SHALL BE PROVIDED AND INSTALLED BY OWNER. COORDINATE CABINET SIZE WITH OWNER-PROVIDED EXTINGUISHER. SEE SECTION 10.4400 FIRE PROTECTION
- 10.443 CFCI SURFACE MOUNTED FIRE EXTINGUISHER CABINET. FIRE EXTINGUISHER SHALL BE PROVIDED AND INSTALLED BY OWNER. COORDINATE CABINET SIZE WITH OWNER-PROVIDED EXTINGUISHER. SEE SECTION 10.4400 FIRE PROTECTION
- 12.361 QUARTZ COUNTERTOP. SEE FINISH LEGEND FOR MORE INFORMATION. SEE SECTION 12.3600 COUNTERTOPS. 22.002 MOP SINK. SEE MEP. SEE DIVISION 22.0000 SPECIFICATIONS.
- 22.421 FLUSH VALVE WATER CLOSET. SEE MEP. SEE DIVISION 22.0000 SPECIFICATIONS. 22.431 WALL MOUNTED URINAL. SEE MEP. SEE DIVISION 22.0000 SPECIFICATIONS.



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### CENTENNIAL HALL IMPROVEMEN AND RENOVATION

### INTERIOR ELEVATION GENERAL NOTES

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- CONNECTIONS WITH EQUIPMENT. ALL DIMENSIONS ON INTERIOR ELEVATIONS AR FINISHED MATERIAL INSTALL WOOD BLOCKING TO WALL STRUCTURE TO SUPPORT ALL WALL-MOUNTED CASEWORK, ACCESSORIES, AND EQUIPMENT AS REQUIRED BY OWNER AND AS
- RECOMMENDED BY MANUFACTURER. CONTRACTOR TO FIELD VERIFY ALL DIMENSIONS PRIOR TO FABRICATION OF CASEWORK. PROVIDE FILLER PANELS AT ALL LOCATIONS WHERE CABINETRY ABUTS A WALL. PROVIDE A 4" HIGH BACK SPLASHES AND SIDE SPLASHES ON ALL COUNTERS WITH SINKS UNLESS NOTED OTHERWISE.
- COORDINATE ALL WALL OUTLETS TO AVOID CONFLICT WITH CASEWORK FIRE RATINGS OF WALLS ARE TO BE STENCIL PAINTED ONTO WALLS IN NON-VISIBLE LOCATIONS AND ABOVE CEILINGS. PROVIDE STENCILS NO LESS THAN 20'-0" ON CENTER AND NO MORE THAN 30'-0" ON CENTER.

### FLOOR PLAN GENERAL NOTES

- ALL DIMENSIONS INDICATED IN CONTRACT DOCUMENTS ARE FROM FACE OF STUD TO FACE OF STUD FOR INTERIOR PARTITIONS, FACE OF EXISTING STRUCTURE OR FINISH, FACE OF CONCRETE OR BLOCK OR TO STRUCTURAL LINE EXCEPT AS NOTED OTHERWISE DIMENSIONS OF EXISTING STRUCTURE ARE NOTED +/- AND SHOULD BE FIELD VERIFIED PRIOR TO COMMENCEMENT OF WORK AND THE ARCHITECT NOTIFIED OF ANY DISCREPANCIES IN WRITING.
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- INTERIOR DOORS T SEE CODE COMPLIANCE PLAN FOR FIRE EXTINGUISHER AND SIGNAGE REQUIREMENTS AND

SHEET NUMBER:

**ELEVATIONS** 

SECOND FLOOR

PROJECT ARCHITECT: JY

EBP, CSM, KS,

DRAWN BY:

22-703A


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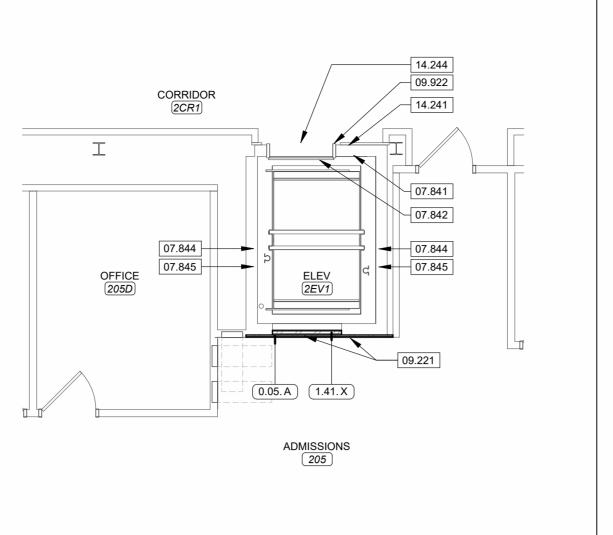
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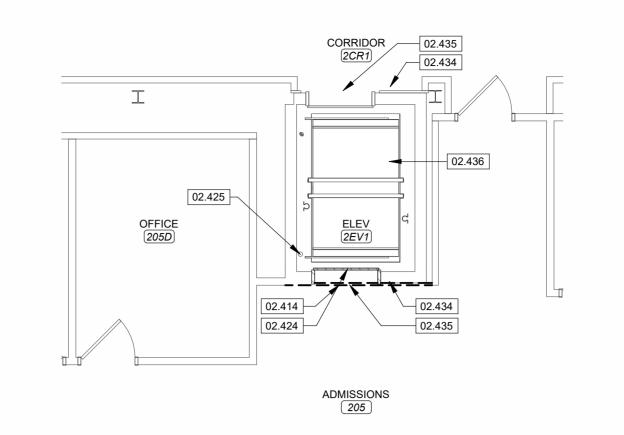
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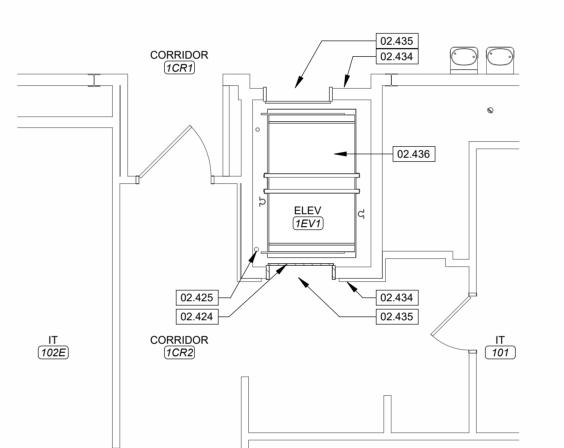
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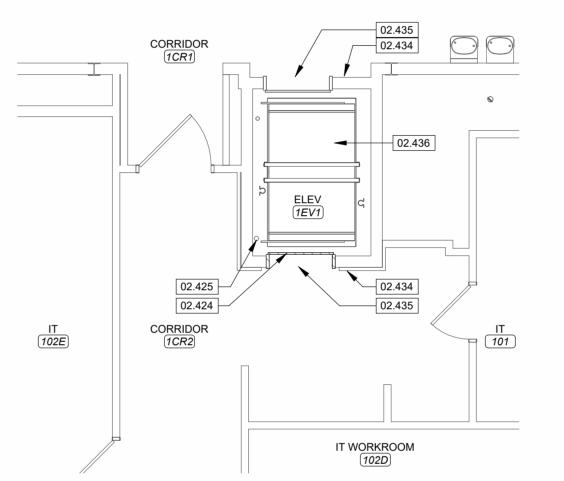




### SECOND LEVEL-**ELEVATOR DEMOLITION**



SCALE 3/16" = 1'-0"

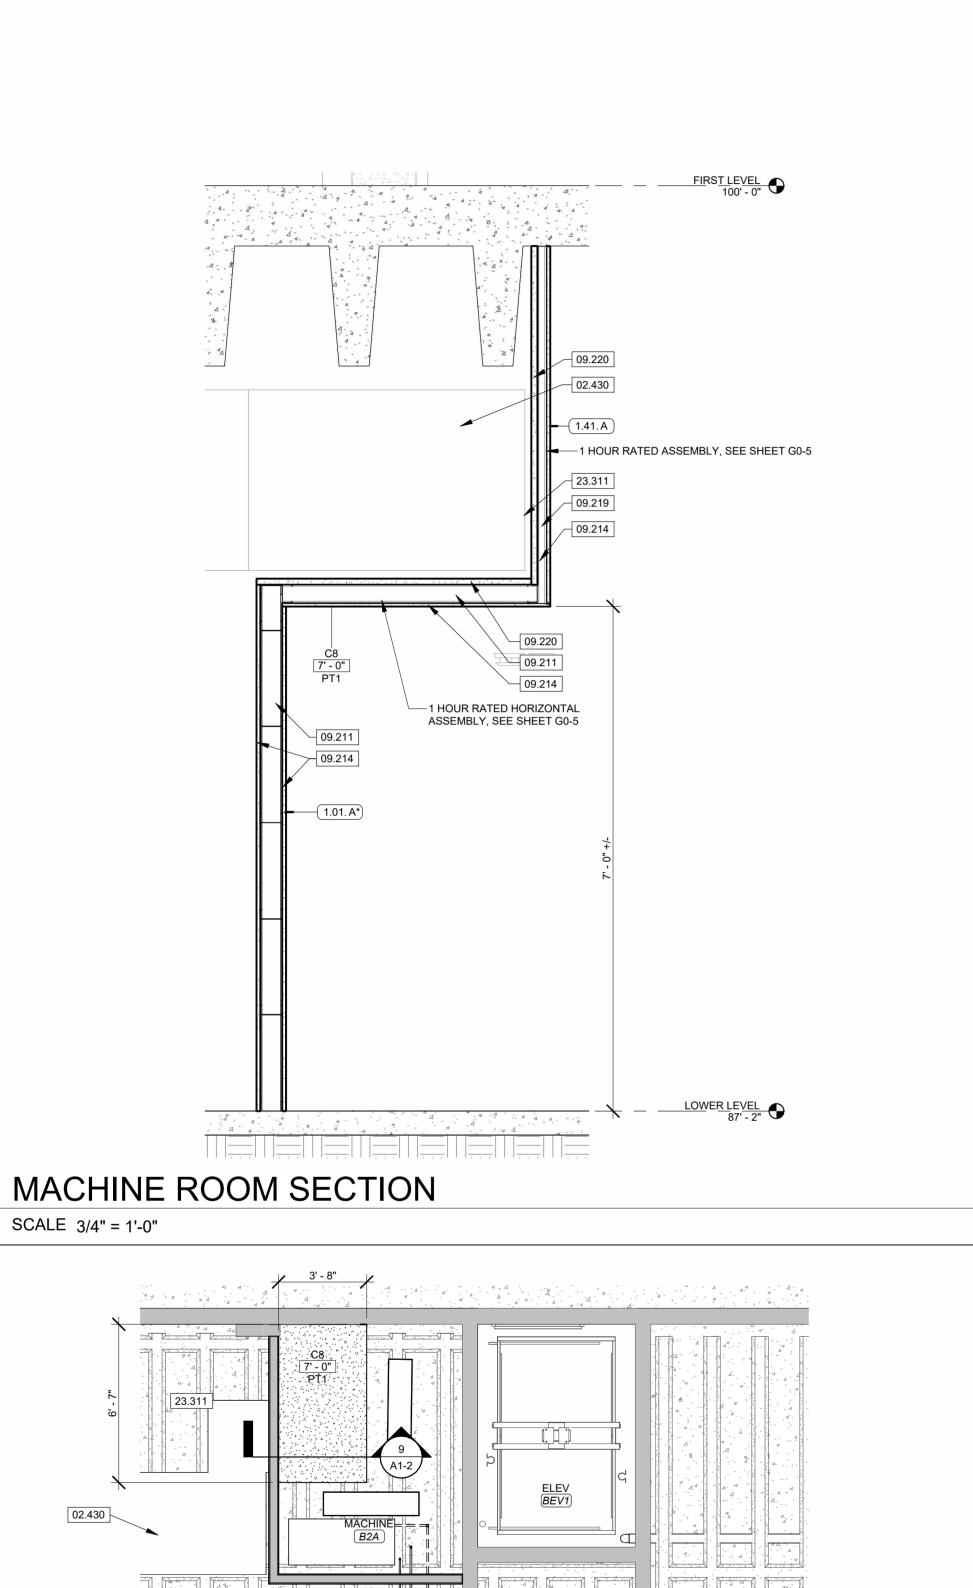

### **CEILING SCHEDULE**

1 HOUR FIRE RATED HORIZONTAL CEILING ASSEMBLY. 5/8" TYP X GYPSUM CEILING BOARD ON 2-1/2" METAL C-H STUD FRAMING AT 16 INCHES ON CENTER WITH 1" GYPSUM LINER PANEL.

FLOORING, COLOR: CHARCOA USE MANUFACTURER'S RECOMMENDATIONS FOR

URETHANE ADHESIVE FOR HEAVY USE. COORDINATE FINISH FLOOR +OF ELEVATOR CAB WITH FINISH

INSTALLATION. USE <sup>⊥</sup>MANUFACTURER'S U-705 <sup>†</sup>

**KEYNOTE LEGEND** 

02.414 REMOVE PORTION OF PARTITION. PREPARE ADJACENT SURFACE FOR NEW FINISH. SEE

02.424 REMOVE EXISTING REAR DOOR OF ELEVATOR. PREPARE ADJACENT SURFACES FOR

02.434 ELEVATOR SUPPLIER TO REMOVE EXISTING ELEVATOR CALL BUTTONS. SEE SECTION

02.435 ELEVATOR SUPPLIER TO REMOVE EXISTING ELEVATOR POSITION INDICATOR ABOVE

02.436 ELEVATOR SUPPLIER TO REMOVE EXISTING ELEVATOR CAR, ASSOCIATED MACHINERY, HOISTWAY COMPONENTS, DOOR SYSTEM, AND FIXTURES AS NOTED IN ELEVATOR

07.841 GC TO PROVIDE FIRE PROOFING AT BACK SIDE OF NEW HALL BUTTON BOXES AND POSITION INDICATORS TO MAINTAIN 1-HOUR FIRE RATING.. SEE SECTION 07.8400

MAINTAIN 1-HOUR FIRE RATING. SEE SECTION 07.8400 FIRESTOPPING. 07.843 GC TO PROVIDE FIRE PROOFING AT ALL ELEVATOR PIT PENETRATIONS TO MAINTAIN

07.842 GC TO PROVIDE FIRE PROOFING AT BACK SIDE OF ALL ELEVATOR HOIST WAY DOORS TO

GC TO PROVIDE FIRE PROOFING AT ALL HOISTWAY PENETRATIONS TO MAINTAIN

NOTIFY ARCHITECT AND OWNER IS DEFICIENCIES ARE DISCOVERED. GC TO PROVIDE

FIRE PROOFING AT T.O. EXISTING HOISTWAY WALL AS NECESSARY TO MAINTAIN 1-HOUR

07.845 GC TO VERIFY EXISTING HOISTWAY IS CONTINUOUS TO EXISTING ROOF DECK AND

09.211 3-5/8" METAL STUD FRAMING AT 16" ON CENTER MAXIMUM. SEE SECTION 09.2116

09.219 1-5/8" METAL STUD FRAMING AT 16" ON CENTER MAXIMUM. SEE SECTION 09.2116

09.220 1" GYPSUM BOARD SHAFT LINER PANELS. SEE SECTION 09.2116 GYPSUM BOARD

09.221 PATCH EXISTING WALL AS NEEDED WHERE EXISTING ELEVATOR CALL BUTTONS AND POSITION INDICATORS ARE REMOVED. SEE SECTION 09.2116 GYPSUM BOARD

09.922 PAINT LOBBY FRAME TO MATCH ADJACENT FINISH. SEE SECTION 09.9123 INTERIOR

10.444 CFCI FIRE EXTINGUISHER BRACKET. FIRE EXTINGUISHER SHALL BE PROVIDED AND

INSTALLED BY OWNER. COORDINATE BRACKET SIZE WITH OWNER-PROVIDED EXTINGUISHER. SEE SECTION 10.4400 FIRE PROTECTION SPECIALTIES.

CONTRACTOR TO PROVIDE OPENING FOR INSTALLATION OF NEW ELEVATOR CALL BUTTON FIXTURE WITH ELEVATOR SUPPLIER. GC TO VERIFY OPENING SIZE

CONTRACTOR TO COORDINATE WITH ELEVATOR MANUFACTURER FOR SIZE OF CUTS FROM MACHINE ROOM TO HOIST WAY FOR INSTALLATION OF ELEVATOR SUPPLY LINE. CONDUIT AND WIRING, CONTRACTOR TO SEAL HOLE AFTER INSTALLATION TO MAINTAIN 1-HOUR RATING OF ELEVATOR SHAFT. SEE SECTION 14.2400 HYDRAULIC SERVICE

INDICATOR ABOVE DOOR OPENING WITH ELEVATOR SUPPLIER. GC TO VERIFY OPENING SIZE REQUIREMENTS WITH SELECTED ELEVATOR SUPPLIER. SEE SECTION 14.2400

REQUIREMENTS WITH SELECTED ELEVATOR SUPPLIER. SEE SECTION 14.2400

14.243 GC TO PROVIDE NEW HAND GRIPS AT ELEVATOR PIT LADDER AS REQUIRED BY CODE

14.244 CONTRACTOR TO PROVIDE OPENING FOR INSTALLATION OF NEW ELEVATOR POSITION

23.311 VERIFY EXACT LOCATION OF DUCTWORK PRIOR TO INSTALLATION OF SHAFT WALL. SEE

10.441 EXISTING SURFACE MOUNTED FIRE EXTINGUISHER. SEE SECTION 10.4400 FIRE

09.214 5/8" GYPSUM BOARD. SEE SECTION 09.2116 GYPSUM BOARD ASSEMBLIES.

SPECIFICATION. SEE SECTION 02.4100 DEMOLITION AND SECTION 14.2400 HYDRAULIC

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ABANDONED FOLLOWING INSTALLATION OF NEW CONDUITS. SEE MEP FOR MORE

02.425 GC TO REMOVE EXISTING CONDUIT PIPING INSIDE OF ELEVATOR SHAFT TO BE

02.430 EXISTING METAL DUCT WORK TO REMAIN. PROTECT DUCTWORK DURING

SECTION 02.4100 DEMOLITION.

02.4100 DEMOLITION.

NEW FINISH. SEE SECTION 02.4100 DEMOLITION.

DOOR. SEE SECTION 02.4100 DEMOLITION.

SERVICE ELEVATOR RENOVATION

CONSTRUCTION. SEE SECTION 02.4100 DEMOLITION.

1-HOUR RATING. SEE SECTION 07.8400 FIRESTOPPING

1-HOUR RATING. SEE SECTION 07.8400 FIRESTOPPING

RATING. SEE SECTION 07.8400 FIRESTOPPING.

HYDRAULIC SERVICE ELEVATOR RENOVATION.

HYDRAULIC SERVICE ELEVATOR RENOVATION.

AND SELECTED ELEVATOR SUPPLIER.

DIVISION 23.0000 SPECIFICATIONS.

GYPSUM BOARD ASSEMBLIES.

GYPSUM BOARD ASSEMBLIES.

PROTECTION SPECIALTIES.

ELEVATOR RENOVATION.

ASSEMBLIES

### FIRST LEVEL-**ELEVATOR PLAN** SCALE 3/16" = 1'-0"

MACHINE E

SECOND LEVEL-

**ELEVATOR PLAN** 


SCALE 3/16" = 1'-0"




IT WORKROOM

FIRST LEVEL-**ELEVATOR DEMOLITION** SCALE 3/16" = 1'-0"



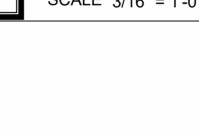

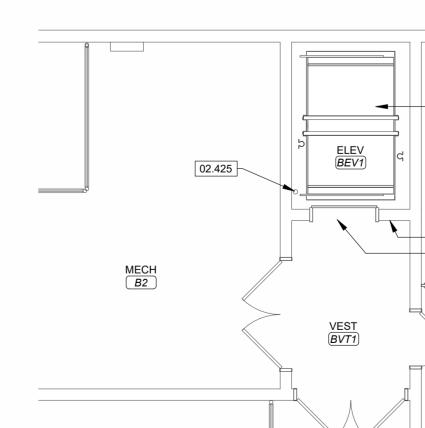

### **BASEMENT LEVEL-ELEVATOR DEMOLITION**

**ELEVATOR** 

### FINISH PLAN

SCALE 1/2" = 1'-0"





**ELEVATOR DETAILS** 

08/28/2023

CHECKED BY:

PROJECT NUMBER: 22-703A RC000638

EBP, CSM, KS

IMPROVEMENT

BASEMENT LEVEL-ELEVATOR MECHANICAL ROOM


02.436

REFLECTIVE CEILING PLAN-


MECHANICAL SPACE

SCALE 1/4" = 1'-0"

	DOOR AND FRAME SCHEDULE													
				DOC	)R				FRAME					
	OPE	OPENING PANEL										_		
DOOR				PANEL								HDWR		
NO.	WIDTH	HEIGHT	CONFIG	WIDTH	THICK	TYPE	MATL	FINISH	TYPE	MATL	FINISH	SET	RATING	COMMENTS
1CRA-1	2' - 9"	7' - 0"	SINGLE	2' - 9"	1 3/4"	F	WD	ST	F1	HM	PT	02		
1MT1-1	3' - 0"	7' - 0"	SINGLE	3' - 0"	1 3/4"	F	WD	ST	F1	HM	PT	01		
1WT1-1	3' - 0"	7' - 0"	SINGLE	3' - 0"	1 3/4"	F	WD	ST	F1	HM	PT	01		
2CRA-1	3' - 0"	7' - 0"	SINGLE	3' - 0"	1 3/4"	F	WD	ST	F2	НМ	PT	03		NEW DOOR AND FRAME IN EXISTING OPENING - VERIFY OPENING DIMENSIONS PRIOR TO ORDERING AND FABRICATION
2MT1-1	3' - 0"	7' - 0"	SINGLE	3' - 0"	1 3/4"	F	WD	ST	F1	HM	PT	01		
2WT1-1	3' - 0"	7' - 0"	SINGLE	3' - 0"	1 3/4"	F	WD	ST	F1	HM	PT	01		
B2A-1	3' - 6"	7' - 0"	SINGLE	3' - 6"	1 3/4"	F	HM	PT	F1	HM	PT	04	60 MIN.	

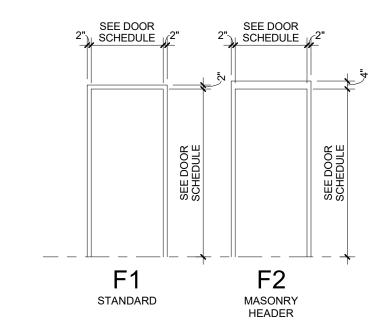

### DOOR FRAME LEGEND

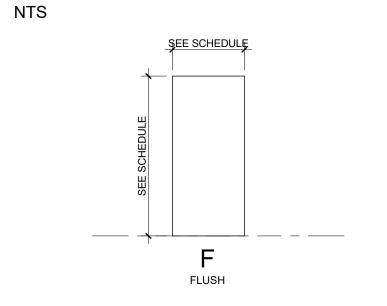

### DOOR TYPE LEGEND

NTS

### DOOR SCHEDULE LEGEND AND DOOR GENERAL NOTES


MATERIAL ABBREVIATIONS

HM HOLLOW METAL WD SOLID CORE WOOD

THIS WORK IS PROTECTED UNDER U.S. COPYRIGHT LAW AND THE ACRHITECT CONSTRUCTION ACT OF THESE DOCUMENTS AFTER FAILURE TO COMPENSATE THE ACRHITECT CONSTRUCTION ACT OF THESE DOCUMENTS FEED OCUMENTS AFTER FAILURE TO COMPENSATE THE ACRHITECT CONSTRUCTION ACT OF THESE DOCUMENTS AFTER FAILURE TO COMPENSATE THE ACRHITECT CONSTRUCTION ACT OF THESE DOCUMENTS AFTER FAILURE TO COMPENSATE THE ACRHITECT CONSTRUCTION ACT OF THESE DOCUMENTS AFTER FAILURE TO COMPENSATE THE ACRHITECT CONSTRUCTION ACT OF THESE DOCUMENTS AFTER FAILURE TO COMPENSATE THE ACRHITECT CONSTRUCTION ACT OF THESE DOCUMENTS AFTER FAILURE TO COMPENSATE THE ACRHITECT CONSTRUCTION ACT OF THESE DOCUMENTS AFTER FAILURE TO COMPENSATE THE ACRHITECT CONSTRUCTION ACT OF THESE DOCUMENTS AFTER FAILURE TO COMPENSATE THE ACRHITECT CONSTRUCTION ACT OF THESE DOCUMENTS AFTER FAILURE TO COMPENSATE THE ACRHITECT CONSTRUCTION ACT OF THESE DOCUMENTS AFTER FAILURE TO COMPENSATE THE ACRHITECT CONSTRUCTION ACT OF THE COST OF THESE DOCUMENTS AFTER FAILURE TO COMPENSATE THE ACRHITECT CONSTRUCTION ACT OF THE COST OF TH


AL ALUMINUM FRAMED
GENERAL NOTES:

- GLAZING IN DOORS AND WINDOWS TAGGED WITH A "T" ARE TO BE TEMPERED GLASS.
   ALL GLASS IN DOORS, ADJACENT, OR WITHIN 12" OF DOORS HORIZONTALLY, OR WITHIN 36" OF STAIRS, OR CLOSER THAN 18" TO FLOOR TO BE TEMPERED PER THE APPLICABLE VERSION OF INTERNATIONAL BUILDING CODE.
- REFER TO A6 SHEETS FOR HEAD, JAMB, AND SILL DETAILS UNLESS NOTED OTHERWISE.
   REFER TO ELECTRICAL WIRING DIAGRAMS OF POWERED OPENINGS AND POWERED HARDWARE FOR ADDITIONAL INFORMATION.

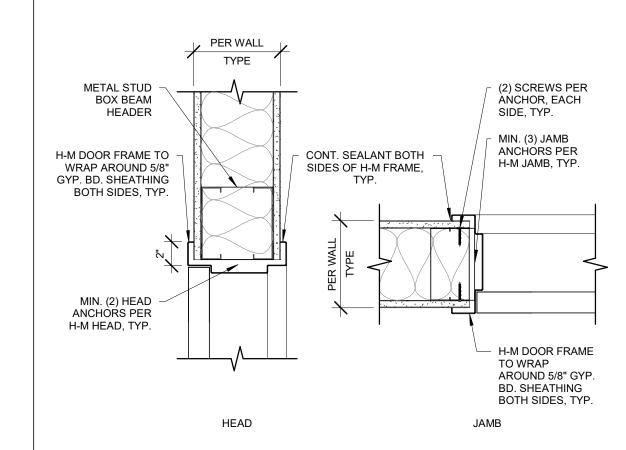


3 HM DOOR FRAME METAL STUD

SCALE 1 1/2" = 1'-0"

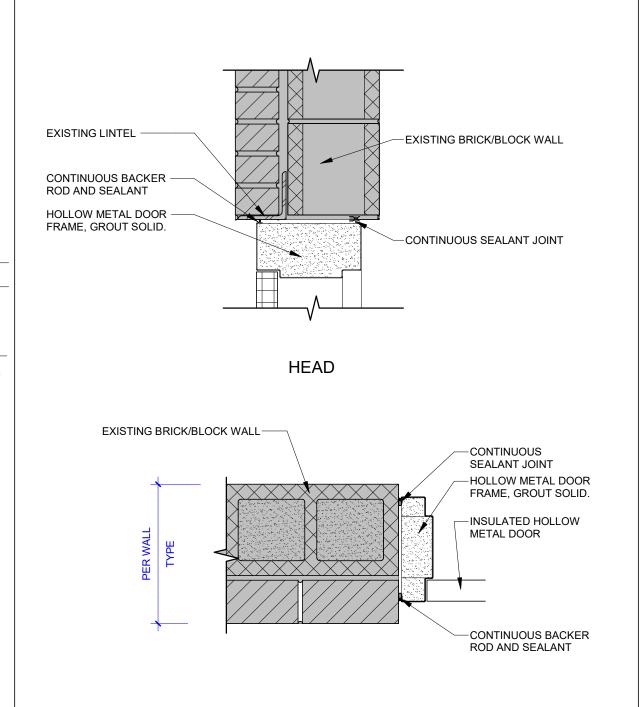

### HM DOOR FRAME @ BRICK/CMU

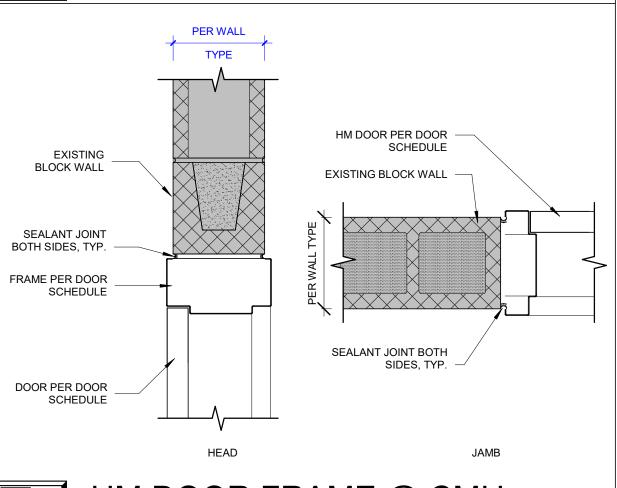

HM DOOR FRAME @ CMU

KEYNOTE LEGEND



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JARED A.

\* YOUNGLOVE

NUMBER

A-2017019282

8.28.23

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CENTENNIAL HALL IMPROVEMENTS
AND RENOVATION

PROJECT ARCHITECT: JY
DRAWN BY: EBP, CSM, KS
CHECKED BY: JY, EBP

PROJECT NUMBER: 22-703A RC000638

08/28/2023

DOOR SCHEDULE AND INFORMATION

SHEET NUMBER:

A6-0

BREAK ROOM

IT WORKROOM

RECEIVING

IT OFFICE

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MEP ENGINEER RTM ENGINEERING CONSULTANTS 3333 E. BATTLEFIELD RD, SUITE 1000 SPRINGFIELD, MISSOURI 65804

417.881.0020 **ELEVATOR CONSULTANT** ATIS 600 EMERSON RD, SUITE 225 CREVE COEUR, MISSOURI 63141 314.441.3999

**CIVIL ENGINEER** ARCHER-ELGIN 310 E. 6TH STREET ROLLA, MISSOURI 65401 573.364.6362

> JARED A. JARED A. YOUNGLOVE, ARCHITECT MO #: A-2017019282

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REVISION SCHEDULE

### IMPROVEMEN

### **CEILING SCHEDULE**

2X2 ACOUSTICAL CEILING TILE. GYPSUM BOARD SOFFIT ON METAL STUD FRAMING. REFER TO TYPICAL SOFFIT DETAILS FOR MORE INFORMATION.

### REFLECTED CEILING PLAN LEGEND

C1 CEILING TYPE 9' - 0" ELEVATION OF CEILING ABOVE FINISH FLOOR PT1 CEILING FINISH PAINT COLOR (IF INDICATED)

### RCP PARTITION: TOP OF WALL CONDITIONS

<u>FRAMING TO DECK:</u> WALL FRAMING EXTENDS TO ROOF DECKING. REFER TO WALL PARTITION TAG AND PARTITION LEGEND FOR

<u>UNATTACHED FRAMING:</u> WALL FRAMING REMAINS UNATTACHED FROM ROOF DECKING. REFER TO WALL PARTITION TAG AND PARTITION LEGEND FOR MORE INFORMATION.

### RCP GENERAL NOTES

- . ALL EXPOSED GYPSUM BOARD CEILINGS, SOFFITS, AND BULKHEADS ARE TO BE PAINTED. REFER TO FINISH LEGEND FOR MORE INFORMATION ON PAINT COLOR(S) IDENTIFIED BY CEILING TAGS.
- PROVIDE APPROPRIATE FINISH AND/OR TRIM AT ALL PENETRATIONS IN WALLS, FLOORS, AND AT EXPOSED FINISH CEILING LOCATIONS. CONTRACTOR SHALL PROVIDE SEALANT AND BACKER ROD AT ALL MINOR GAPS AND AT EXPOSED PENETRATIONS. WHERE LARGE GAPS OR ROUGH CUT PENETRATIONS OCCUR THE CONTRACTOR SHALL PROVIDE SHEET METAL TRIM AS NECESSARY FOR A FINISHED APPEARANCE. PAINT TRIM AND SEALANTS TO MATCH ADJACENT WALL FINISHES AND/OR CEILING FINISHES. COORDINATE PAINT COLOR



- 2. ALL STRUCTURE, FRAMING, DUCTWORK, MECHANICAL, AND ELECTRICAL ITEMS EXPOSED TO VIEW ARE TO BE PAINTED WITH DRYFALL PAINT UNLESS NOTED OTHERWISE. CEILING HEIGHT ELEVATIONS ARE NOTED FROM THE FINISH FLOOR OF THE CORRESPONDING LEVEL. COORDINATE REFLECTED CEILING PLAN WITH LIGHTING, MECHANICAL, AND PLUMBING PLANS. COORDINATE LIGHT FIXTURES AND DIFFUSER PLACEMENT. CONTACT ARCHITECT IF DISCREPANCIES ARE FOUND AND DOCUMENT IN
- . LIGHTING AND EXPOSED MECHANICAL EQUIPMENT SHOWN FOR REFERENCE ONLY. REFER TO MECHANICAL, ELECTRICAL, AND PLUMBING SERIES SHEETS FOR ADDITIONAL
- WITH ARCHITECT.

PROJECT ARCHITECT: JY DRAWN BY: EBP, CSM, KS CHECKED BY: JY, EBP

PROJECT NUMBER: 22-703A RC000638

08/28/2023

**CEILING PLAN** 

SHEET NUMBER:



OFFICE (106E)

DIMOMENS TOILET

NEW STUDENT PROGRAMS

STOR////STOR/

MAKERSPACE

VESTIBULE

VESTIBULE

(1VT2)

MENS TOILET

OFFICE ENTRY

STORAGE 102E1

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OFFICE

213A

ENROLLMENT

MANGEMENT 213

OFFICE (213B)

STAIR 2ST2

CONFERENCE

TEACHER ED

OFFICE

OFFICE 214A

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637 COLLEGE STREET SPRINGFIELD, MO 65806

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CREVE COEUR, MISSOURI 63141 314.441.3999 **CIVIL ENGINEER** ARCHER-ELGIN 310 E. 6TH STREET ROLLA, MISSOURI 65401

JARED A. YOUNGLOVE, ARCHITECT MO #: A-2017019282

REVISION SCHEDULE

### **CEILING SCHEDULE**

2X2 ACOUSTICAL CEILING TILE.
GYPSUM BOARD SOFFIT ON METAL STUD FRAMING. REFER TO TYPICAL SOFFIT DETAILS FOR MORE INFORMATION.

### REFLECTED CEILING PLAN LEGEND

C1 CEILING TYPE PT1 CEILING FINISH PAINT COLOR (IF INDICATED)

### RCP PARTITION: TOP OF WALL CONDITIONS

FRAMING TO DECK: WALL FRAMING EXTENDS TO ROOF DECKING. REFER TO WALL PARTITION TAG AND PARTITION LEGEND FOR MORE INFORMATION.

<u>UNATTACHED FRAMING:</u> WALL FRAMING REMAINS UNATTACHED FROM ROOF DECKING. REFER TO WALL PARTITION TAG AND PARTITION LEGEND FOR MORE INFORMATION.

### RCP GENERAL NOTES

- 1. ALL EXPOSED GYPSUM BOARD CEILINGS, SOFFITS, AND BULKHEADS ARE TO BE PAINTED. REFER TO FINISH LEGEND FOR MORE INFORMATION ON PAINT COLOR(S) IDENTIFIED BY
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- TO MECHANICAL, ELECTRICAL, AND PLUMBING SERIES SHEETS FOR ADDITIONAL INFORMATION. PROVIDE APPROPRIATE FINISH AND/OR TRIM AT ALL PENETRATIONS IN WALLS, FLOORS, AND AT EXPOSED FINISH CEILING LOCATIONS. CONTRACTOR SHALL PROVIDE SEALANT AND BACKER ROD AT ALL MINOR GAPS AND AT EXPOSED PENETRATIONS. WHERE LARGE GAPS OR ROUGH CUT PENETRATIONS OCCUR THE CONTRACTOR SHALL PROVIDE SHEET METAL TRIM AS NECESSARY FOR A FINISHED APPEARANCE. PAINT TRIM AND SEALANTS TO MATCH ADJACENT WALL FINISHES AND/OR CEILING FINISHES. COORDINATE PAINT COLOR

- MECHANICAL, AND PLUMBING PLANS. COORDINATE LIGHT FIXTURES AND DIFFUSER PLACEMENT. CONTACT ARCHITECT IF DISCREPANCIES ARE FOUND AND DOCUMENT IN LIGHTING AND EXPOSED MECHANICAL EQUIPMENT SHOWN FOR REFERENCE ONLY. REFER
- WITH ARCHITECT.

### IMPROVEMENT

PROJECT ARCHITECT: JY DRAWN BY: EBP, CSM, KS CHECKED BY:

PROJECT NUMBER: 22-703A RC000638

DATE: 08/28/2023

SECOND FLOOR **CEILING PLAN** 

SHEET NUMBER:

**A8-1** 

REFLECTED CEILING PLAN SECOND LEVEL

OFFICE 202A

OFFICE 216E

WORK 216C

OFFICE 202F

OFFICE 202E

OFFICE 202D

OFFICE 205K

GRADUATE EDUCATION

OFFICE 216D

OFFICE 216C1

STEM CENTER

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SCALE 1/8" = 1'-0"

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> JARED A. YOUNGLOVE NUMBER JARED A. YOUNGLOVE, ARCHITECT MO #: A-2017019282

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REVISION SCHEDULE

**IMPROVEMEN** 

PROJECT ARCHITECT: JY DRAWN BY: EBP, CSM, KS CHECKED BY: JY, EBP

PROJECT NUMBER: 22-703A RC000638

08/28/2023

LOWER LEVEL **MEZZANINE** REFLECTED CP

SHEET NUMBER: **A8-2** 



WOMENS TOILET MENS TOILET 2CRA

ENLARGED CEILING PLAN SECOND FLOOR - RESTROOM

SCALE 3/16" = 1'-0"


-EXISTING ROOF FRAMING -

CONCRETE ON METAL DECK

1. ALL LEVEL ELEVATIONS ARE PULLED FROM EXISTING BUILDING DRAWINGS

GENERALLY IDENTIFIED THROUGH EXISTING DRAWINGS PROVIDED BY OWNER AND VISUAL INSPECTION. CONTRACTOR TO VERIFY CONSTRUCTION AT ALL AFFECTED

PROVIDED BY OWNER. CONTRACTOR TO VERIFY HEIGHTS PRIOR TO WORK. 2. FLOOR AND ROOF FRAMING HAS BEEN

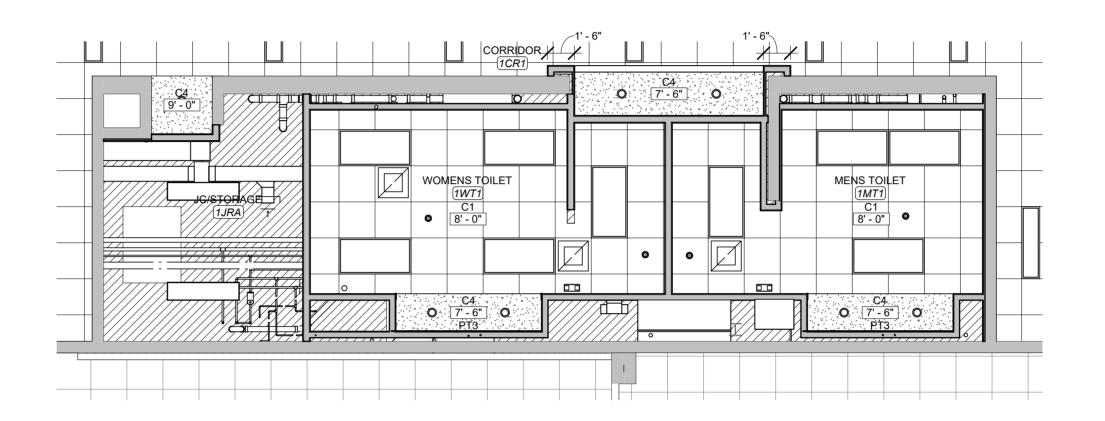

ENLARGED CEILING PLAN FIRST FLOOR - RESTROOM SCALE 3/16" = 1'-0"

FLOOR HEIGHT SECTIONAL DIAGRAM

135' - 1 3/8" HIGH

EXISTING ROOF FRAMING -METAL DECK ON WIDE FLANGE BEAMS OVER MEZZANINE SPACE

EXSITING MEZZANINE FRAMING -

CONCRETE FLOOR SLAB ON

MEZZANINE LEVEL 125' - 2 7/8"

SECOND LEVEL 115' - 1 3/8"

EXISTING SECOND FLOOR FRAMING - CONCRETE FLOOR SLAB WITH METAL DECKING


EXISTING FIRST FLOOR ABOVE **BASEMENT - CONCRETE** 

WAFFLE SLAB

ON BAR JOISTS

METAL DECKING ON WIDE

FLANGE BEAMS

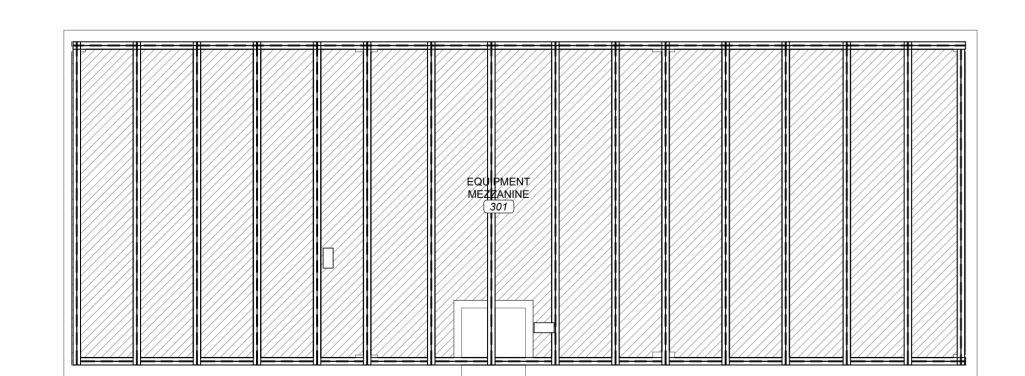

CEILING SCHEDULE

2X2 ACOUSTICAL CEILING TILE.

GYPSUM BOARD SOFFIT ON METAL STUD FRAMING. REFER TO TYPICAL SOFFIT DETAILS FOR MORE INFORMATION. 1 HOUR FIRE RATED HORIZONTAL CEILING ASSEMBLY. 5/8" TYP X GYPSUM CEILING BOARD ON 2-1/2" METAL C-H STUD FRAMING AT 16 INCHES ON CENTER WITH 1" GYPSUM LINER PANEL.

REFLECTED CEILING PLAN LEGEND

C1 CEILING TYPE 9' - 0" ELEVATION OF CEILING ABOVE FINISH FLOOR PT1 CEILING FINISH PAINT COLOR (IF INDICATED)

RCP PARTITION: TOP OF WALL CONDITIONS

FRAMING TO DECK: WALL FRAMING EXTENDS TO ROOF DECKING. REFER TO WALL PARTITION TAG AND PARTITION LEGEND FOR

<u>UNATTACHED FRAMING:</u> WALL FRAMING REMAINS UNATTACHED FROM ROOF DECKING. REFER TO WALL PARTITION TAG AND PARTITION LEGEND FOR MORE INFORMATION.

RCP GENERAL NOTES

ALL EXPOSED GYPSUM BOARD CEILINGS, SOFFITS, AND BULKHEADS ARE TO BE PAINTED. REFER TO FINISH LEGEND FOR MORE INFORMATION ON PAINT COLOR(S) IDENTIFIED BY

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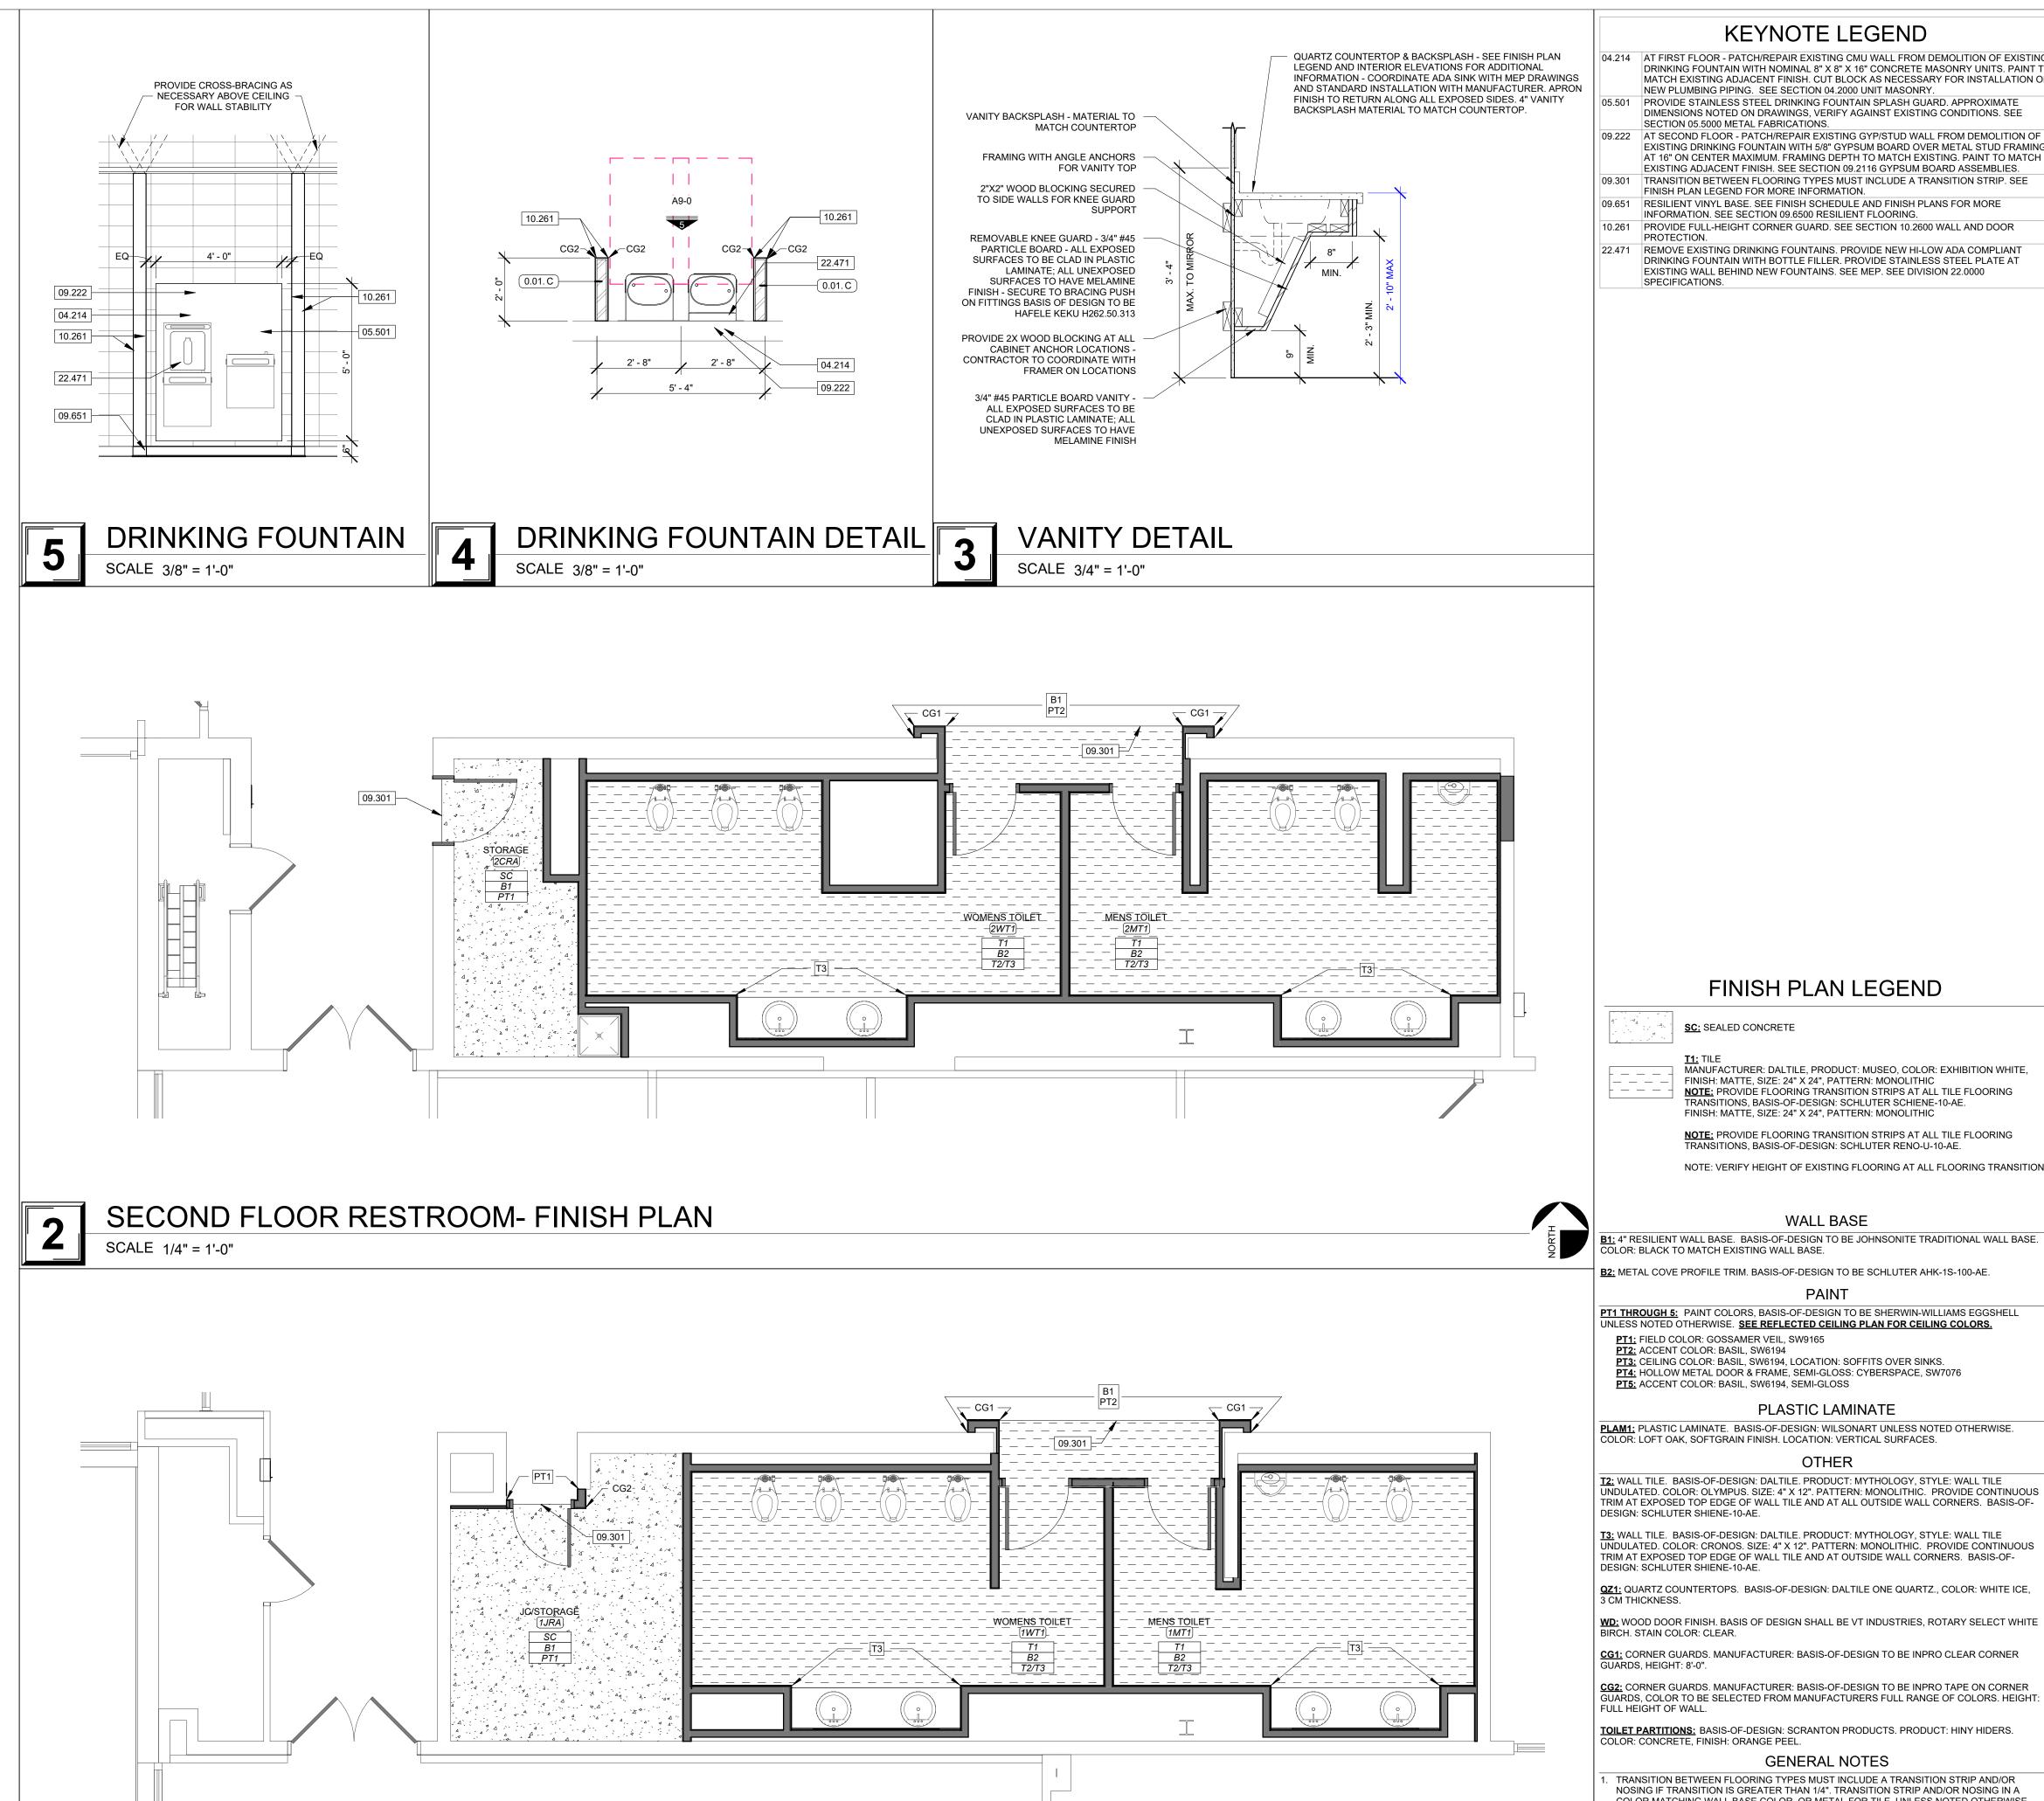
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REFLECTED CEILING PLAN MEZZANINE

REFLECTED CEILING PLAN LOWER LEVEL

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IS OF THE CLIENT-ARCHITECT AGREEMENT (CONTRACT ON FILE), OR 5% OF THE COST OF CONSTRUCTION MINIMUM IF CONTRACT IS IMPLIED (USE OF THESE DOCUMENTS FEES DOCUMENTS FOR ANY PURPOSE, BY ANYONE. USE OF THESE DOCUMENTS FOR ANY PURPOSE, BY ANYONE. USE OF THESE DOCUMENTS FOR ANY PURPOSE, BY ANYONE. USE OF THESE DOCUMENTS FOR ANY PURPOSE, BY ANYONE. USE OF THESE DOCUMENTS FOR ANY PURPOSE, BY ANYONE. USE OF THESE DOCUMENTS FOR ANY PURPOSE, BY ANYONE. USE OF THESE DOCUMENTS FOR ANY PURPOSE, BY ANYONE. USE OF THESE DOCUMENTS FOR ANY PURPOSE, BY ANYONE. USE OF THESE DOCUMENTS A BREACH OF CONSTRUCTION, INCLUDING ATTORNEYS FEES.

FIRST FLOOR RESTROOM- FINISH PLANS

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### **KEYNOTE LEGEND**

- 04.214 AT FIRST FLOOR PATCH/REPAIR EXISTING CMU WALL FROM DEMOLITION OF EXISTING DRINKING FOUNTAIN WITH NOMINAL 8" X 8" X 16" CONCRETE MASONRY UNITS. PAINT TO MATCH EXISTING ADJACENT FINISH. CUT BLOCK AS NECESSARY FOR INSTALLATION OF NEW PLUMBING PIPING. SEE SECTION 04.2000 UNIT MASONRY
- PROVIDE STAINLESS STEEL DRINKING FOUNTAIN SPLASH GUARD. APPROXIMATE DIMENSIONS NOTED ON DRAWINGS, VERIFY AGAINST EXISTING CONDITIONS. SEE SECTION 05.5000 METAL FABRICATIONS.
- 09.222 AT SECOND FLOOR PATCH/REPAIR EXISTING GYP/STUD WALL FROM DEMOLITION OF EXISTING DRINKING FOUNTAIN WITH 5/8" GYPSUM BOARD OVER METAL STUD FRAMING AT 16" ON CENTER MAXIMUM. FRAMING DEPTH TO MATCH EXISTING. PAINT TO MATCH EXISTING ADJACENT FINISH. SEE SECTION 09.2116 GYPSUM BOARD ASSEMBLIES.
- TRANSITION BETWEEN FLOORING TYPES MUST INCLUDE A TRANSITION STRIP. SEE FINISH PLAN LEGEND FOR MORE INFORMATION.
- RESILIENT VINYL BASE. SEE FINISH SCHEDULE AND FINISH PLANS FOR MORE INFORMATION. SEE SECTION 09.6500 RESILIENT FLOORING. 10.261 PROVIDE FULL-HEIGHT CORNER GUARD. SEE SECTION 10.2600 WALL AND DOOR
- PROTECTION. 22.471 REMOVE EXISTING DRINKING FOUNTAINS. PROVIDE NEW HI-LOW ADA COMPLIANT DRINKING FOUNTAIN WITH BOTTLE FILLER. PROVIDE STAINLESS STEEL PLATE AT EXISTING WALL BEHIND NEW FOUNTAINS. SEE MEP. SEE DIVISION 22.0000



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REVISION SCHEDULE

EM

IMPR(

### FINISH PLAN LEGEND

**SC:** SEALED CONCRETE

MANUFACTURER: DALTILE, PRODUCT: MUSEO, COLOR: EXHIBITION WHITE, FINISH: MATTE, SIZE: 24" X 24", PATTERN: MONOLITHIC NOTE: PROVIDE FLOORING TRANSITION STRIPS AT ALL TILE FLOORING TRANSITIONS, BASIS-OF-DESIGN: SCHLUTER SCHIENE-10-AE. FINISH: MATTE, SIZE: 24" X 24", PATTERN: MONOLITHIC

NOTE: PROVIDE FLOORING TRANSITION STRIPS AT ALL TILE FLOORING TRANSITIONS, BASIS-OF-DESIGN: SCHLUTER RENO-U-10-AE. NOTE: VERIFY HEIGHT OF EXISTING FLOORING AT ALL FLOORING TRANSITIONS

### WALL BASE

<u>B1:</u> 4" RESILIENT WALL BASE. BASIS-OF-DESIGN TO BE JOHNSONITE TRADITIONAL WALL BASE. COLOR: BLACK TO MATCH EXISTING WALL BASE.

PT1 THROUGH 5: PAINT COLORS, BASIS-OF-DESIGN TO BE SHERWIN-WILLIAMS EGGSHELL UNLESS NOTED OTHERWISE. **SEE REFLECTED CEILING PLAN FOR CEILING COLORS.** PT1: FIELD COLOR: GOSSAMER VEIL, SW9165

PT3: CEILING COLOR: BASIL, SW6194, LOCATION: SOFFITS OVER SINKS.
PT4: HOLLOW METAL DOOR & FRAME, SEMI-GLOSS: CYBERSPACE, SW7076
PT5: ACCENT COLOR: BASIL, SW6194, SEMI-GLOSS

### PLASTIC LAMINATE

**PLAM1:** PLASTIC LAMINATE. BASIS-OF-DESIGN: WILSONART UNLESS NOTED OTHERWISE. COLOR: LOFT OAK, SOFTGRAIN FINISH. LOCATION: VERTICAL SURFACES.

### OTHER

T2: WALL TILE. BASIS-OF-DESIGN: DALTILE. PRODUCT: MYTHOLOGY, STYLE: WALL TILE UNDULATED. COLOR: OLYMPUS. SIZE: 4" X 12". PATTERN: MONOLITHIC. PROVIDE CONTINUOUS TRIM AT EXPOSED TOP EDGE OF WALL TILE AND AT ALL OUTSIDE WALL CORNERS. BASIS-OF-DESIGN: SCHLUTER SHIENE-10-AE.

T3: WALL TILE. BASIS-OF-DESIGN: DALTILE. PRODUCT: MYTHOLOGY, STYLE: WALL TILE UNDULATED. COLOR: CRONOS. SIZE: 4" X 12". PATTERN: MONOLITHIC. PROVIDE CONTINUOUS TRIM AT EXPOSED TOP EDGE OF WALL TILE AND AT OUTSIDE WALL CORNERS. BASIS-OF-DESIGN: SCHLUTER SHIENE-10-AE.

QZ1: QUARTZ COUNTERTOPS. BASIS-OF-DESIGN: DALTILE ONE QUARTZ., COLOR: WHITE ICE,


WD: WOOD DOOR FINISH. BASIS OF DESIGN SHALL BE VT INDUSTRIES, ROTARY SELECT WHITE

CG1: CORNER GUARDS. MANUFACTURER: BASIS-OF-DESIGN TO BE INPRO CLEAR CORNER GUARDS, HEIGHT: 8'-0". CG2: CORNER GUARDS. MANUFACTURER: BASIS-OF-DESIGN TO BE INPRO TAPE ON CORNER

TOILET PARTITIONS: BASIS-OF-DESIGN: SCRANTON PRODUCTS. PRODUCT: HINY HIDERS. COLOR: CONCRETE, FINISH: ORANGE PEEL.

### GENERAL NOTES

- TRANSITION BETWEEN FLOORING TYPES MUST INCLUDE A TRANSITION STRIP AND/OR NOSING IF TRANSITION IS GREATER THAN 1/4". TRANSITION STRIP AND/OR NOSING IN A COLOR MATCHING WALL BASE COLOR, OR METAL FOR TILE, UNLESS NOTED OTHERWISE. REVIEW AND RECEIVE WRITTEN APPROVAL FOR ALL GRAPHICS WITH ARCHITECT AND OWNER OF WALL COVERINGS AND VINYL FILM BEFORE ORDERING.
- . REFER TO REFLECTED CEILING PLAN FOR ADDITIONAL FINISH INFORMATION. I. FIELD FLOOR FINISH NOTATED WITHIN FINISH TAG. ACCENT FLOOR FINISHES ARE SHOWN WITH A HATCH PATTERN ON FINISH PLANS WHERE APPLICABLE.

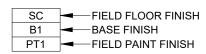

08/28/2023 FINISH PLANS

PROJECT ARCHITECT: JY

DRAWN BY:

22-703A


RC000638

CHECKED BY:

PROJECT NUMBER:

EBP, CSM, KS,

SHEET NUMBER:

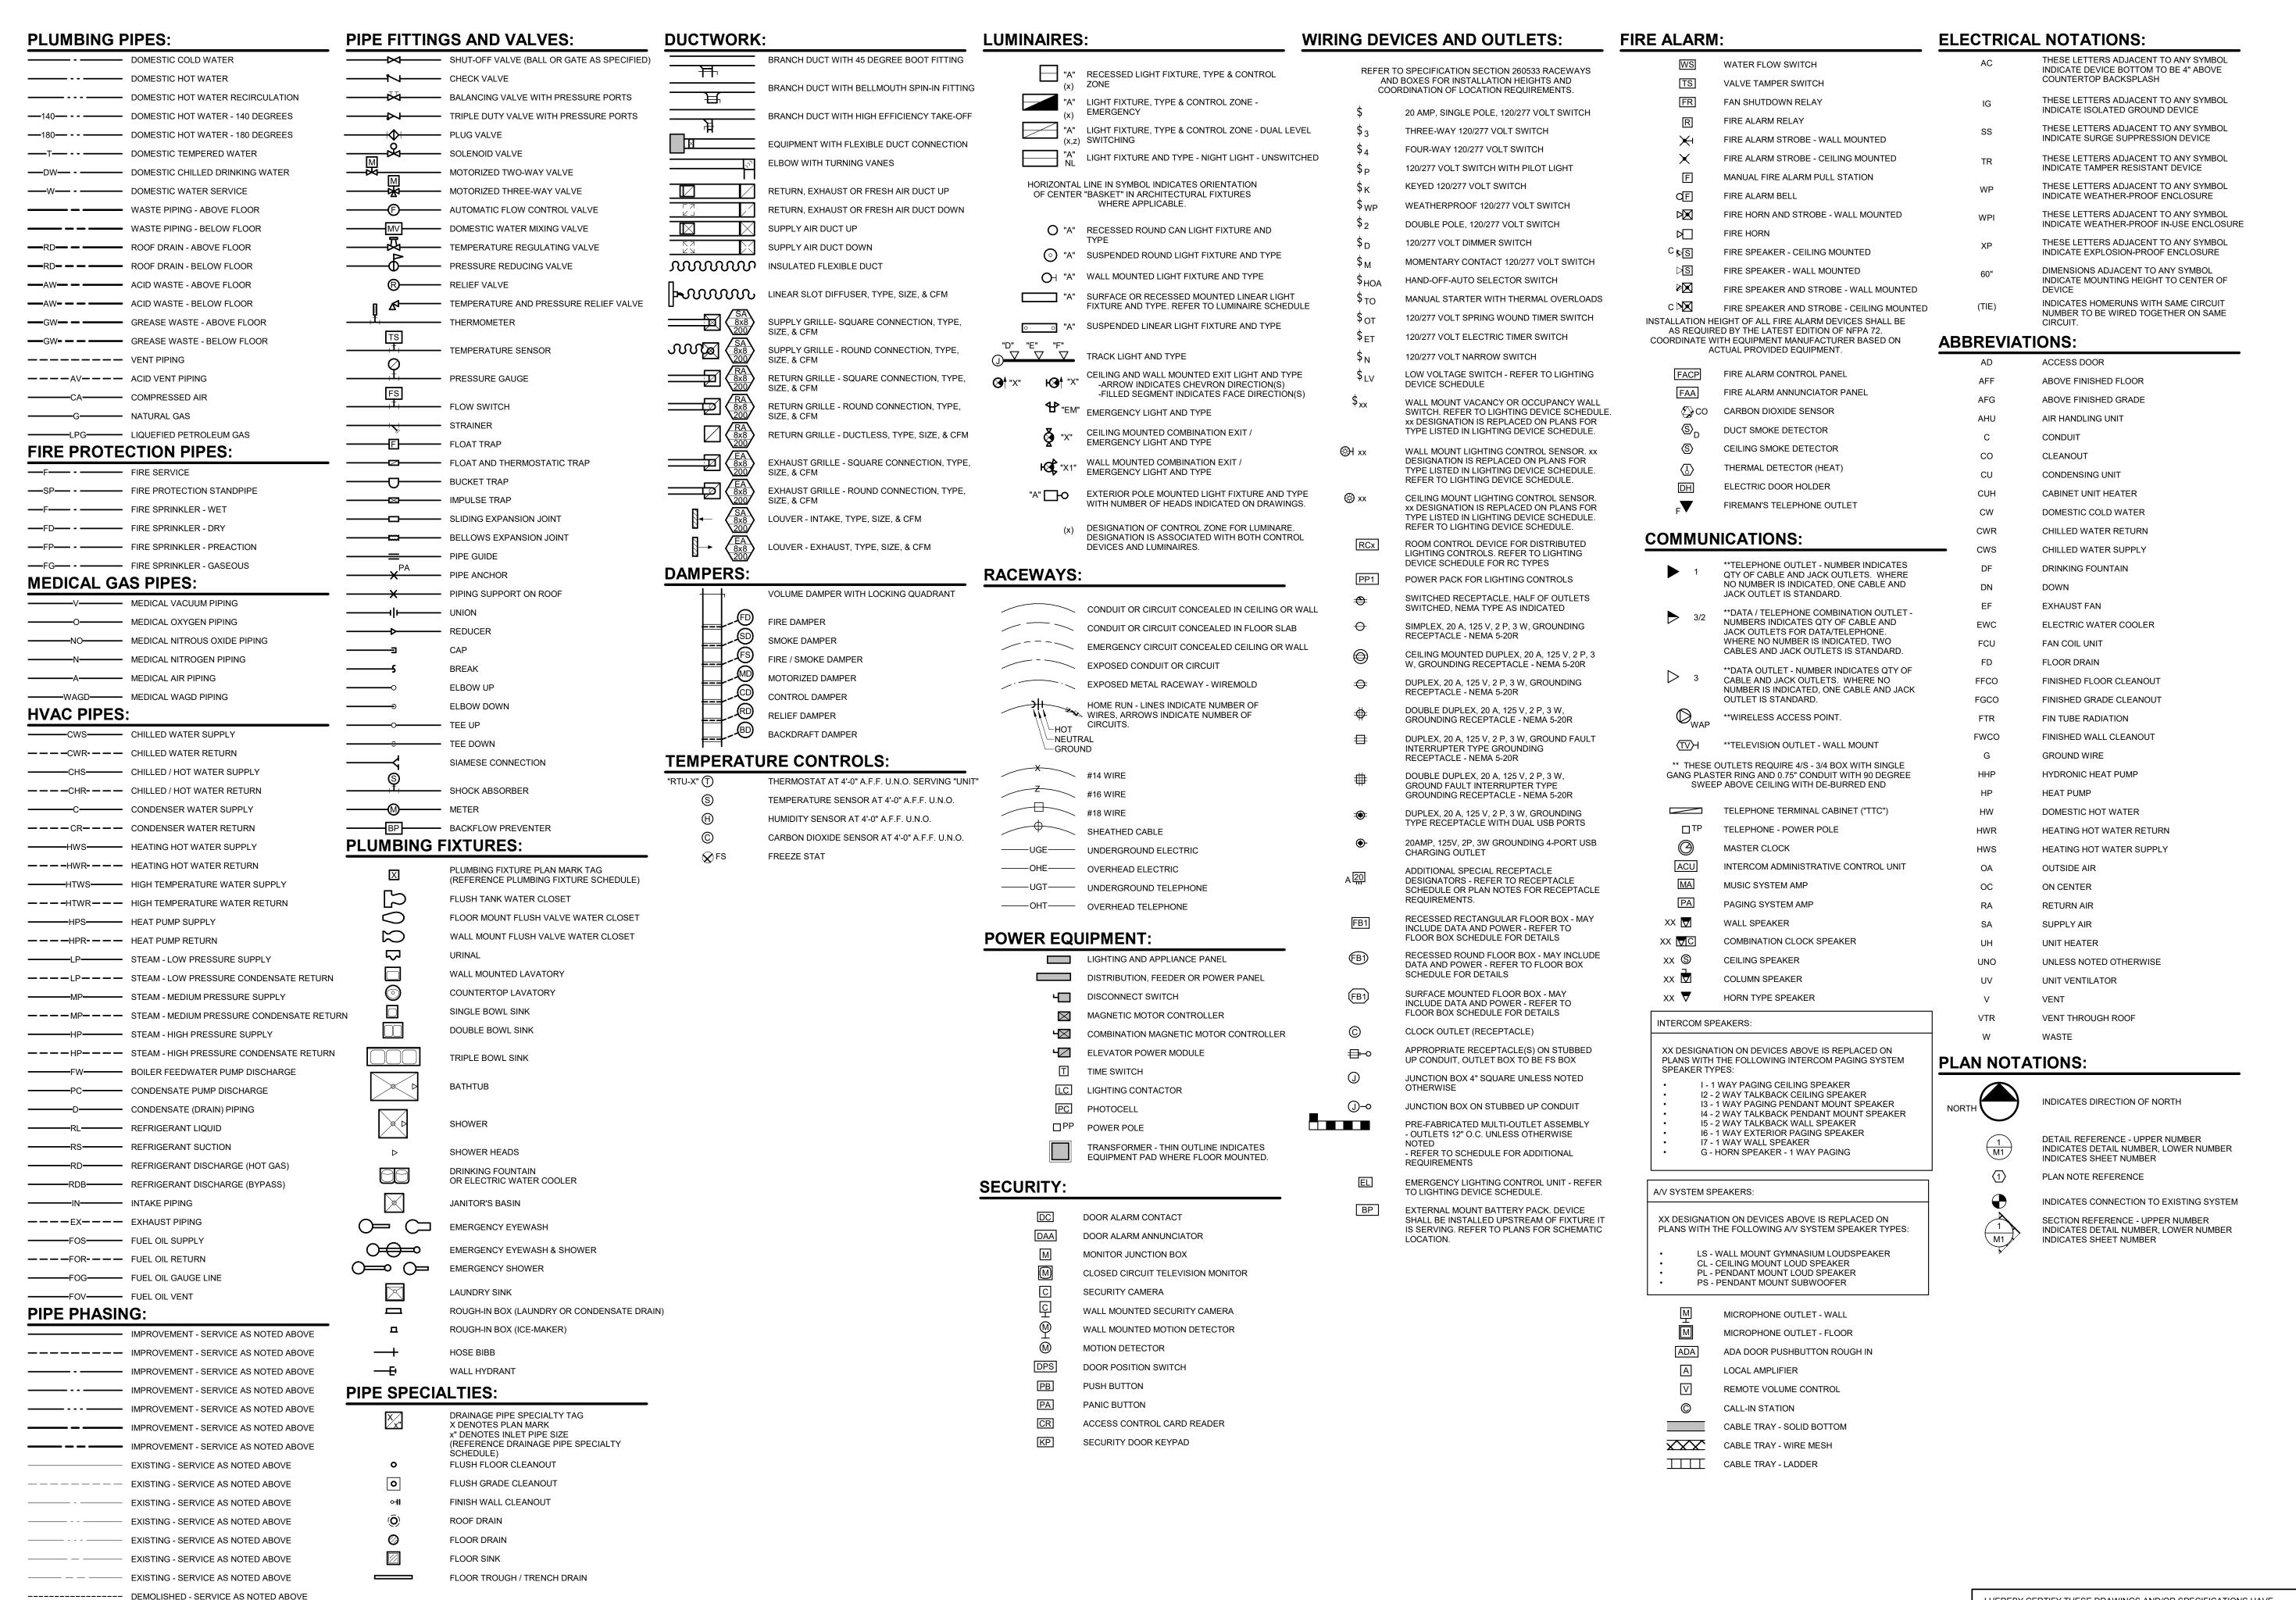

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FUTURE - SERVICE AS NOTED ABOVE

I HEREBY CERTIFY THESE DRAWINGS AND/OR SPECIFICATIONS HAVE BEEN PREPARED BY ME, OR UNDER MY SUPERVISION. I FURTHER CERTIFY THAT TO THE BEST OF MY KNOWLEDGE, THESE DRAWINGS AND/OR SPECIFICATIONS AREA AS REQUIRED BY AND IN COMPLIANCE WITH THE BUILDING CODES OF THE UNIVERSITY OF MISSOURI.

SHEET NUMBER:

ME1-0

SYMBOLS LEGEND

MISSOURI STATE CERTIFICATE OF AUTHORITY NUMBER A-2016000415

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engineering consultants

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CERTIFICATE OF AUTHORITY

#2014035826

FOR ENGINEERING

ENNIFER

**NUMBER** 

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**REVISION SCHEDULE** 

JENNIFER A. LUCE

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MP

TENNIAL RENOVA

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DRAWN BY:

CHECKED BY:

RC000638

8.28.2023

DATE:


PROJECT NUMBER 22-703A

PROJECT ENGINEER: Approver

LDN

JAL

E-2001018772

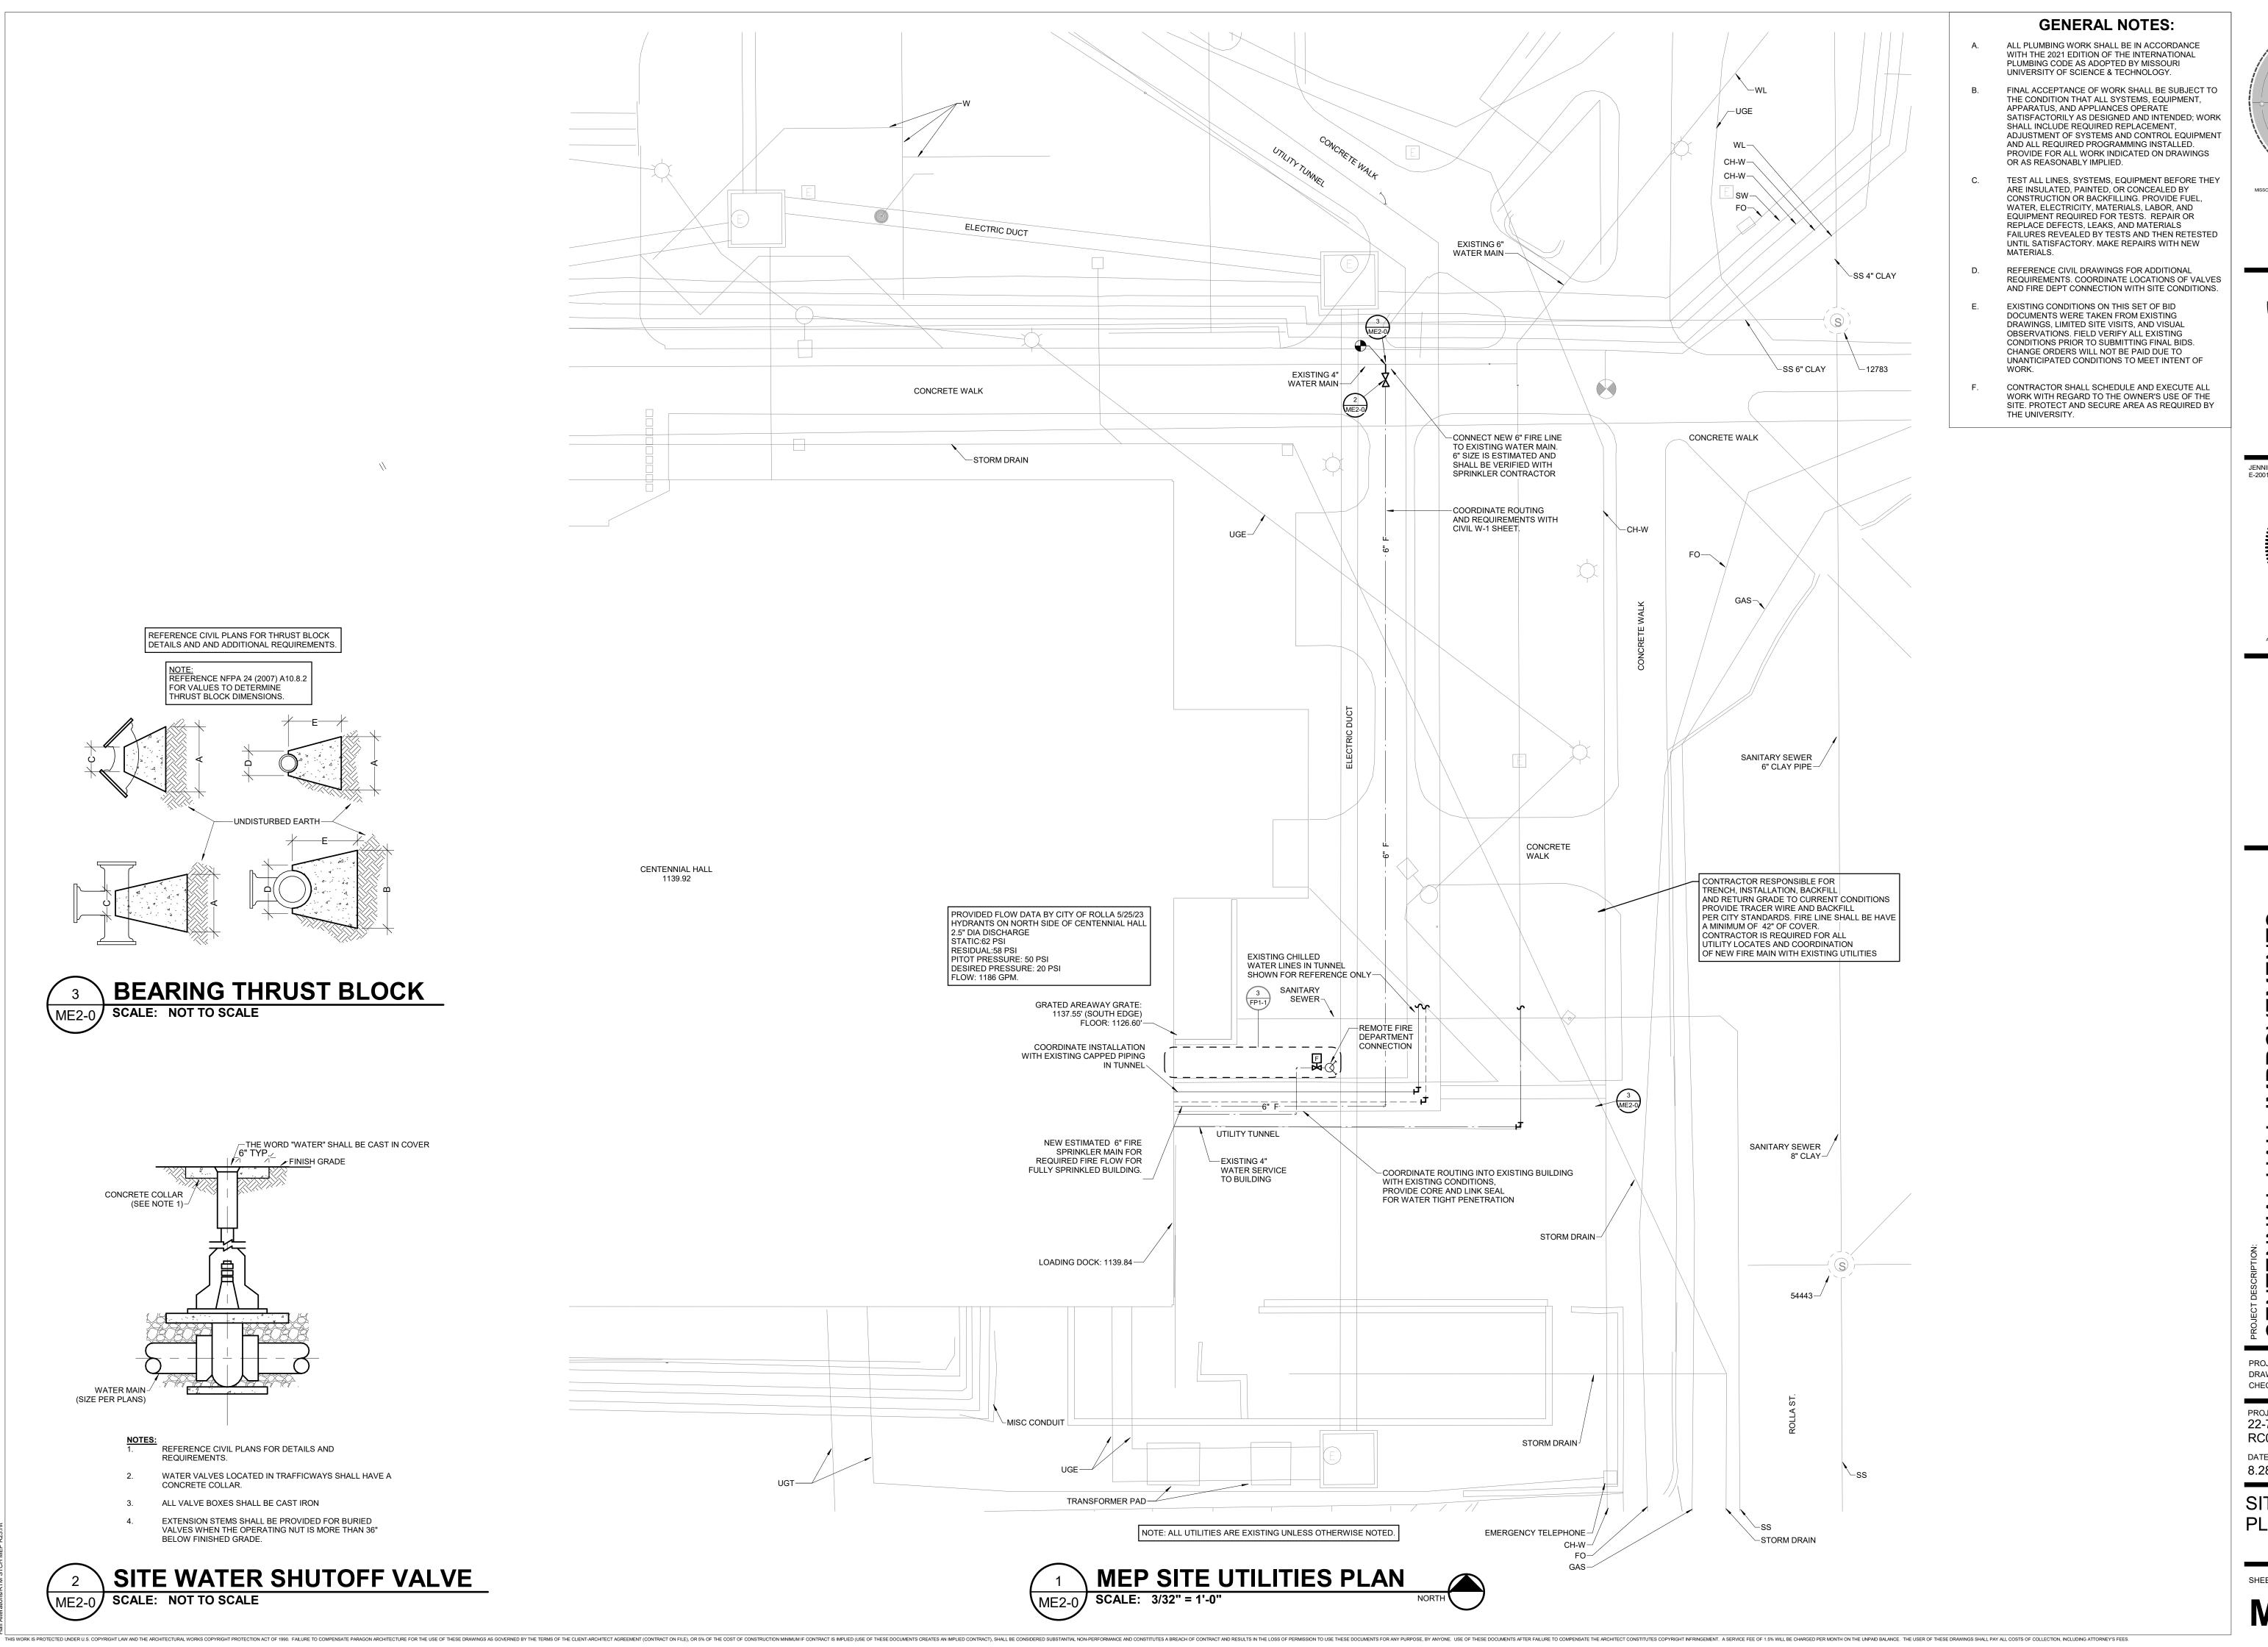

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637 COLLEGE STREET
SPRINGFIELD, MO 65806


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JENNIFER A. LUCE E-2001018772



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REVISION SCHEDULE

CENTENNIAL HALL IMPROVEMENTS
AND RENOVATION

PROJECT ENGINEER: Approver DRAWN BY: LDN CHECKED BY: JAL

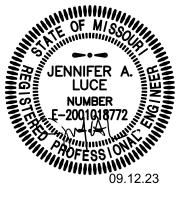PROJECT NUMBER: 22-703A RC000638

8.28.2023

SITE UTILITIES PLAN

SHEET NUMBER:

**ME2-**

### **GENERAL NOTES:**

- ALL FIRE PROTECTION WORK SHALL BE IN ACCORDANCE WITH THE 2021 EDITION OF THE INTERNATIONAL FIRE CODE AS ADOPTED BY MISSOURI UNIVERSITY OF SCIENCE & TECHNOLOGY.
- FINAL ACCEPTANCE OF WORK SHALL BE SUBJECT TO THE CONDITION THAT ALL SYSTEMS, EQUIPMENT, APPARATUS, AND APPLIANCES OPERATE SATISFACTORILY AS DESIGNED AND INTENDED; WORK SHALL INCLUDE REQUIRED REPLACEMENT, ADJUSTMENT OF SYSTEMS AND CONTROL EQUIPMENT AND ALL REQUIRED PROGRAMMING INSTALLED. PROVIDE FOR ALL WORK INDICATED ON DRAWINGS OR AS REASONABLY IMPLIED.
- TEST ALL LINES, SYSTEMS, EQUIPMENT BEFORE THEY ARE INSULATED, PAINTED, OR CONCEALED BY CONSTRUCTION OR BACKFILLING. PROVIDE FUEL, WATER, ELECTRICITY, MATERIALS, LABOR, AND EQUIPMENT REQUIRED FOR TESTS. REPAIR OR REPLACE DEFECTS, LEAKS, AND MATERIALS FAILURES REVEALED BY TESTS AND THEN RETESTED UNTIL SATISFACTORY. MAKE REPAIRS WITH NEW MATERIALS.
- PROVIDE NECESSARY MATERIALS AND ACCESSORIES FOR INSTALLATION OF FIXTURES, EQUIPMENT, ETC AS REQUIRED FOR COMPLETE AND FUNCTIONAL OPERATION AS NOTED ON DRAWINGS OR IN NOTES.
- ACCESS PANELS SHALL BE PROVIDED WHEREVER NECESSARY TO PROVIDE ACCESS TO VALVES, JUNCTION BOXES, ETC., LOCATED IN CONCEALED SPACES.
- ALL EQUIPMENT, FIXTURES, MATERIALS, ETC SHALL BE INSTALLED IN NEAT, PROFESSIONAL MANNER IN ACCORDANCE WITH MANUFACTURER RECOMMENDATIONS. ALL PIPING SHALL BE CONCEALED WHERE POSSIBLE.
- EXISTING CONDITIONS ON THIS SET OF BID DOCUMENTS WERE TAKEN FROM EXISTING DRAWINGS, LIMITED SITE VISITS, AND VISUAL OBSERVATIONS. FIELD VERIFY ALL EXISTING CONDITIONS PRIOR TO SUBMITTING FINAL BIDS. CHANGE ORDERS WILL NOT BE PAID DUE TO UNANTICIPATED CONDITIONS TO MEET INTENT OF WORK.
- CONTRACTOR SHALL SCHEDULE AND EXECUTE ALL WORK WITH REGARD TO THE OWNER'S USE OF THE
- PLANS ARE DIAGRAMMATIC AND SHALL NOT BE SCALED. REFER TO ARCHITECTURAL DRAWINGS FOR DIMENSIONS.
- REFER TO ARCHITECTURAL DEMOLITION PLANS FOR PHASING AND EXTENTS OF DEMOLITION. REFER TO ARCHITECTURAL PLANS FOR ALL PHASING REQUIREMENTS. CONTRACTOR SHALL BE RESPONSIBLE FOR REMOVING LIGHTS, CEILING, DIFFUSERS, ETC AS REQUIRED FOR INSTALLATION OF NEW SPRINKLER SYSTEMS. CONTRACTOR SHALL INCLUDE ALL REPLACEMENT COSTS FOR ANY DAMAGED FIXTURES, DIFFUSERS, ETC AS APPLICABLE.
- CONTRACTOR SHALL BE RESPONSIBLE FOR ALL CORING, PATCH, AND REPAIR OF ALL WALL AND FLOOR SYSTEMS AS REQUIRED DUE TO CONSTRUCTION WORK. MAINTAIN ALL FIRE RATINGS.
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- BEFORE ANY SPRINKLER WORK BEGINS, SUBMIT SCALED DRAWINGS: WHICH SHALL BE A DEFERRED SUBMITTAL: INDICATING THE LOCATIONS OF SPRINKLER HEADS AND HOW THEY INTERFACE WITH CEILING TILES, LIGHTING FIXTURES, HVAC GRILLES, AND DIFFUSERS, ETC. ALL SPRINKLER HEADS SHALL BE CENTERED IN CEILING TILES. LAYOUT DRAWINGS SHALL ALSO INCLUDE, BUT NOT LIMITED TO. PIPE SIZES AND LOCATIONS, ELEVATION AND SLOPES OF HORIZONTAL PIPING RUNS. COORDINATION OF PIPING WITH DUCTWORK, PIPING, ETC., AND HANGER LOCATIONS.



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ENTENNIAL HALL IMPROVEMENT ND RENOVATION


PROJECT ENGINEER: Approver DRAWN BY:

PROJECT NUMBER: 22-703A RC000638

8.28.2023

LOWER LEVEL SPRINKLER DEMO PLAN

SHEET NUMBER:

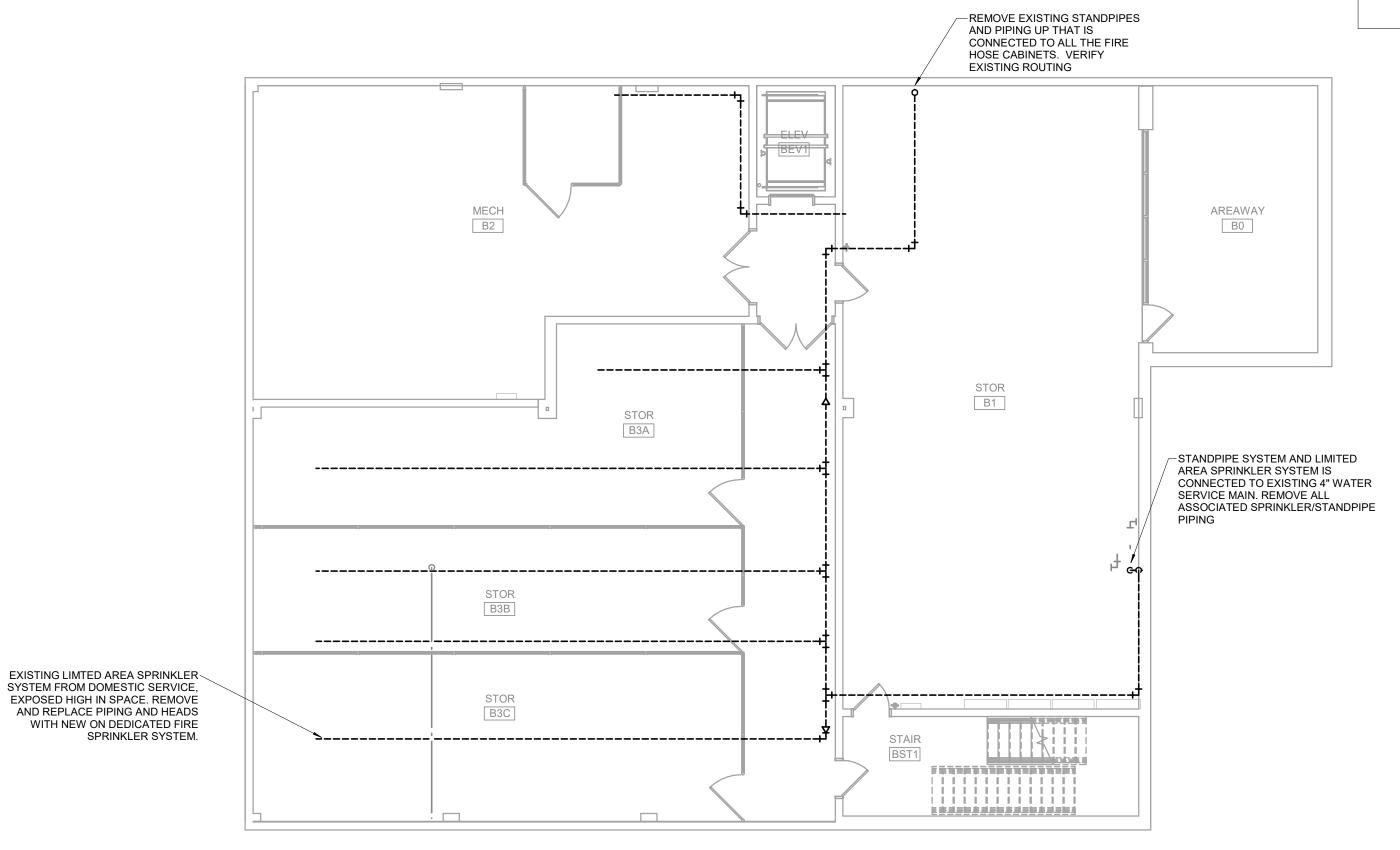

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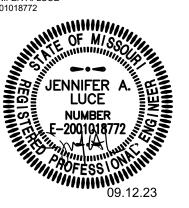
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JENNIFER A. LUCE E-2001018772



REVISION SCHEDULE

# CENTENNIAL HALL IMPROVEMENTS AND RENOVATION




PROJECT ENGINEER: Approver

FIRST & SECOND LEVEL SPRINKLER **DEMO PLAN** 


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**FP0-2** 






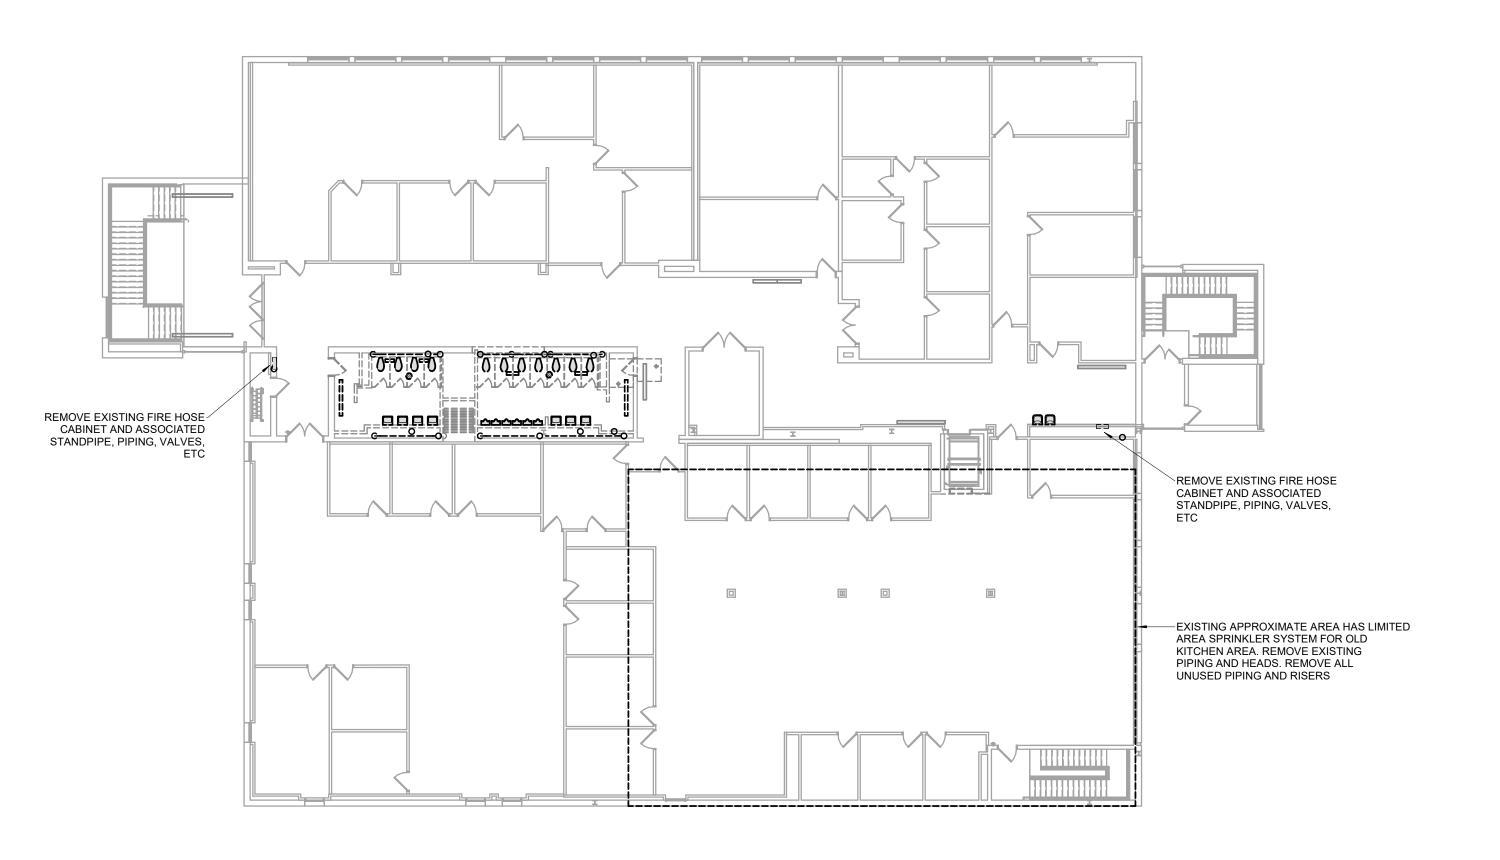

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MECHANICAL MEZZANINE FIRE PROTECTION PLAN SCALE: 1/8" = 1'-0"

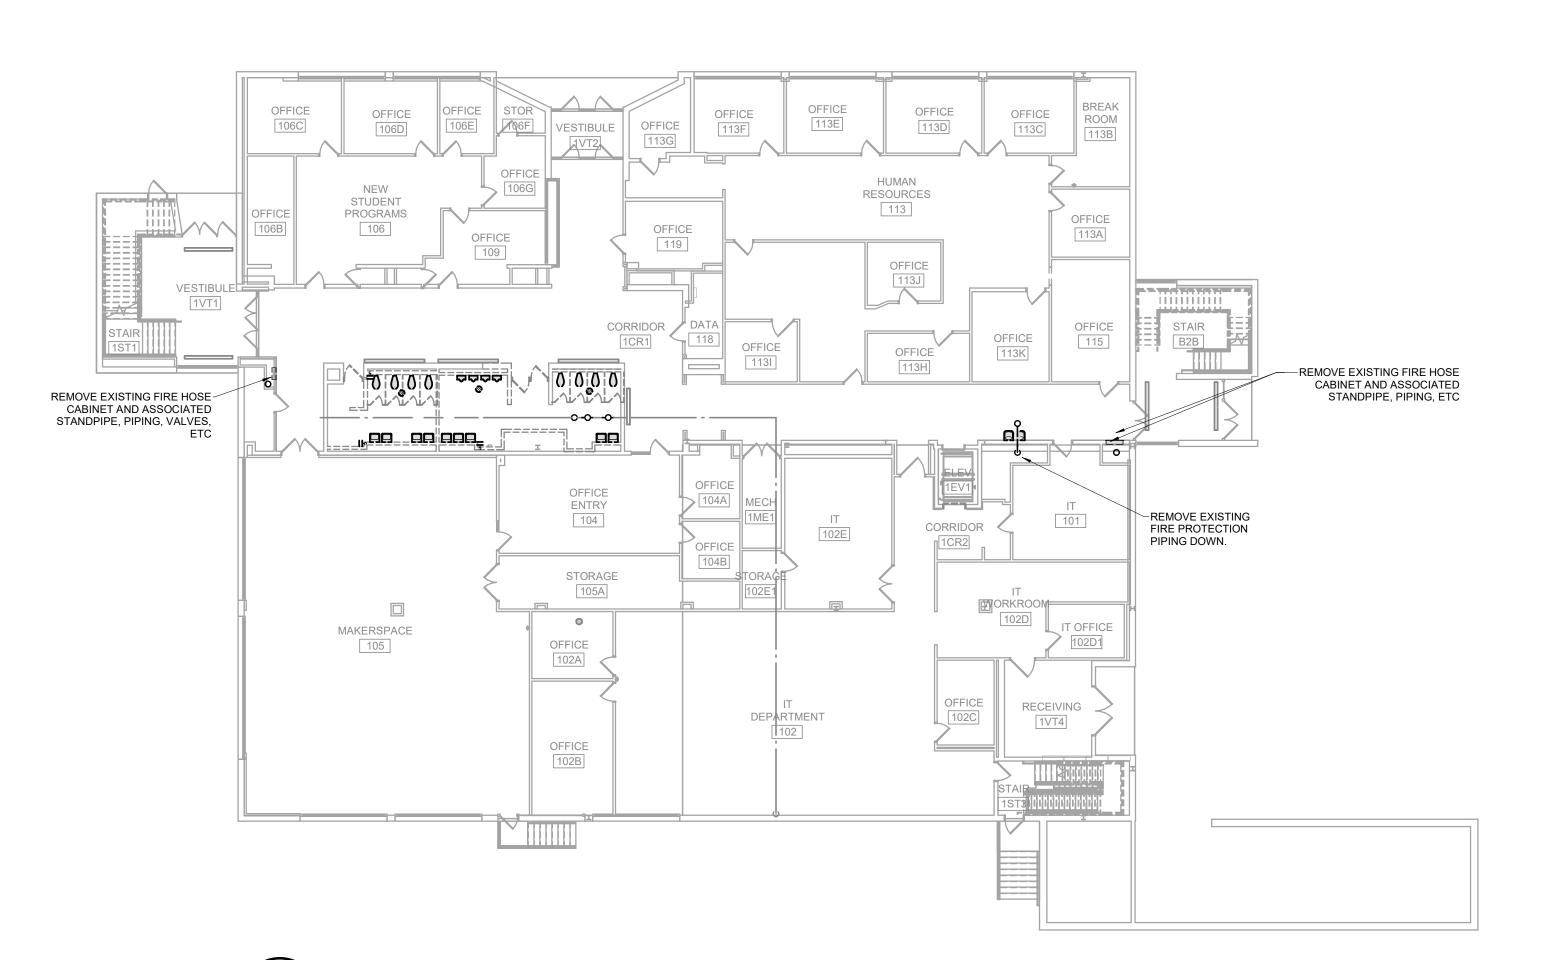

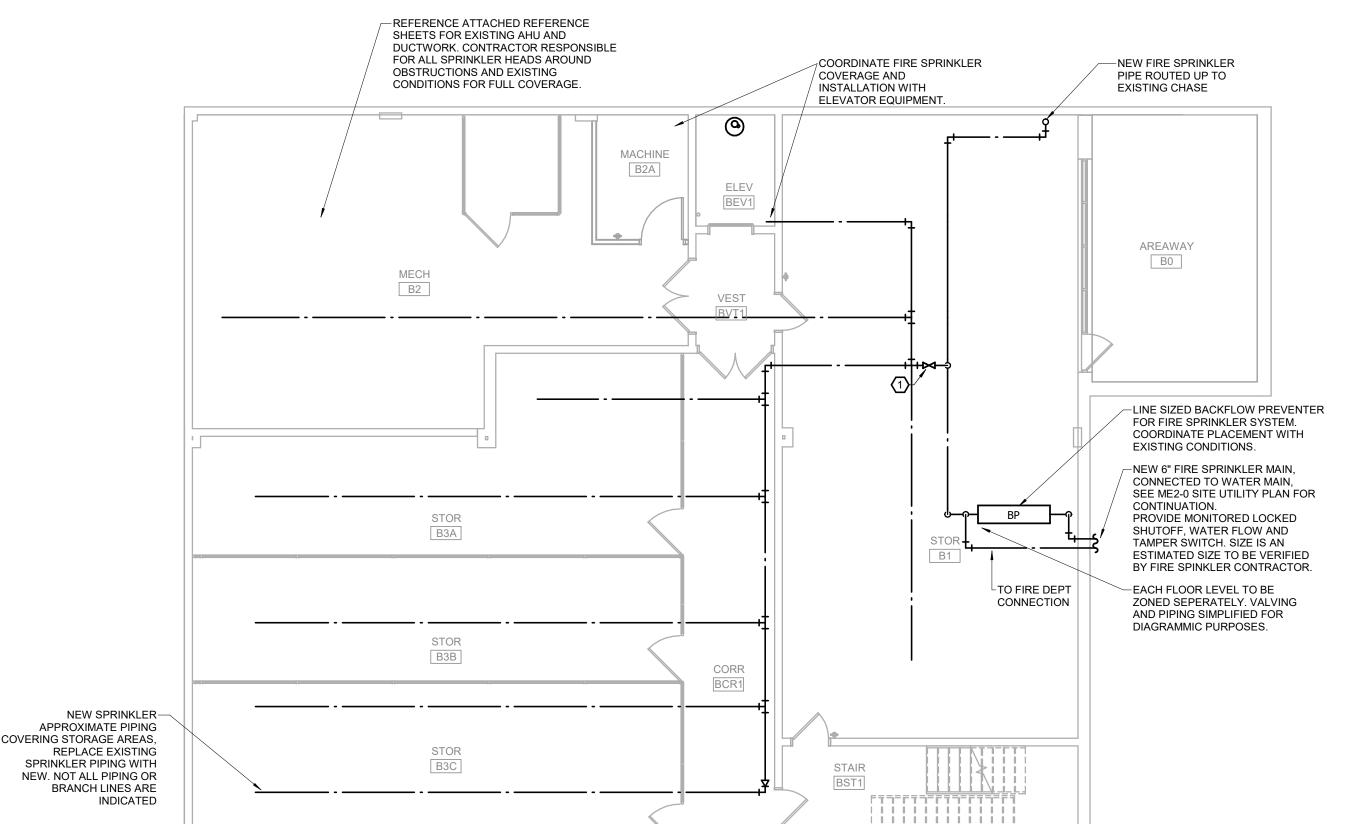

### **GENERAL NOTES:**

- ALL FIRE PROTECTION WORK SHALL BE IN ACCORDANCE WITH THE 2021 EDITION OF THE INTERNATIONAL FIRE CODE AS ADOPTED BY MISSOURI UNIVERSITY OF SCIENCE & TECHNOLOGY.
- FINAL ACCEPTANCE OF WORK SHALL BE SUBJECT TO THE CONDITION THAT ALL SYSTEMS, EQUIPMENT, APPARATUS, AND APPLIANCES OPERATE SATISFACTORILY AS DESIGNED AND INTENDED; WORK SHALL INCLUDE REQUIRED REPLACEMENT, ADJUSTMENT OF SYSTEMS AND CONTROL EQUIPMENT AND ALL REQUIRED PROGRAMMING INSTALLED. PROVIDE FOR ALL WORK

INDICATED ON DRAWINGS OR AS REASONABLY IMPLIED.

- TEST ALL LINES, SYSTEMS, EQUIPMENT BEFORE THEY ARE INSULATED, PAINTED, OR CONCEALED BY CONSTRUCTION OR BACKFILLING. PROVIDE FUEL, WATER, ELECTRICITY, MATERIALS, LABOR, AND EQUIPMENT REQUIRED FOR TESTS. REPAIR OR REPLACE DEFECTS, LEAKS, AND MATERIALS FAILURES REVEALED BY TESTS AND THEN RETESTED UNTIL SATISFACTORY. MAKE
- REPAIRS WITH NEW MATERIALS. PROVIDE NECESSARY MATERIALS AND ACCESSORIES FOR INSTALLATION OF FIXTURES, EQUIPMENT, ETC AS REQUIRED FOR COMPLETE AND FUNCTIONAL OPERATION AS NOTED ON DRAWINGS OR IN NOTES.
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### **PLAN HEX NOTES:**

PROVIDE SHUT-OFF FOR BASEMENT ZONE. PROVIDE TAMPER SWITCH AT VALVE.

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PROJECT ENGINEER: Approver

DRAWN BY: LDN CHECKED BY:


PROJECT NUMBER: 22-703A RC000638

8.28.2023

LOWER LEVEL AND MEZZANINE SPRINKLER PLAN

SHEET NUMBER:


**FP1-1** 

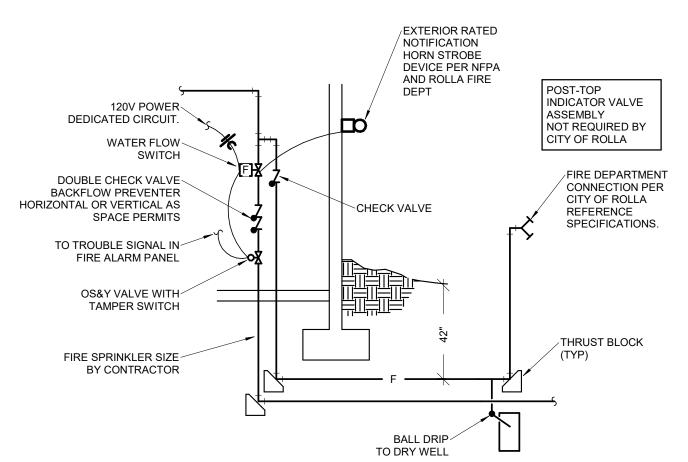





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CENTENNIAL HALL IMPROVEMENTS AND RENOVATION

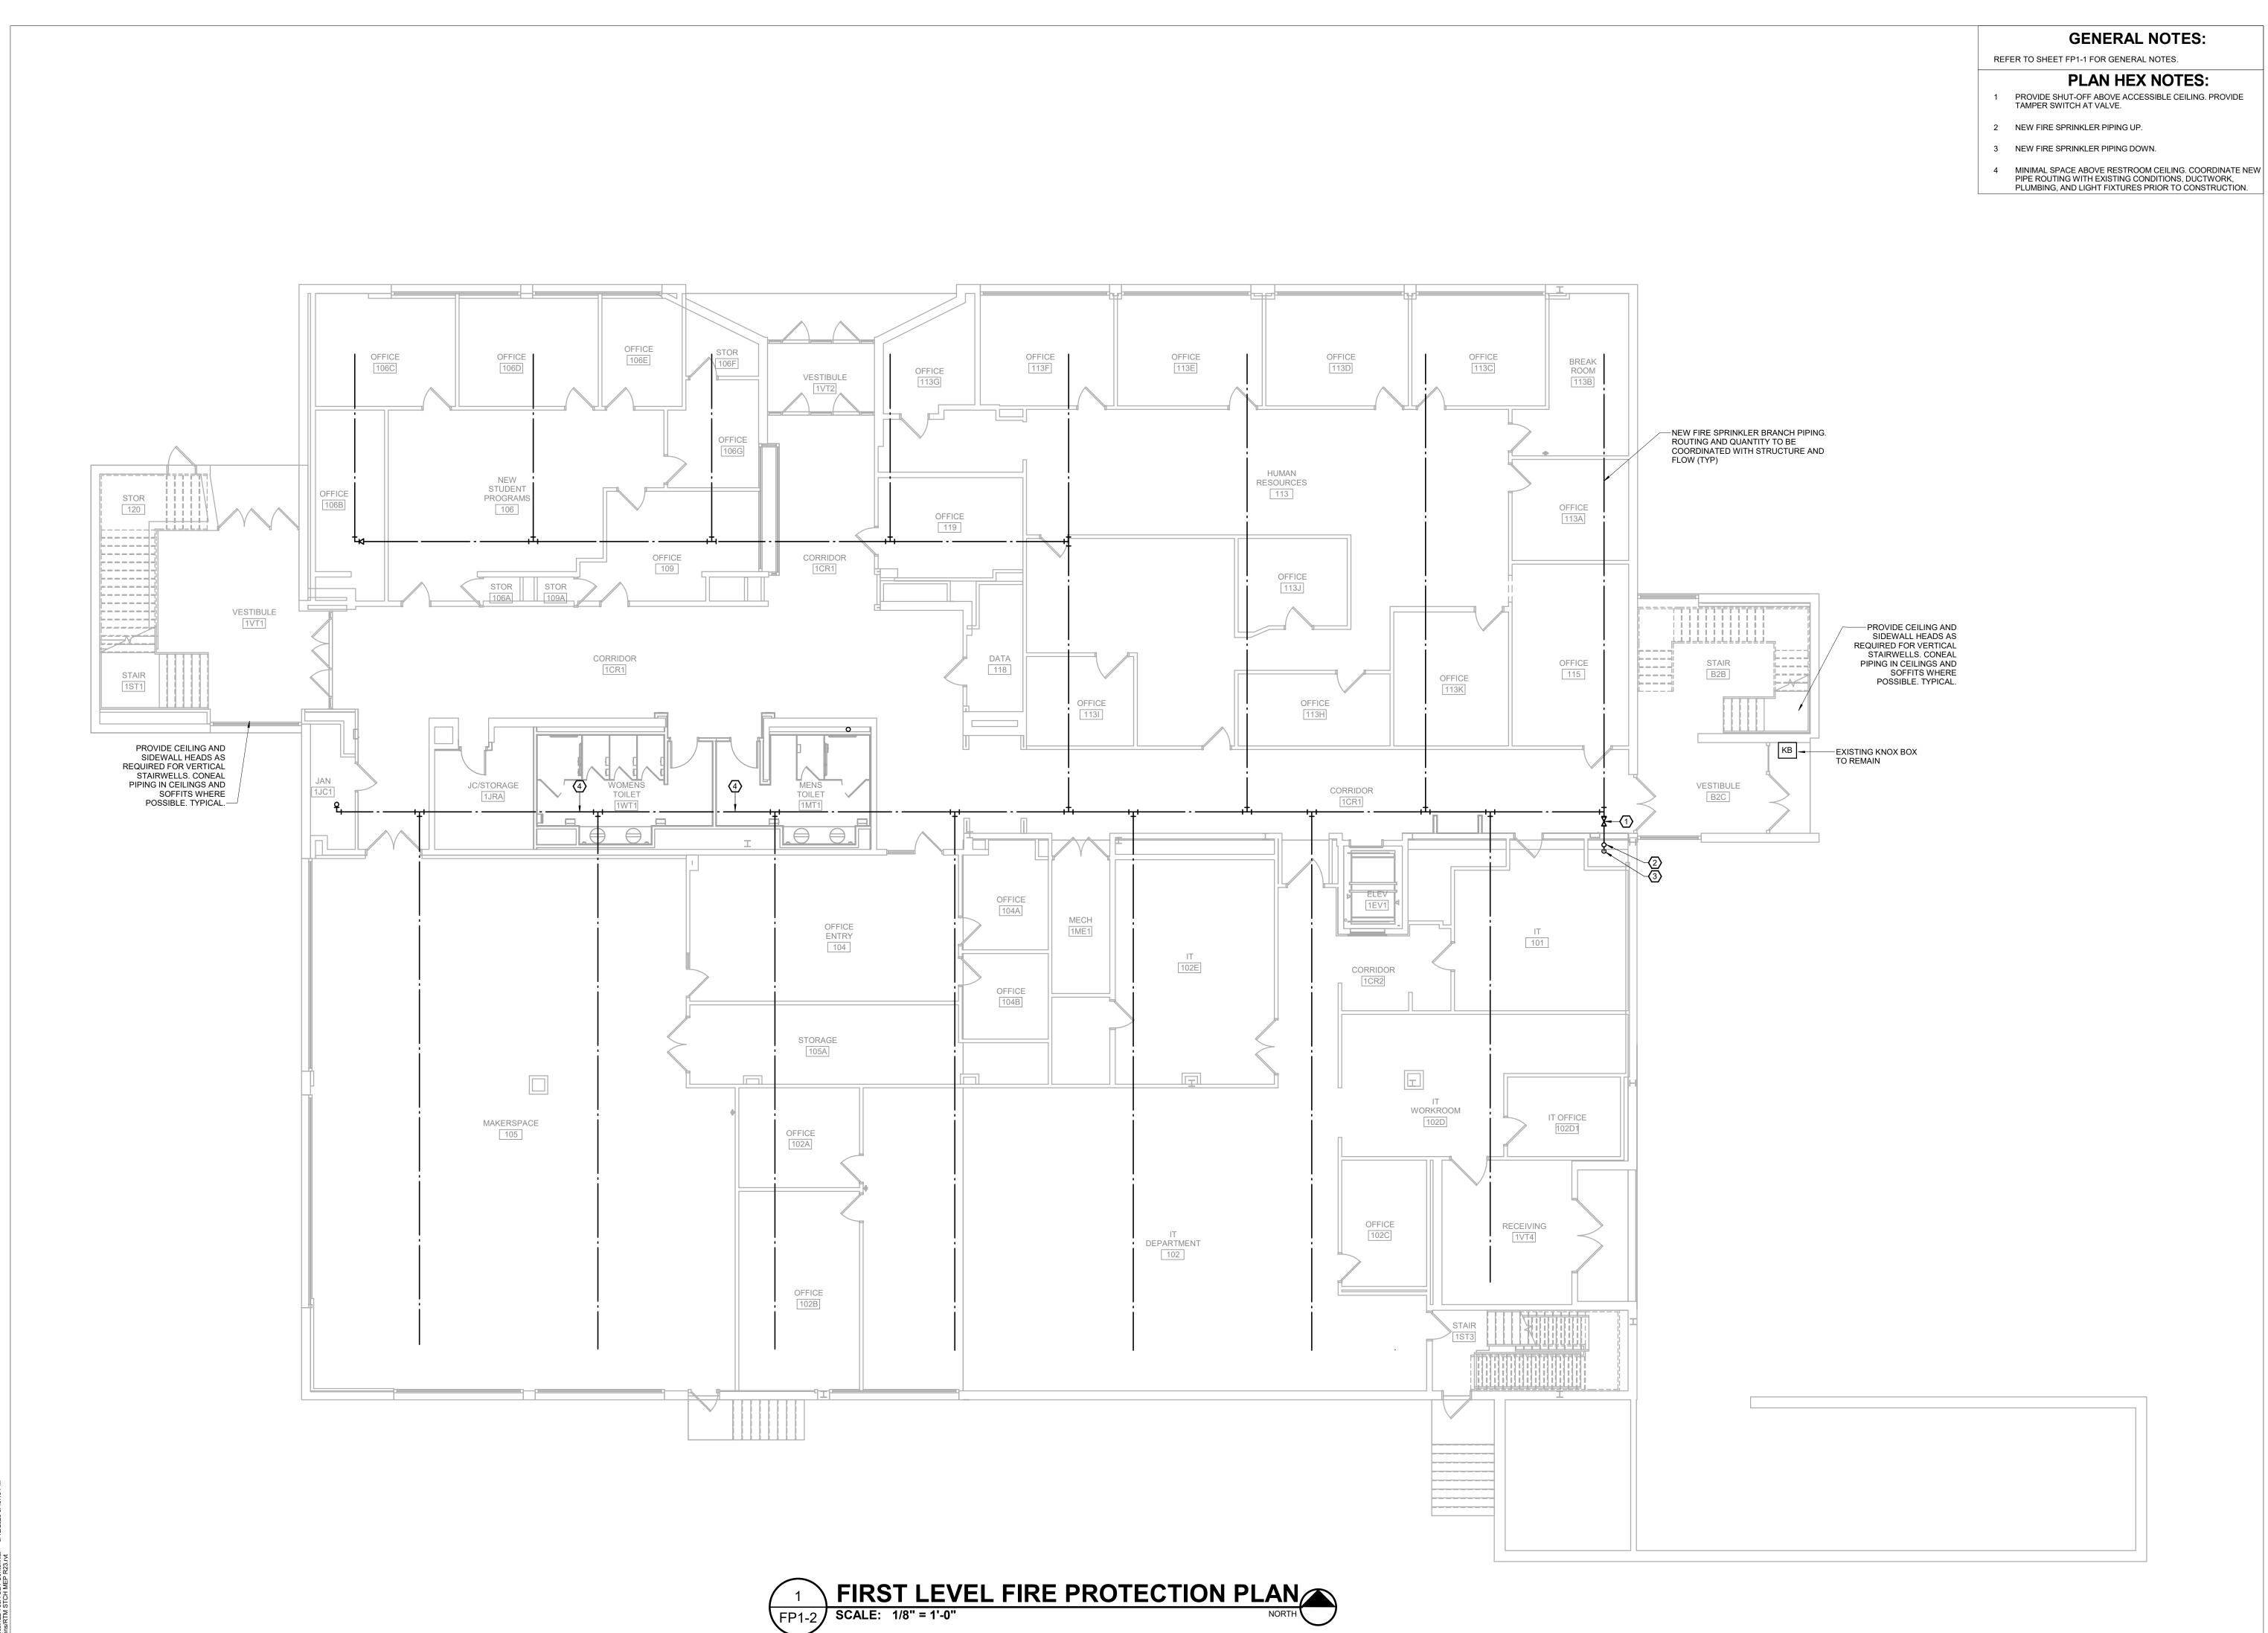PROJECT NUMBER: 22-703A RC000638

8.28.2023

DRAWN BY:

FIRST LEVEL SPRINKLER PLAN

SHEET NUMBER:

FP1-2




REFER TO SHEET FP1-1 FOR GENERAL NOTES.

### **PLAN HEX NOTES:**

PLUMBING, AND LIGHT FIXTURES PRIOR TO CONSTRUCTION.

- 1 MINIMAL SPACE ABOVE RESTROOM CEILING. COORDINATE NEV PIPE ROUTING WITH EXISTING CONDITIONS, DUCTWORK,
- 2 PROVIDE SHUT-OFF ABOVE ACCESSIBLE CEILING. PROVIDE TAMPER SWITCH AT VALVE.
- 3 NEW FIRE SPRINKLER PIPING DOWN.

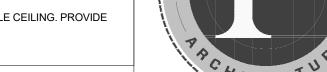

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CENTENNIAL HALL IMPROVEMENTS
AND RENOVATION

PROJECT ENGINEER: Approver DRAWN BY: LDN

PROJECT NUMBER: 22-703A

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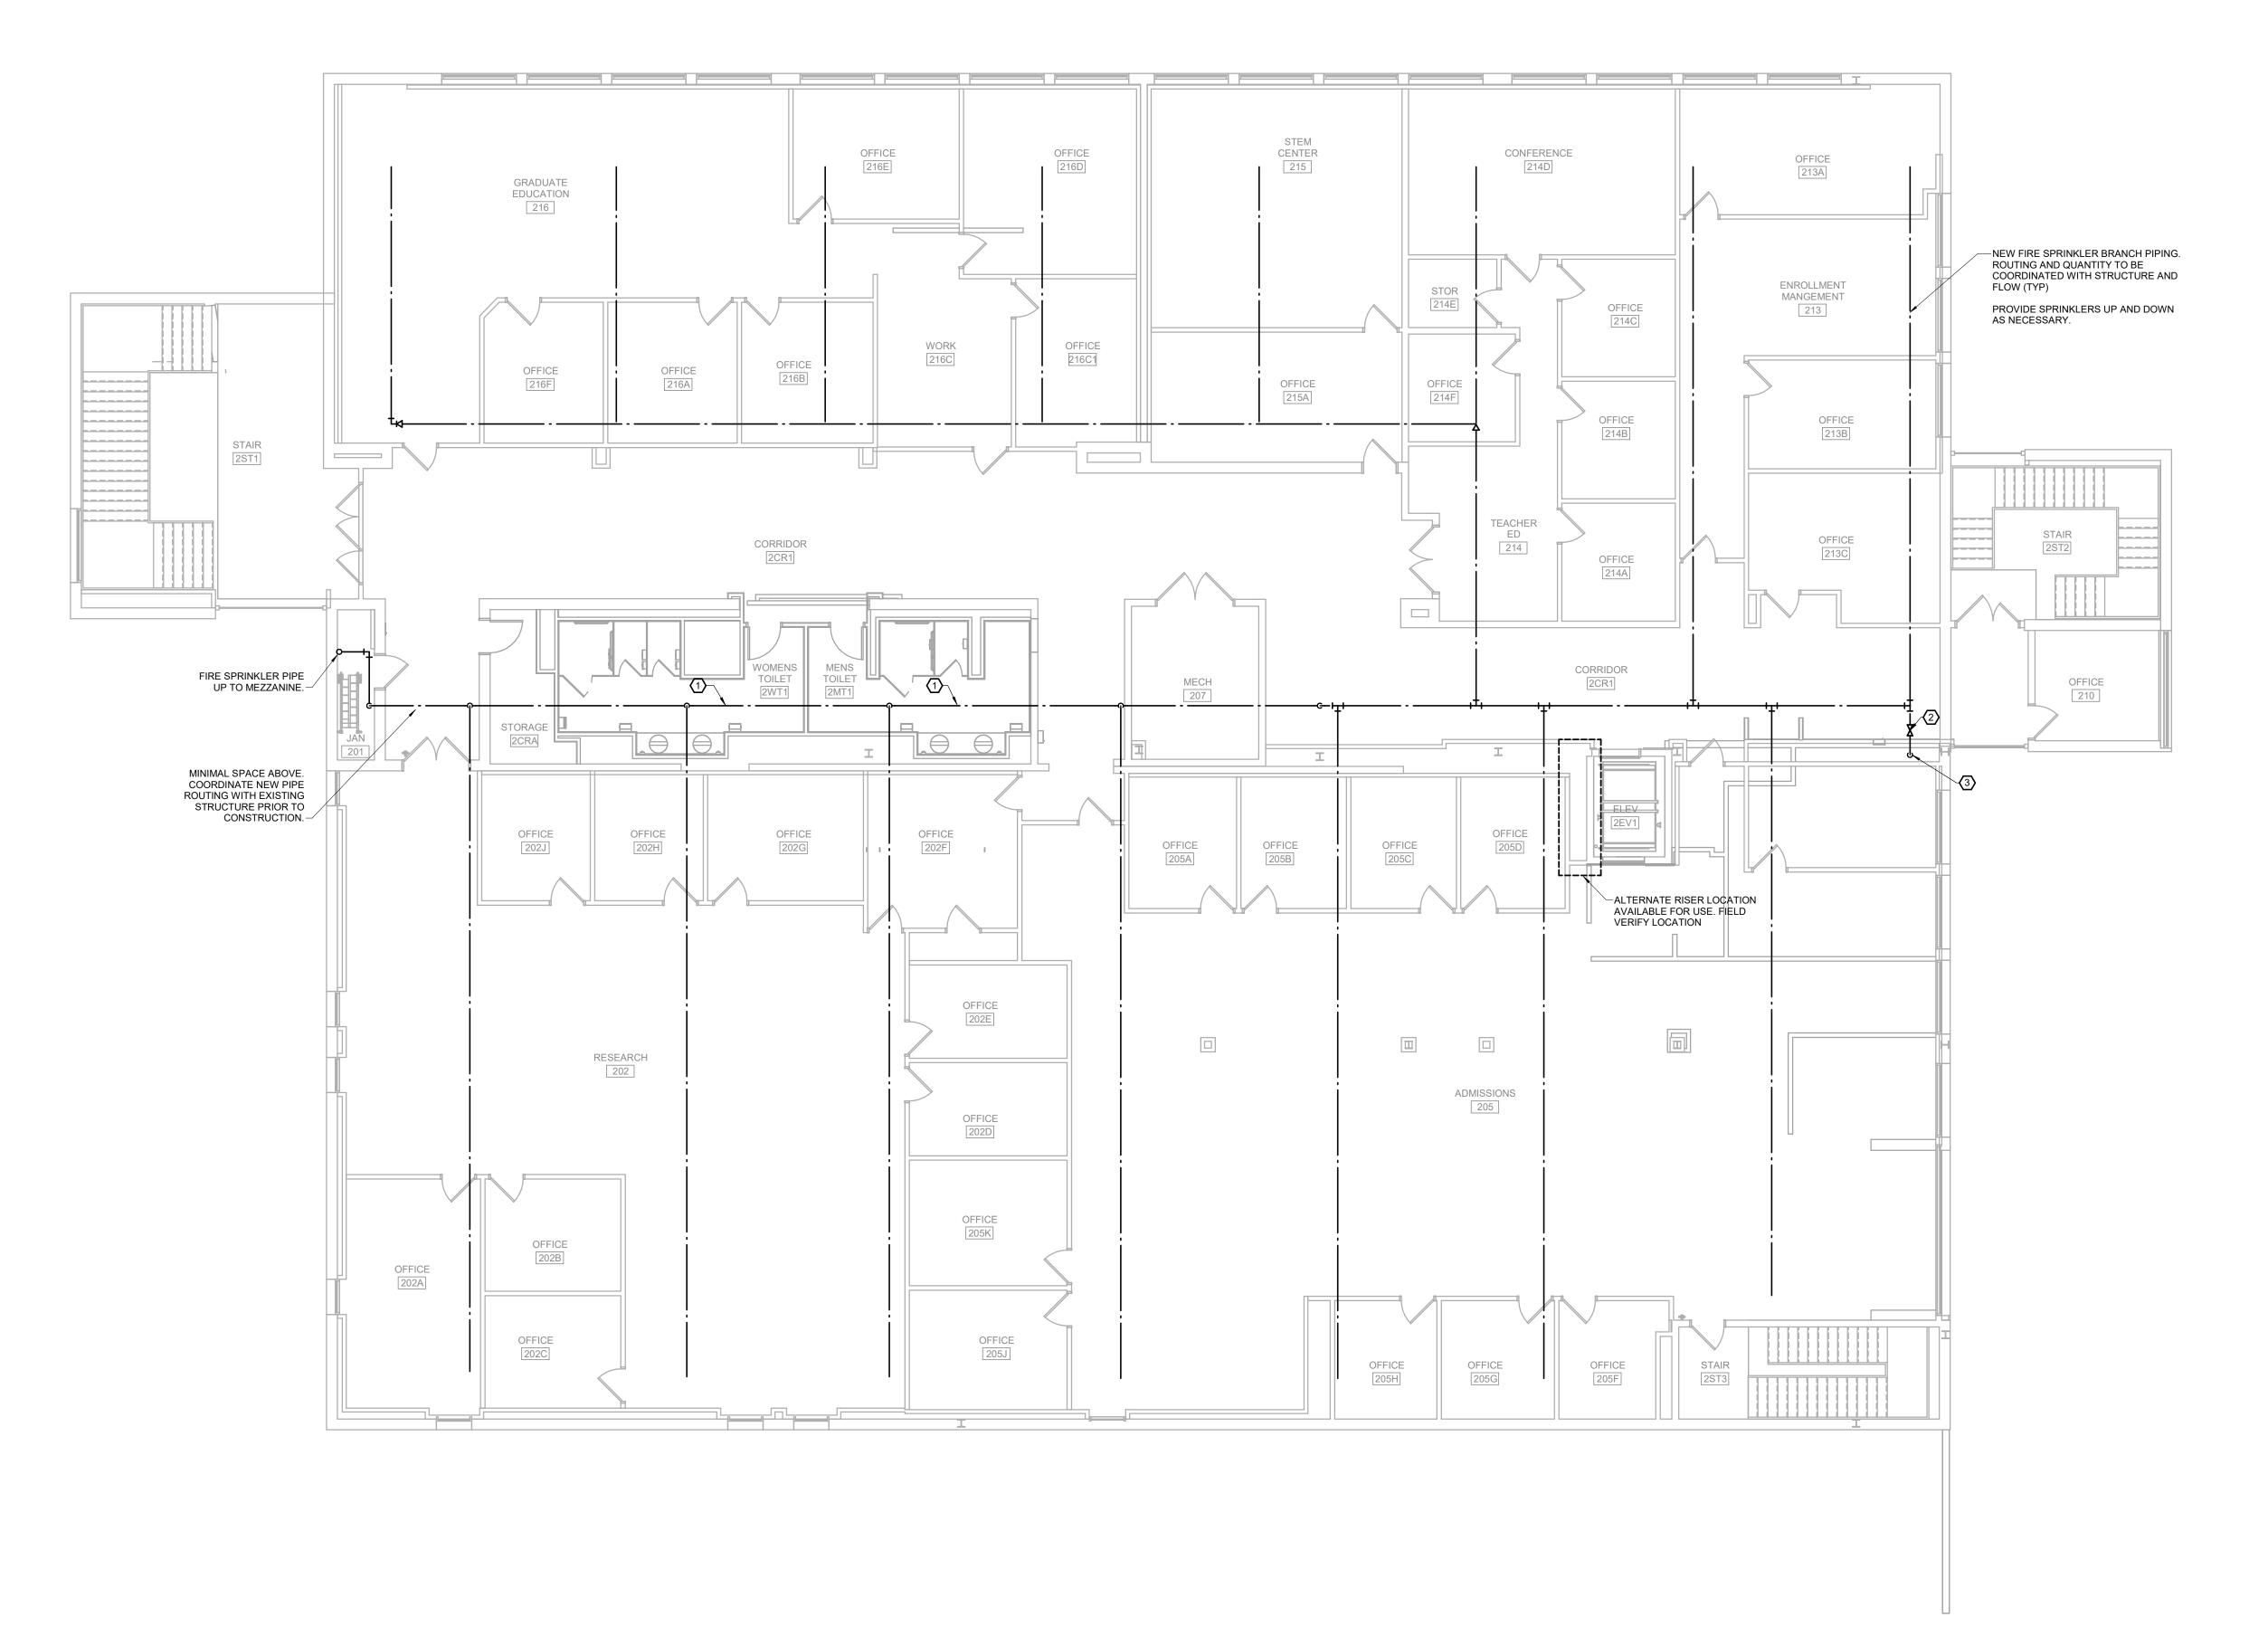
RC000638

DATE:
8.28.2023

SECOND LEVEL SPRINKLER PLAN

SHEET NUMBER:

FP1-3



SECOND LEVEL FIRE PROTECTION PLAN

FP1-3 SCALE: 1/8" = 1'-0"

NORTH

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REFER TO SHEET P#-# FOR GENERAL NOTES.



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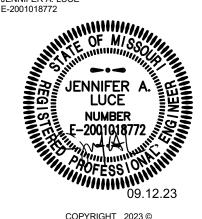
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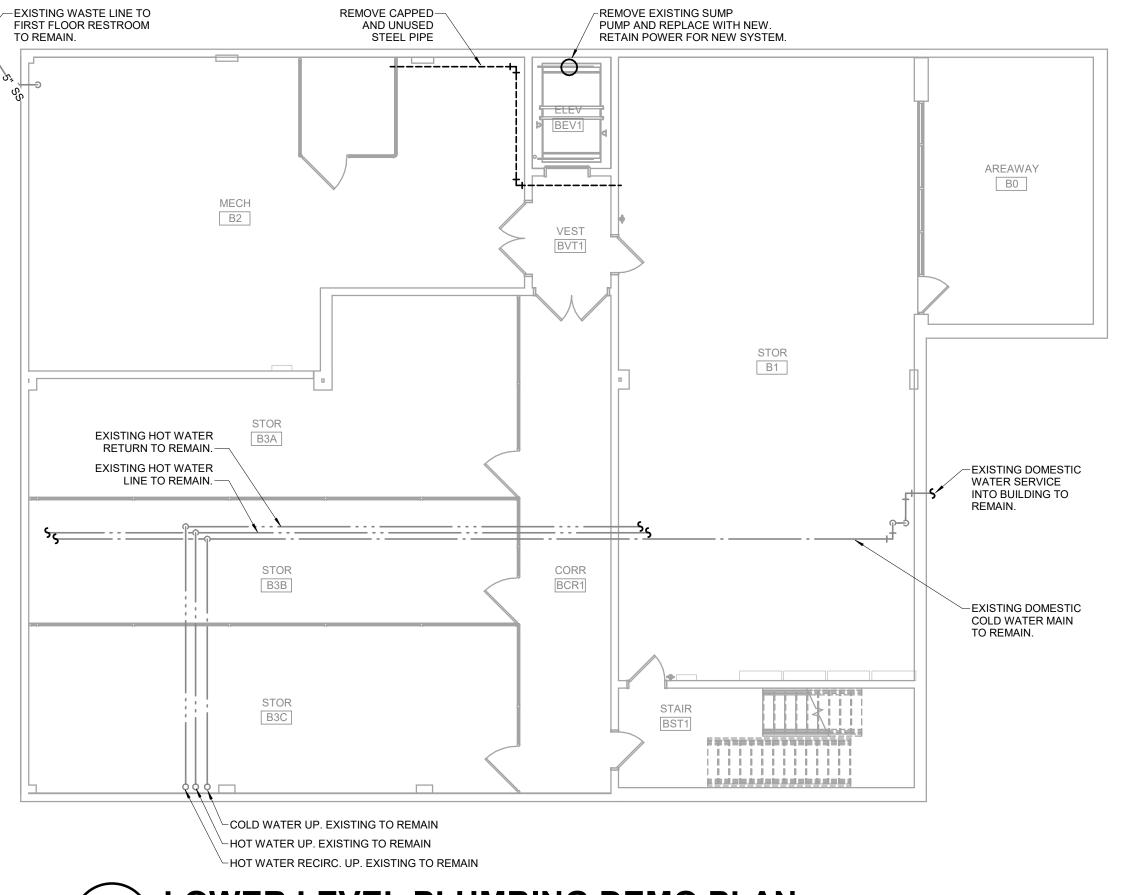
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# CENTENNIAL HALL IMPROVEMENTS AND RENOVATION



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PROJECT ENGINEER: Approver

LOWER LEVEL

PLUMBING DEMO

DRAWN BY:

PROJECT NUMBER: 22-703A


RC000638

8.28.2023

P0-

PLAN

REFER TO SHEET P#-# FOR GENERAL NOTES.

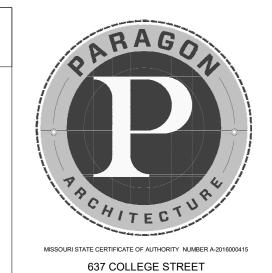






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REVISION SCHEDULE

CENTENNIAL HALL IMPROVEMENTS AND RENOVATION


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8.28.2023

FIRST LEVEL PLUMBING DEMO PLAN

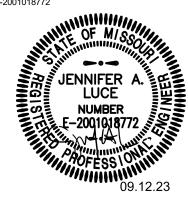SHEET NUMBER:

P0-2

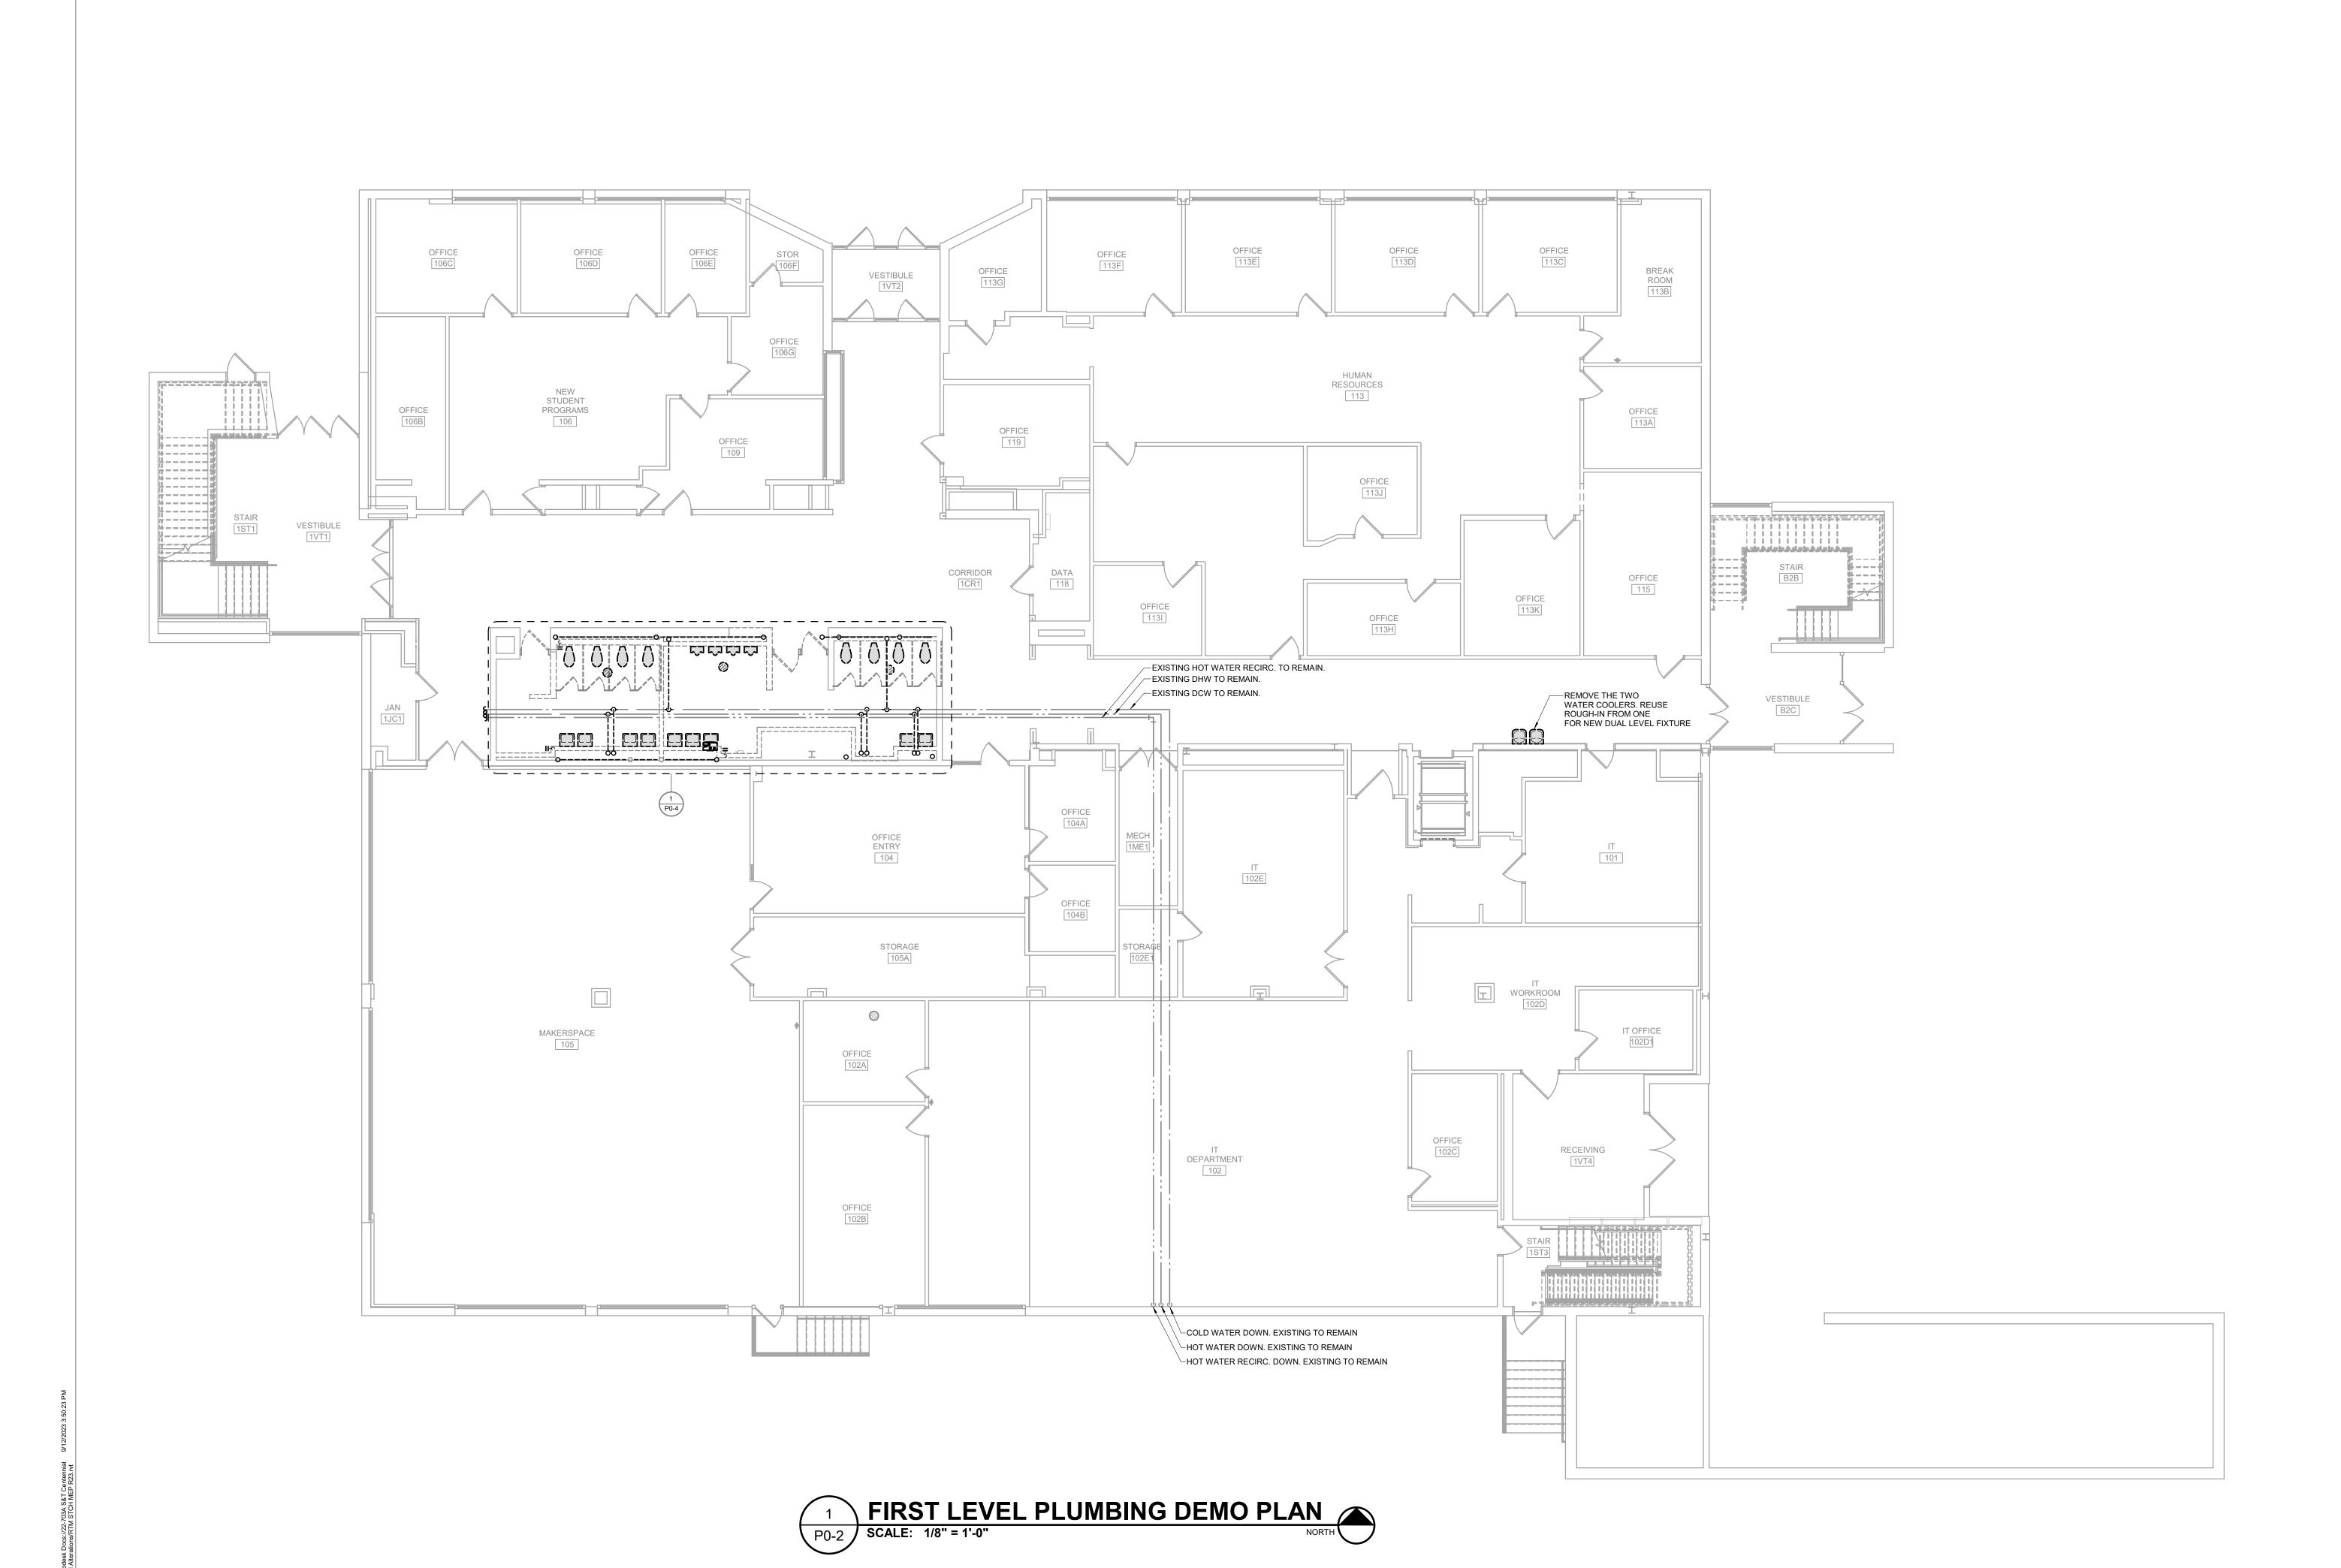

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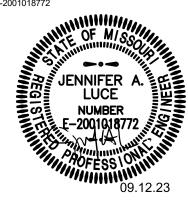
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## CENTENNIAL HALL IMPROVEMENTS AND RENOVATION

PROJECT ENGINEER: Approver DRAWN BY: LDN CHECKED BY: JAL

PROJECT NUMBER: 22-703A RC000638

8.28.2023


SECOND LEVEL PLUMBING DEMO PLAN

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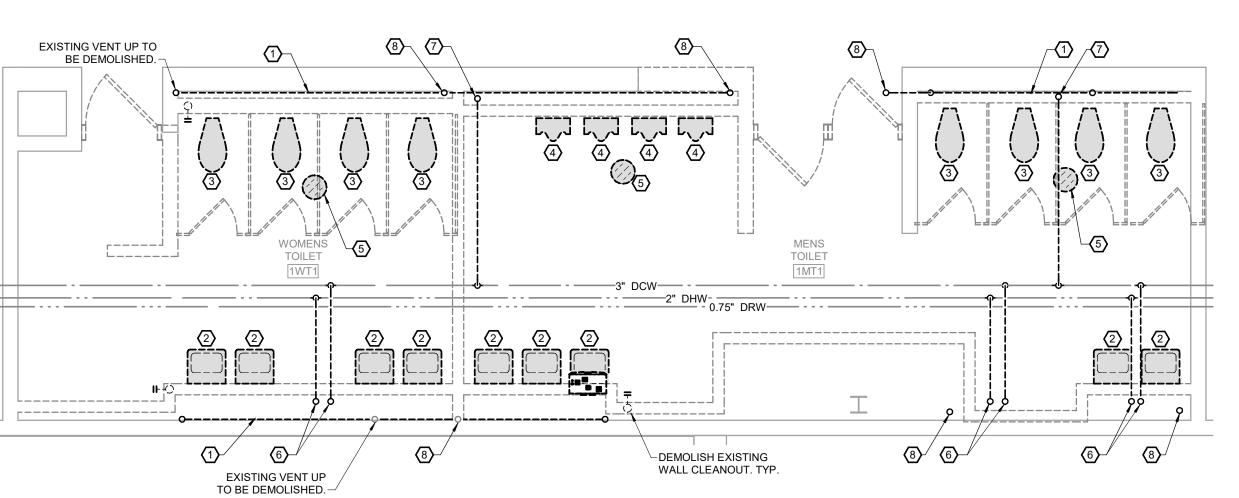
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FIRST LEVEL RESTROOM PLUMBING DEMO PLAN
P0-4 SCALE: 1/4" = 1'-0"
NORTH

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**GENERAL DEMOLITION NOTES:** 

- A. OWNER SHALL HAVE FIRST RIGHT OF REFUSAL FOR ALL DEMOLISHED MATERIALS AND EQUIPMENT. STORE ITEMS ON SITE AS DIRECTED BY OWNER.
- B. EXISTING CONDITIONS ON THIS SET OF BID DOCUMENTS WERE TAKEN FROM EXISTING DRAWINGS, LIMITED SITE VISITS, AND VISUAL OBSERVATIONS. FIELD VERIFY ALL EXISTING CONDITIONS PRIOR TO SUBMITTING FINAL BIDS. CHANGE ORDERS WILL NOT BE PAID DUE TO

UNANTICIPATED CONDITIONS TO MEET INTENT OF WORK.

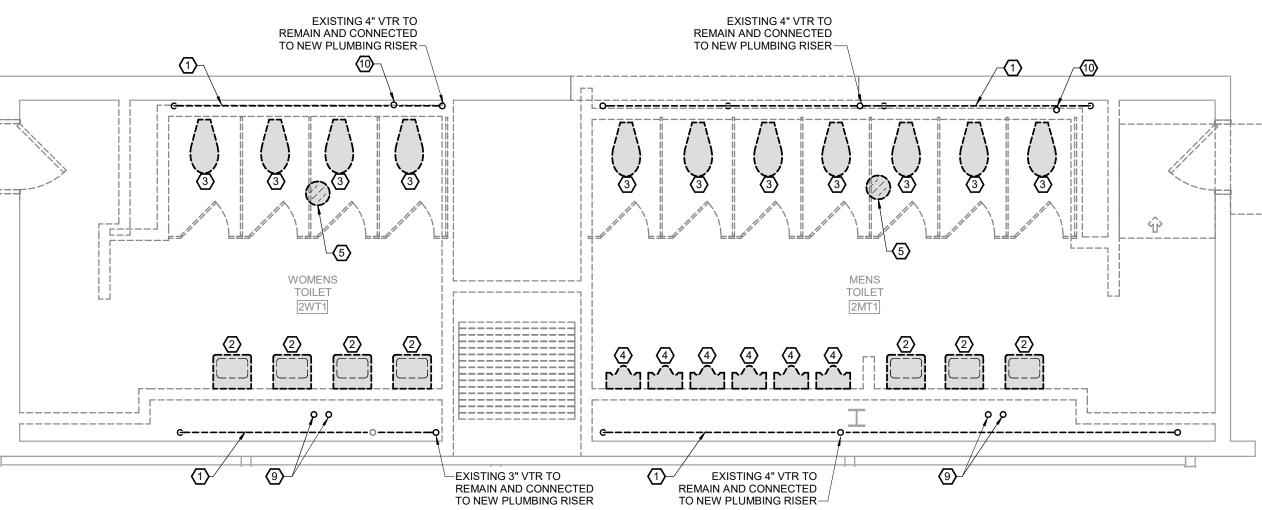- C. REFER TO ARCHITECTURAL DEMOLITION PLANS FOR PHASING AND EXTENTS OF DEMOLITION.
- D. CONTRACTOR SHALL BE RESPONSIBLE FOR ALL CORING, PATCH, AND REPAIR OF ALL WALL AND FLOOR SYSTEMS AS REQUIRED DUE TO CONSTRUCTION WORK. MAINTAIN ALL FIRE RATINGS.
- REMOVE ALL UNUSED PIPING LOCATED WITHIN THE AREA OF CONSTRUCTION. CAP BRANCH PIPING REMOVED NEAR MAIN. FOR DOMESTIC WATER PIPING PROVIDE SHUTOFF VALVE AT TAP AND CAP. MAIN SEWER LINES, VENT LINES, AND DOMESTIC MAINS SHALL BE REUSED FOR NEW FIXTURES.

### PLAN HEX NOTES:

- 1 PLUMBING FIXTURE WASTE CHASE TO BE REMOVED AND REPLACED WITH NEW.
- 2 EXISTING WALL HUNG LAVATORY TO BE DEMOLISHED. COLD WATER, HOT WATER, AND WASTE LINES TO BE DEMOLISHED AND CAPPED AS NECESSARY.
- 3 EXISTING FLOOR MOUNTED FLUSH VALVE WATER CLOSET TO BE DEMOLISHED. COLD WATER AND WASTE LINE CONNECTION TO BE DEMOLISHED AND CAPPED AS NECESSARY.
- 4 EXISTING WALL MOUNTED URINALS TO BE DEMOLISHED. REMOVE AND CAP WATER AND WASTE PIPING NO LONGER USED AS NECESSARY.
- 5 EXISTING FLOOR DRAIN TO BE ABANDONED AND CAPPED IN PLACE. PATCH FLOOR. REMOVE ALL ASSOCIATED PIPING.
- 6 EXISTING HOT AND COLD WATER DOWN TO LAVATORIES AND UP TO SERVICE SECOND LEVEL RESTROOM LAVATORIES TO BE REMOVED.
- 7 EXISTING DOMESTIC COLD WATER TO PLUMBING FIXTURES, UP AND DOWN, TO BE REMOVED.
- 8 REMOVE EXISTING WASTE AND VENT PIPING RISING UP TO SERVER SECOND FLOOR RESTROOMS.
- 9 EXISTING HOT AND COLD WATER PIPING DOWN. EXISTING WATER PIPING TO LAVATORIES TO BE REMOVED AND
- 10 EXISTING WATER PIPING SERVING RESTROOM FIXTURES TO BE REMOVED.

REPLACED WITH NEW PIPING EXTENDED TO NEW LOCATIONS.



MISSOURI STATE CERTIFICATE OF AUTHORITY NUMBER A-2016000415
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SPRINGFIELD, MO 65806

PH: 417.885.0002


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Springfield, MO 65804
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STATE OF MISSOURI
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FOR ENGINEERING

JENNIFER A. LUCE E-2001018772



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REVISION SCHEDULE

CENTENNIAL HALL IMPROVEMENTS
AND RENOVATION

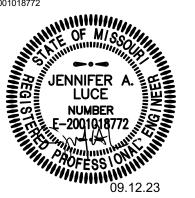PROJECT ENGINEER: Approver DRAWN BY: LDN

PROJECT NUMBER: 22-703A RC000638

DATE: 8.28.2023

ENLARGED
PLUMBING DEMO
PLAN

SHEET NUMBER:

P0-4

1 LOWER LEVEL PLUMBING PLAN
P1-1 SCALE: 1/8" = 1'-0"

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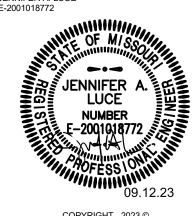
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# PROJECT DESCRIPTION: CENTENNIAL HALL IMPROVEMENTS AND RENOVATION 300 W. 12TH STREET ROLLA, MO 65409

LOWER LEVEL PLUMBING PLAN

SHEET NUMBER:

DRAWN BY: CHECKED BY:

PROJECT NUMBER: 22-703A

RC000638

P1-1

todesk Docs://22-703A S&T Centennial 9/12/2023 3:50:33 PM II Alterations/RTM STCH MEP R23.rvt

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SPRINGFIELD, MO 65806


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PROJECT DESCRIPTION:

CENTENNIAL HALL IMPROVEMENTS

AND RENOVATION

AND RENOVATION

PROJECT NUMBER: 22-703A

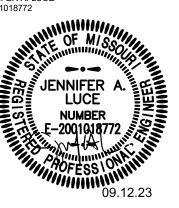RC000638


DATE:
8.28.2023

FIRST LEVEL PLUMBING PLAN

SHEET NUMBER:

P1-2

A. REFER TO GENERAL NOTES ON P2-1.

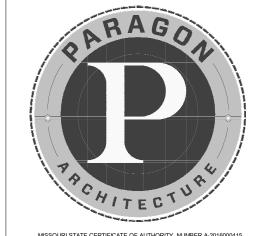



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REVISION SCHEDULE

CENTENNIAL HALL IMPROVEMENTS AND RENOVATION

PROJECT ENGINEER: Approver DRAWN BY:

PROJECT NUMBER: 22-703A RC000638


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8.28.2023

SECOND LEVEL PLUMBING PLAN

SHEET NUMBER:

P1-3

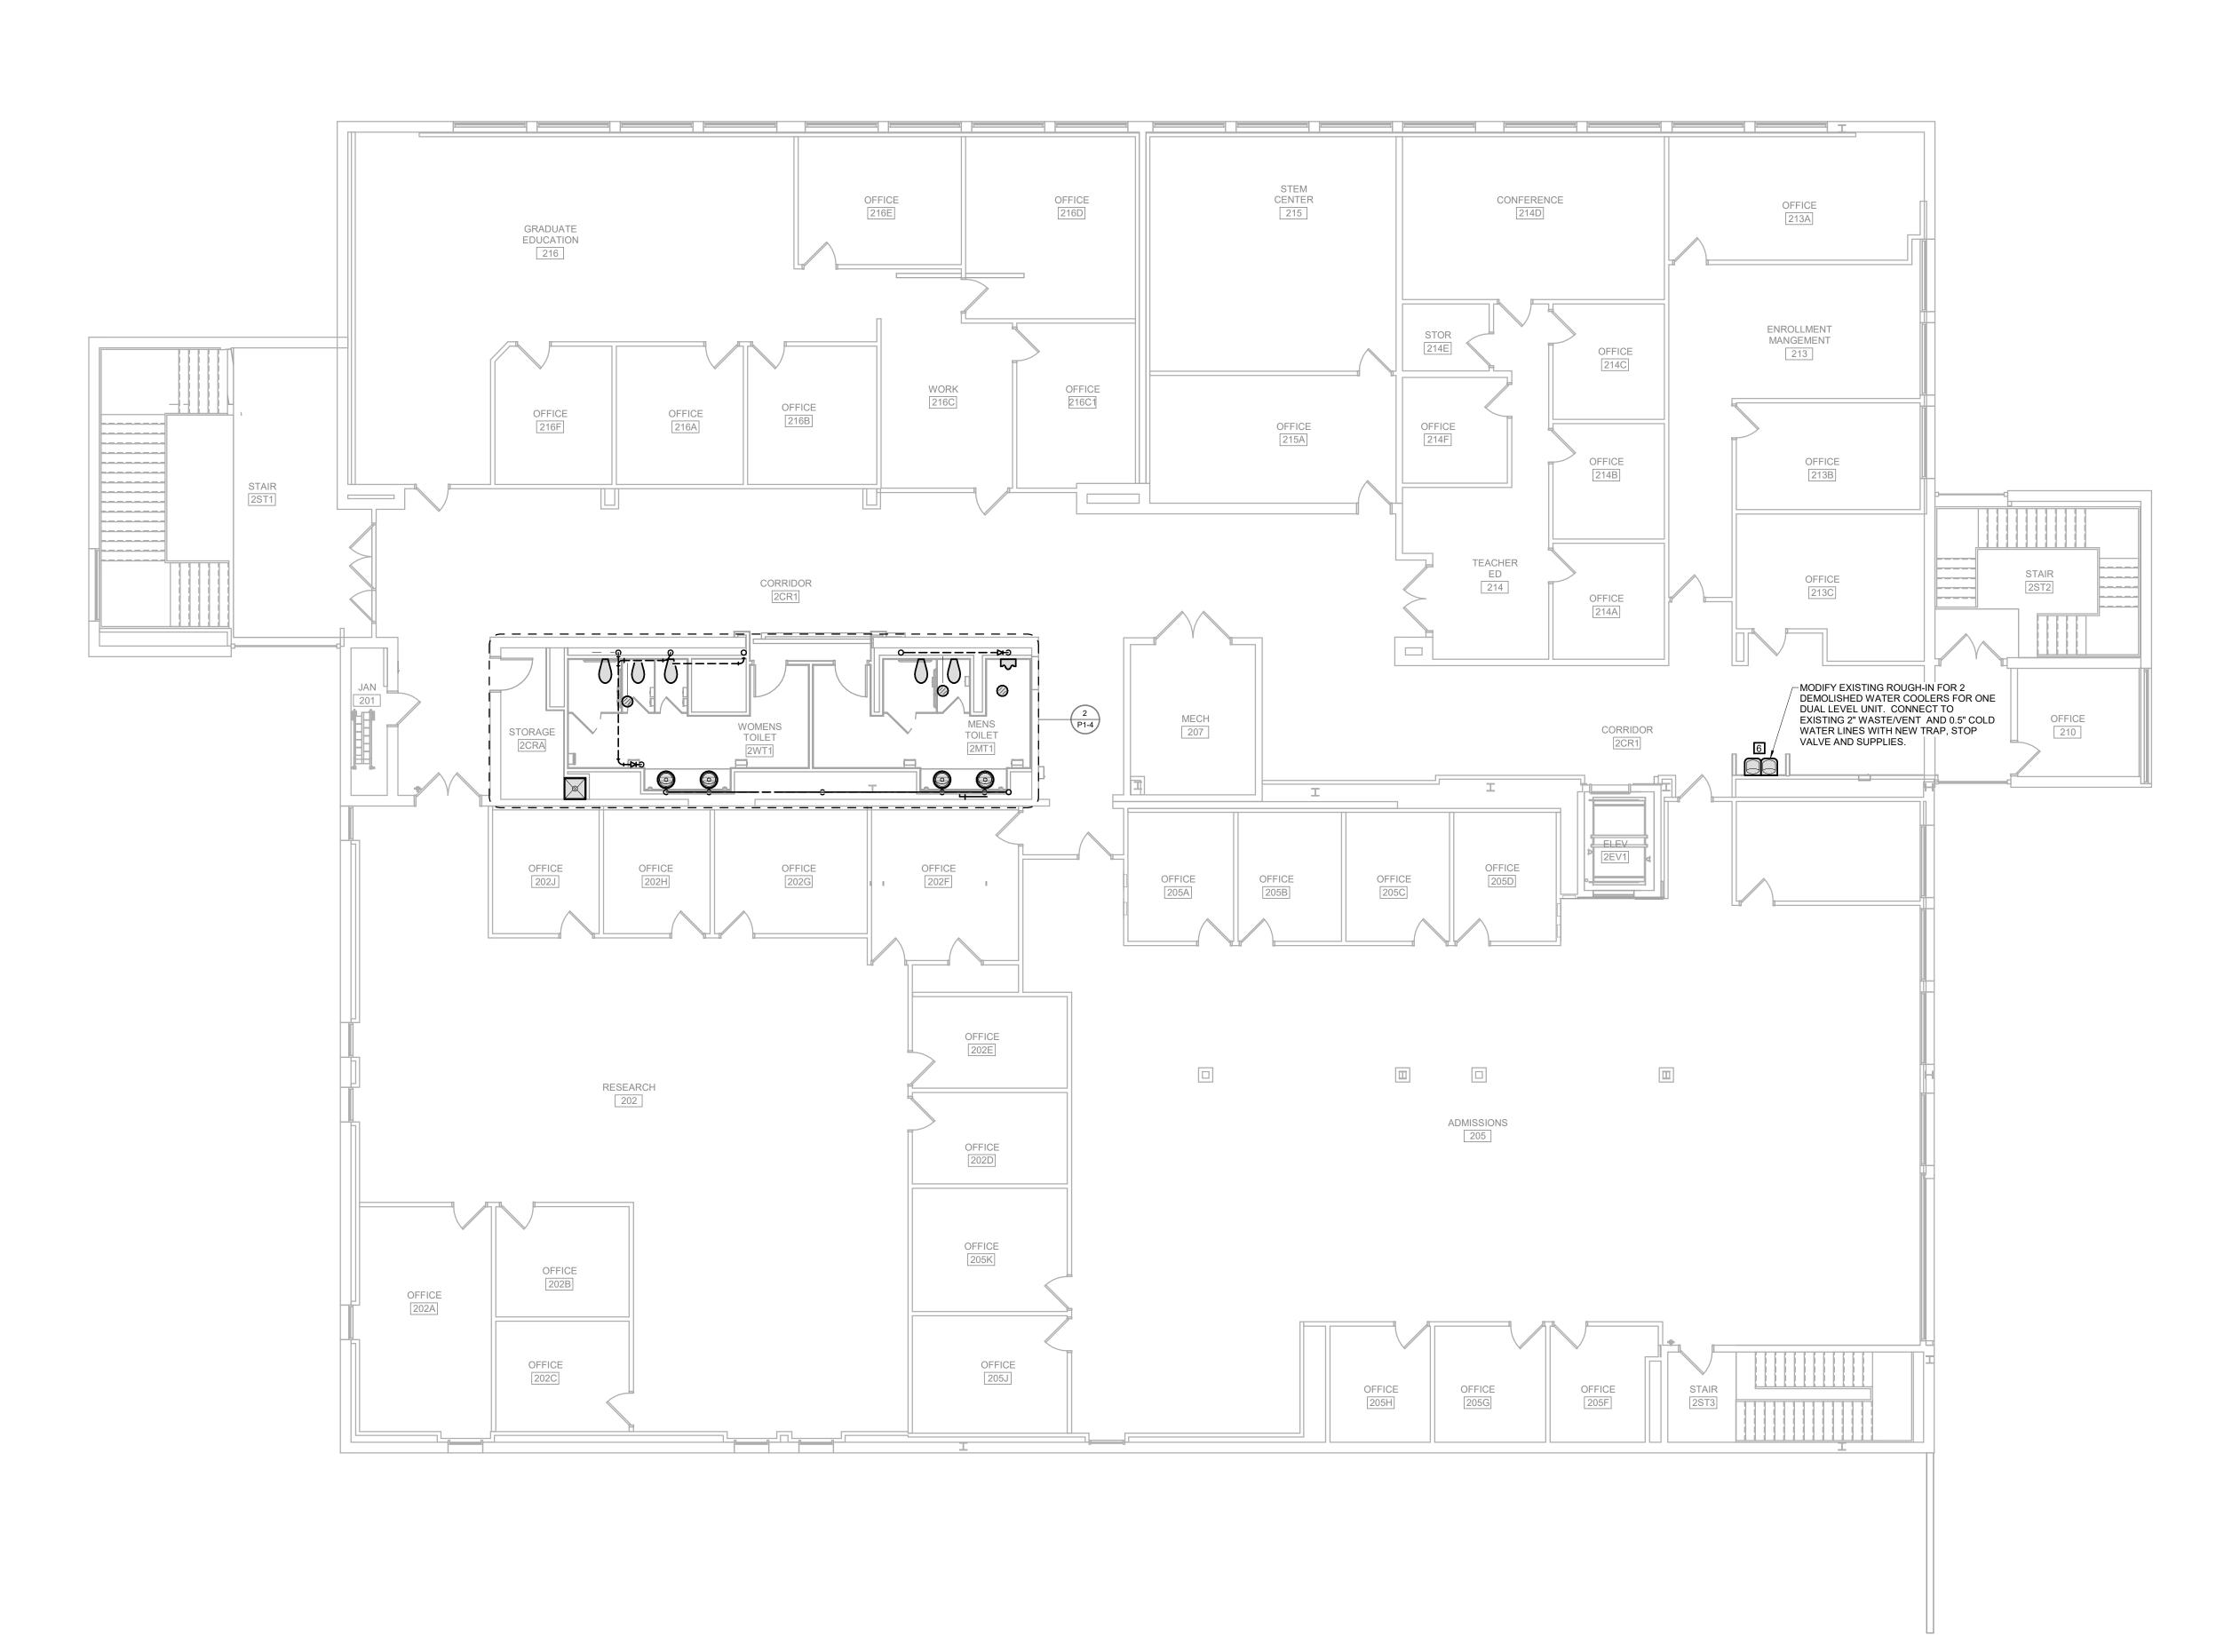

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### **GENERAL NOTES:**

- CONTRACTOR SHALL CONTACT THE UNIVERSITY AND ARRANGE FOR FIRE SERVICE AS INDICATED ON DRAWINGS. PROVIDE ALL MATERIALS AS REQUIRED FOR SERVICE INSTALLATION. ALL WORK SHALL BE IN ACCORDANCE REQUIREMENTS OF LOCAL AUTHORITIES.
- PROVIDE ALL PIPING ADJUSTMENTS AS NEEDED FOR NEW PLUMBING FIXTURE LAYOUT. PROVIDE ANY REQUIRED CUTTING AND PATCHING AS NEEDED FOR REPLACEMENT OR TIE-IN. CLEAN AND FLUSH OUT NEW PIPING. ALL PIPING SHALL BE PRESSURE TESTED IN ACCORDANCE WITH CODES AND LOCAL AUTHORITIES. PROVIDE ALL NEW WASTE PIPING ABOVE GRADE FOR NEW WALL MOUNT PLUMBING FIXTURES. VERIFY ROUTING, SLOPE, AND TIE-IN LOCATION. EXTEND NEW VENT LINES UP AND CONNECT TO EXISTING.
- INSTALL ALL PIPING PARALLEL WITH BUILDING LINES AND PARALLEL WITH OTHER PIPING TO OBTAIN A NEAT AND ORDERLY APPEARANCE OF PIPING SYSTEMS. ALL PIPING SHALL BE CONCEALED UNLESS NOTED OTHERWISE. SECURE PIPING WITH APPROVED ANCHORS AND PROVIDE GUIDES WHERE REQUIRED TO INSURE PROPER DIRECTION OF PIPING EXPANSION. PIPING SHALL BE INSTALLED SO THAT ALLOWABLE STRESS FOR PIPING, VALVES, AND FITTINGS USED ARE NOT EXCEEDED DURING NORMAL OPERATION OR TESTING OF PIPING
- PROVIDE PLUMBING FIXTURES AS SHOWN ON DRAWINGS AS SPECIFIED COMPLETE INCLUDING PIPING AND CONNECTIONS. FIXTURES FITTING AGAINST WALLS SHALL HAVE GROUND BACKS. EXPOSED PIPING AND FITTING SHALL BE CHROME PLATED. SET FIXTURES TRUE AND LEVEL WITH ALL NECESSARY SUPPORTS FOR FIXTURES INSTALLED BEFORE PLASTERING IS DONE. NIPPLES THROUGH WALL TO FIXTURE CONNECTION SHALL BE CHROME PLATED BRASS. CONTRACTOR MAY USE COPPER STUB OUTS TO STOPS UNDER LAVATORIES, PROVIDED DEEP ESCUTCHEONS ARE USED AND NO COPPER IS VISIBLE IN LIEU OF CHROME NIPPLES. PROVIDE ALL NEW CHROME PLATED BRASS TRAPS AND STAINLESS-STEEL SUPPLIES WITH COMPRESSION INLET ANGLE COMPRESSION STOP AT ALL APPLICABLE FIXTURES. PROVIDE OFFSET TRAPS AND FLUSH LEVER FOR URINALS AND WATER CLOSET AS REQUIRED FOR ADA COMPLIANCE. PROVIDE FLOOR MOUNT NEW CARRIERS FOR PLUMBING FIXTURES. ALL FIXTURES
- NECESSARY TO PROVIDE ACCESS TO VALVES, TRAPS, ETC LOCATED IN CONCEALED SPACES FACH FIRE DAMPER. AUTOMATIC SPLITTER DAMPER, ETC., SHALL HAVE AN ACCESS PANEL. SIZE SHALL BE ADEQUATE FOR INSPECTION AND REMOVAL OF EQUIPMENT AND NONE SHALL BE LESS THAN 12-INCH BY 6-INCH.
- 2 2" WASTE UP TO URINAL.
- 3 0.75" DOMESTIC COLD AND HOT WATER DOWN TO FIRST FLOOR

- 7 0.75" HOT WATER UP AND DOWN TO JANITOR BASINS. PROVIDE
- 8 3" CIRCUIT VENT UP. CONNECT TO EXISTING VENT THROUGH ROOF.

- SHALL BE INSTALLED FOR ADA COMPLIANCE. ACCESS PANELS SHALL BE PROVIDED WHEREVER **PLAN HEX NOTES:**
- 1 4" WASTE UP TO WALL CLEANOUT.
- LAVATORIES AND UP TO SECOND FLOOR LAVATORIES. TEE AT EACH LEVEL AND PROVIDE 0.5" HOT AND COLD WATER TO EACH
- 4 4" WASTE PIPING DOWN.
- 5 3" CIRCUIT VENT UP.
- 6 0.75" COLD WATER UP AND DOWN TO JANITOR BASINS. PROVIDE VERTICAL SHUTOFF TO SECOND FLOOR BASIN.
- VERTICAL SHUTOFF TO SECOND FLOOR BASIN.

0.5" DHW-0.5" DCW-REMOVE AND REPLACE ALL **BRANCH LINES TO FIXTURES** 3" DCW \_ EXISTING CONNECT TO EXISTING MAINS WITH NEW SHUT-OFF VALVE 2" DHW FIELD VERIFY MAIN SIZES EXISTING AND TIE-IN LOCATIONS. TYPICAL. 0.75" DRW EXISTING CONNECT-INTO EXISTING 1" DCW-SHUT-OFF VALVE LOCATED -ABOVE ACCESSIBLE CONNECT-CEILING FOR EACH PIPE INTO EXISTING BRANCH. TYPICAL. 1.25" DCW TO EACH WC. INTO EXISTING


-SHOCK ABSORBER

---1.25" DCW

INSTALLED PRIOR TO LAST

FLUSH VALVE. TYPICAL

3 DOMESTIC WATER RISER
P1-4 SCALE: NOT TO SCALE

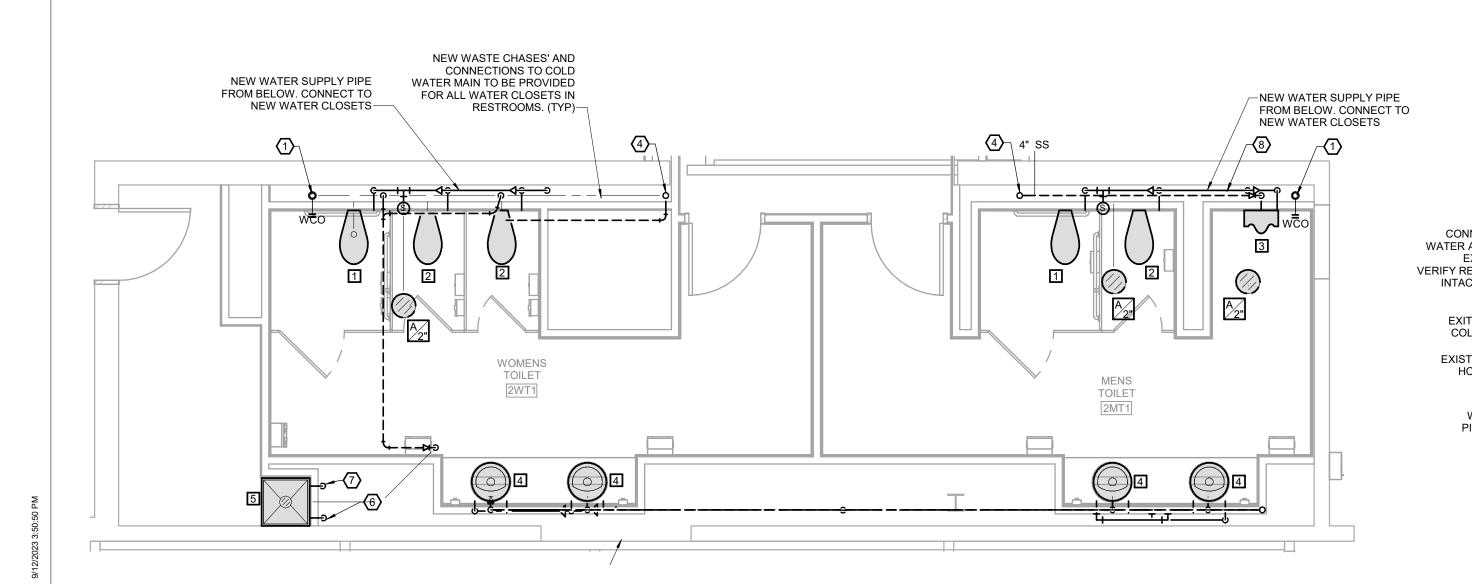

**EXISTING SANITARY SEWER.-**FIELD VERIFY SIZE AND LOCATION PRIOR TO START OF

WASTE AND VENT RISER
SCALE: NOT TO SCALE

CONSTRUCTION.

REPLACE EXISTING BRANCH LINES. COORDINATE TIE-IN LOCATION AND DEPTH

WITH EXISTING MAINS-


2" SS\_\_

-CONNECT TO

EXISTING VTR

CONNECTING TO-

EXISTING VTR

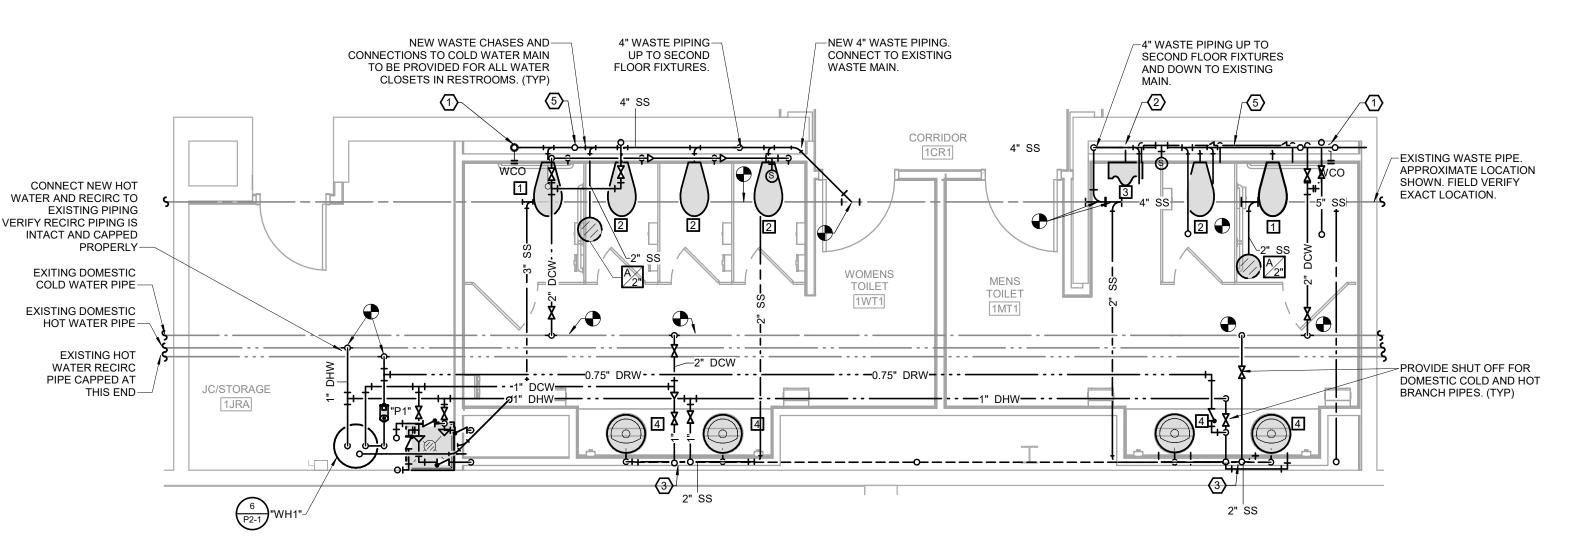

SECOND LEVEL RESTROOM PLUMBING PLAN
SCALE: 1/4" = 1'-0"
NORTH

FIRST LEVEL RESTROOM PLUMBING PLAN
P1-4 SCALE: 1/4" = 1'-0"

NORTH

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PH: 417.885.0002

TENNIAL HALL IMPROVEMEN RENOVATION

PROJECT ENGINEER: Approver DRAWN BY: CHECKED BY:

PROJECT NUMBER: 22-703A

RC000638

8.28.2023

**ENLARGED** PLUMBING PLAN

SHEET NUMBER:

P1-4


DI	DRAINAGE PIPE SPECIALTY SCHEDULE												
PLAN MARK	DESCRIPTION	MANUFACTURER	MODEL	TRIM	NOTES								
Α	7" ROUND FLOOR DRAIN	J.R. SMITH	2010-A		DRAIN SIZE SHALL MATCH SANITARY BRANCH SERVING DRAIN. REFERENCE PLANS FOR SIZE.								
WCO	WALL CLEANOUT	J.R. SMITH	4532 WITH CLEANOUT PLUG OR 4512 WITH COUNTERSUNK PLUG		CLEANOUT TO BE FULL SIZE OF SOIL PIPE UP TO AND INCLUDING 4-INCH ID. REFERENCE PLANS FOR SOIL PIPE SIZE.								

PIPE MATERIAL SO	CHEDUI	LE										
			PIPING				FITT	INGS	MAX. V	VORKING	FIELD	TEST
									PRESS.	TEMP.	PRESS.	
SYSTEM	SIZE	TYPE	SCHEDULE	GRD	ASTM	MATERIAL	MATERIAL	TYPE	(PSI)	(°F)	(PSI)	TIME
DOMESTIC WATER ABOVE GRADE	ALL	L	-	-	B88	CP	СР	SJ	120	40-180	150	1 HR
FIRE SPRINKLER SERVICE	4" & UP	PVC	-	-	AWWA C900	PVC	DI	MJ	200	50-90	200	2 HR
FIRE PROTECTION	ALL	STEEL	40	-	PER	NFPA	13	-	-	-	200	2 HR
WASTE & VENT BELOW GRADE	ALL	DWV	40	-	2665	PVC	PVC	DR\SW	10 ft	50-140	10 ft	1 HR
WASTE & VENT ABOVE GRADE (PLENUM RETURN)	ALL	NH	SS	-	A74	CI	CI	DR\NH	10 FT	50-180	10 FT	1 HR
SLIMD DLIMD DISCHARGE	ΔΙΙ	NH	22		Δ7/	CI	CI	DR/NH	10 FT	40-80	10 FT	1 HR


W	ATER I	HEA	TER	SCHI	EDI	JLE								
PLAN	PLAN		GALLON	GALLON GPH @ ELECT			CTRIC HEATING			ELECTRICAL	DATA			
MARK	MANUFACTURER	MODEL	TYPE	CAPACITY	90 F	WATTS	AMPS	VOLTAGE	PHASE	VOLTAGE	PHASE	MCA	MOCP	NOTES
WH1	A.O. SMITH	DEL-30	ELECTRIC	36	20	4500	22 A	208	1	208	1	28	30	PTRV, AQUASTAT AND TIMER KIT

P	JMP SO	CHE	DU	LE											
									ELE	CTRICAL DA	TA			FLUID	
PLAN				INLET	FLOW	TOTAL HEAD	NPSH		MOTOR			BODY	FLUID	TEMPERATURE	
MARK	MANUFACTURER	SERIES	SIZE	(IN)	(GPM)	(FT HD)	(FT HD)	TYPE	(HP)	VOLTAGE	PHASE	CONSTRUCTION	PUMPED	(°F)	NOTES
P1	BELL & GOSSETT	NBF	12	0.75"	3	10	0	IL	0.06	120	1	AB	DCW	130	AQUASTAT AND TIMER KIT

S	SUMP PUMP SCHEDULE												
PLAN				FLOW	TOTAL	ELE	CTRICAL DAT	Ά					
MARK	MANUFACTURER	SERIES	TYPE	(GPM)	HEAD	MOTOR (HP)	VOLTAGE	PHASE	NOTES				
SP1	STANCOR	SE-50	SP	50 GPM	20	0.5	120 V	1	OIL MINDER CONTROL SYSTEM WITH SS SENSOR PROBE, SINGLE POINT POWER PLUG, ALARM, REMOTE MONITORING.				

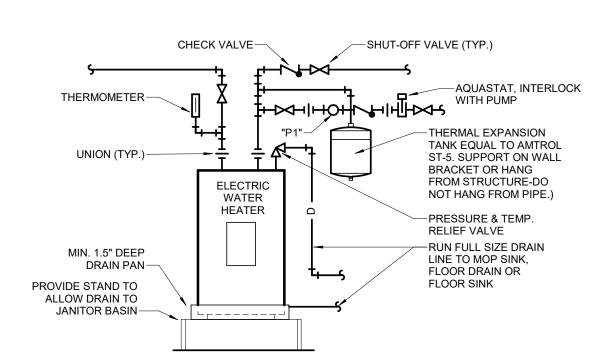




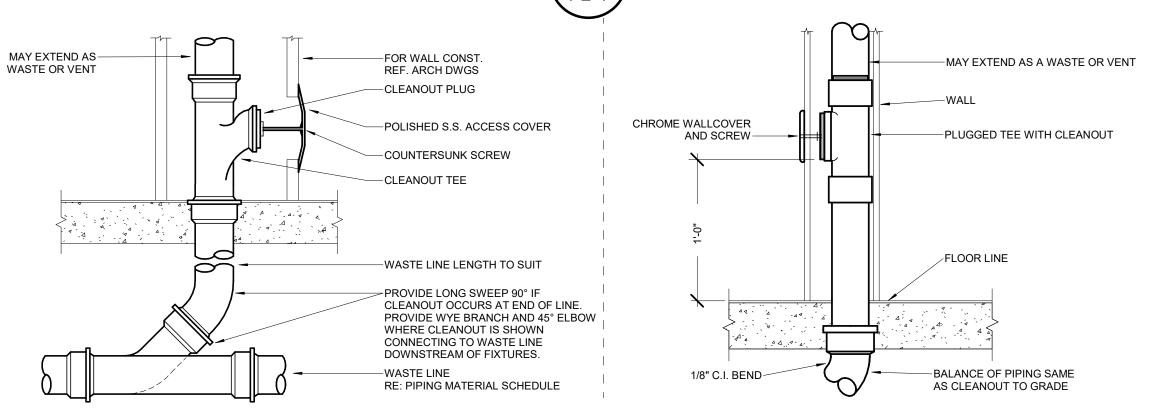



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5 WALL CLEANOUT DETAIL
P2-1 SCALE: NOT TO SCALE

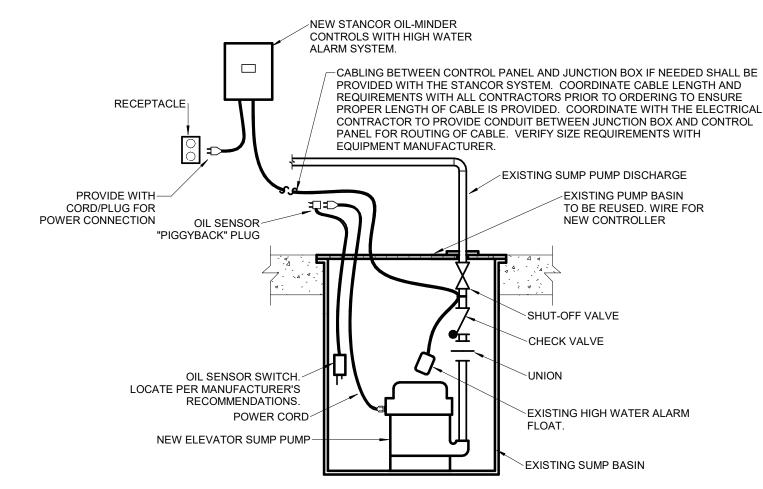

4 ELEVATOR PIT SUMP PUMP DETAIL
P2-1 SCALE: NOT TO SCALE



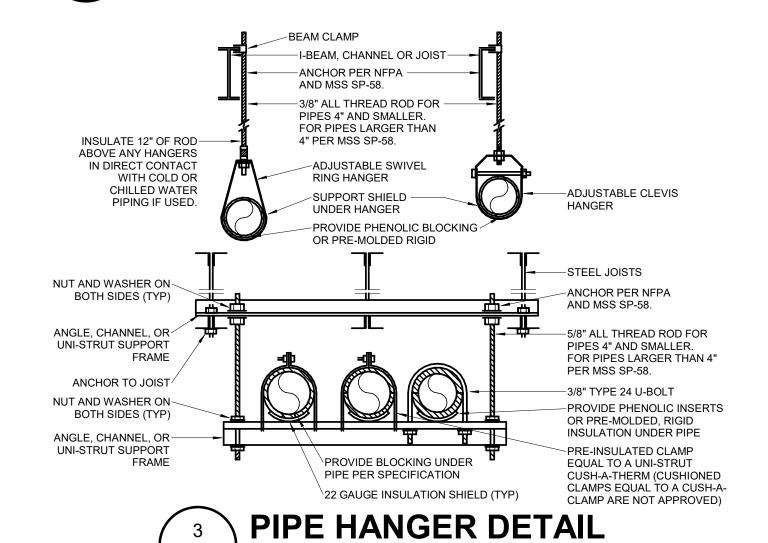

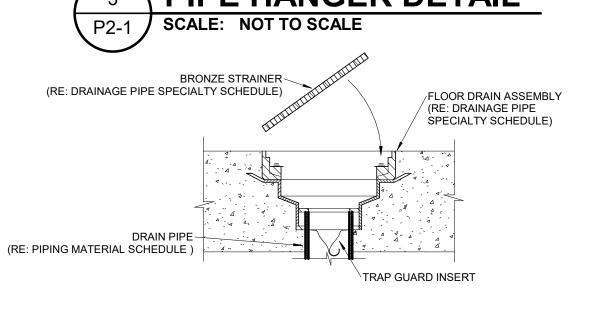NOTES:


1. TRAP GUARD SHALL BE INSTALLED PER MANUFACTURER'S INSTRUCTIONS.

2. REFER TO PLANS FOR TRAP GUARD SIZE AND QUANTITY.

3. FLOOR DRAINS IN THE KITCHEN SHALL NOT HAVE TRAP GUARD.

4. TRAP GUARDS BY SURE SEAL OR PROSET.



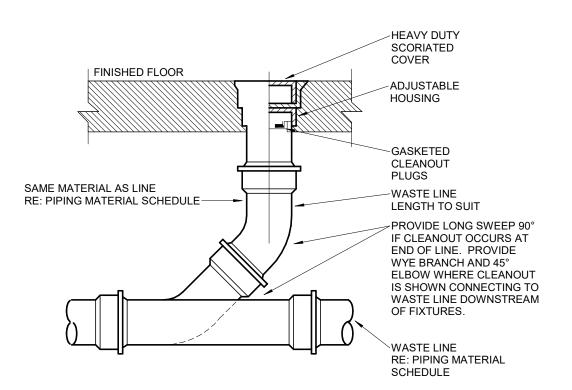

1 FLOOR CLEANOUT DETAIL
P2-1 SCALE: NOT TO SCALE



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CENTENNIAL HALL IMPROVEMENTS
AND RENOVATION

PROJECT ENGINEER: Approver DRAWN BY: LDN CHECKED BY: JAL

PROJECT NUMBER:

22-703A RC000638

DATE: 8.28.2023

PLUMBING DETAILS & SCHEDULES

SHEET NUMBER:

P2-1






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AND RENOVATION

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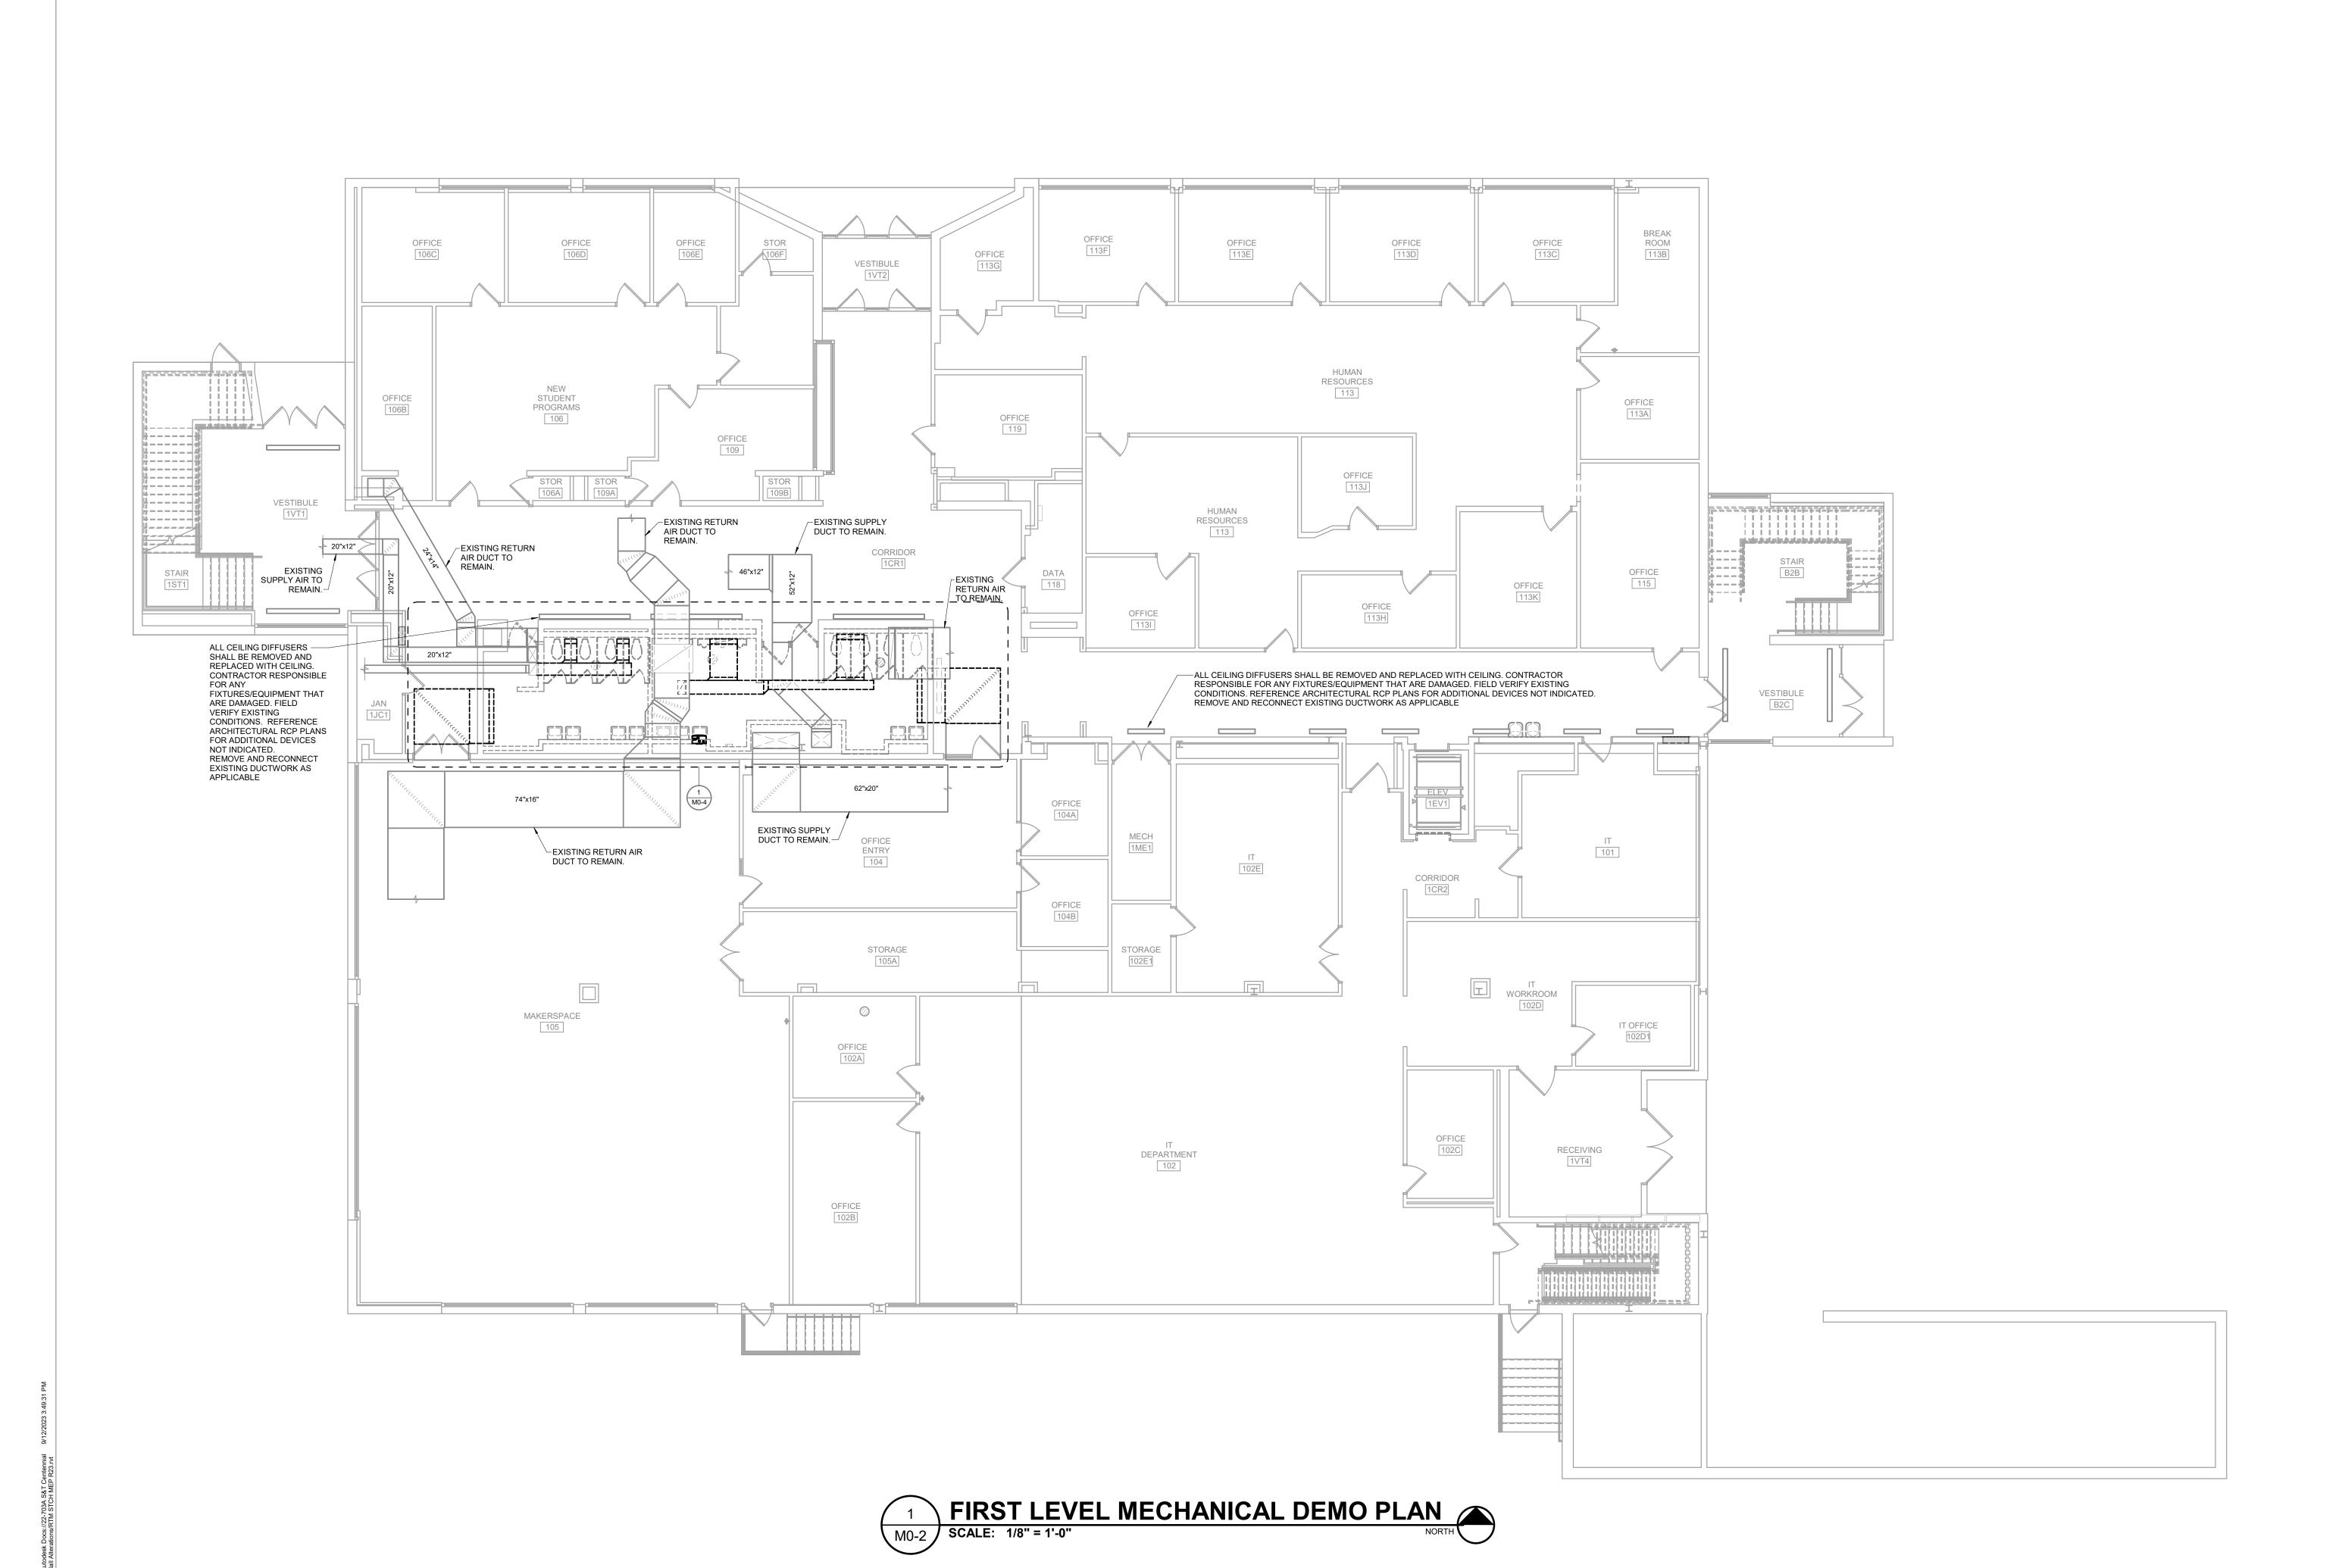
PROJECT NUMBER: 22-703A RC000638

8.28.2023


FIRST LEVEL MECHANICAL DEMO PLAN

SHEET NUMBER:

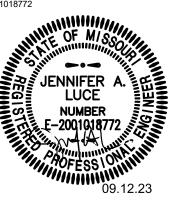**M0-2** 



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CENTENNIAL HALL IMPROVEMENTS AND RENOVATION

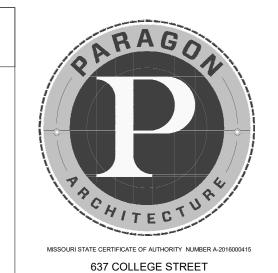PROJECT ENGINEER: Approver DRAWN BY: LDN


PROJECT NUMBER: 22-703A RC000638

8.28.2023

SECOND LEVEL MECHANICAL DEMO PLAN

SHEET NUMBER:

M0-3

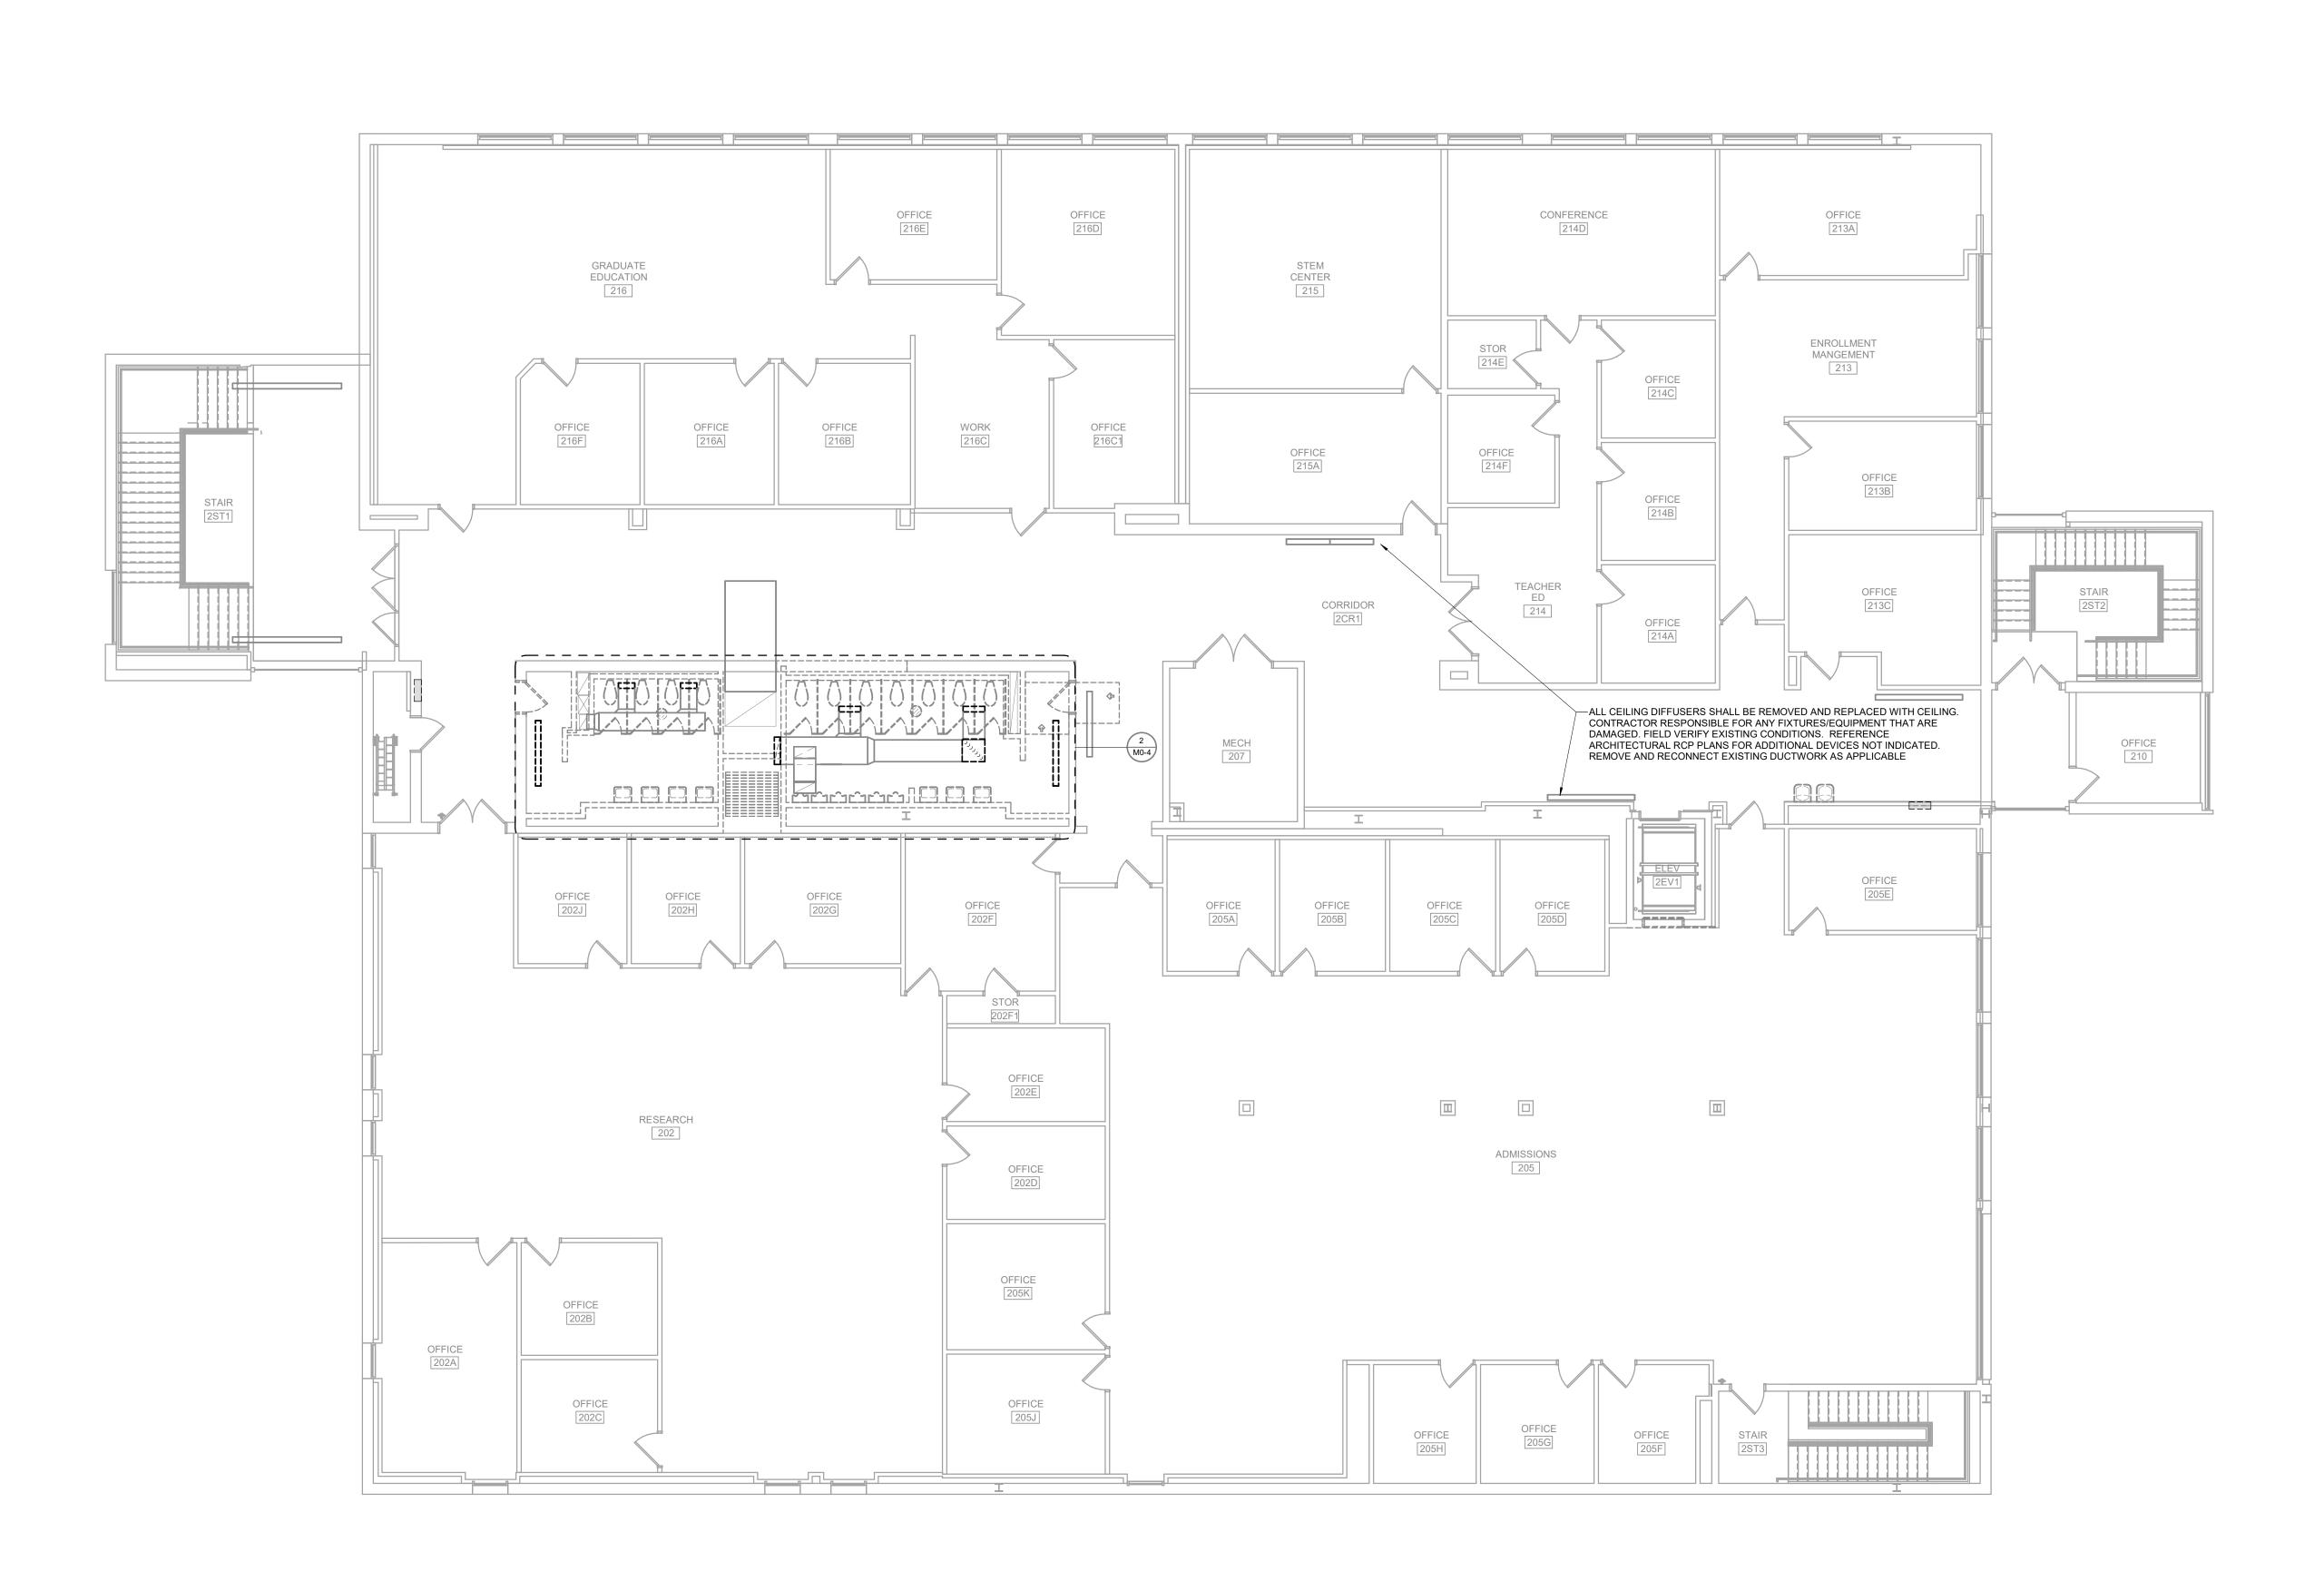

SECOND LEVEL MECHANICAL DEMO PLAN
SCALE: 1/8" = 1'-0"
NORTH

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### GENERAL DEMOLITION NOTES:

- A. OWNER SHALL HAVE FIRST RIGHT OF REFUSAL FOR ALL DEMOLISHED MATERIALS AND EQUIPMENT. STORE ITEMS ON SITE AS DIRECTED BY OWNER.
- B. EXISTING CONDITIONS ON THIS SET OF BID DOCUMENTS
  WERE TAKEN FROM EXISTING DRAWINGS, LIMITED SITE
  VISITS, AND VISUAL OBSERVATIONS. FIELD VERIFY ALL
  EXISTING CONDITIONS PRIOR TO SUBMITTING FINAL BIDS.
  CHANGE ORDERS WILL NOT BE PAID DUE TO
- UNANTICIPATED CONDITIONS TO MEET INTENT OF WORK.

  C. REFER TO ARCHITECTURAL DEMOLITION PLANS FOR PHASING AND EXTENTS OF DEMOLITION.
- D. PROVIDE TEMPORARY HEATING AND/OR COOLING AS REQUIRED BY THE GENERAL CONTRACTOR OR CONSTRUCTION MANAGER AND AS REQUIRED PER THE SPECIFICATIONS.
- E. CONTRACTOR SHALL BE RESPONSIBLE FOR ALL CORING, PATCH, AND REPAIR OF ALL WALL AND FLOOR SYSTEMS AS REQUIRED DUE TO CONSTRUCTION WORK. MAINTAIN ALL FIRE RATINGS.
- REMOVE ALL UNUSED SHEET METAL WORK AND PIPING LOCATED WITHIN THE AREA OF CONSTRUCTION.

### **PLAN HEX NOTES:**

- 1 EXISTING 250 CFM LINEAR EXHAUST DIFFUSER.
- 2 EXISTING 370 CFM LINEAR EXHAUST DIFFUSER.
- 3 EXISTING LINEAR SLOT GRILLE TO BE REMOVED.
- 4 EXISTING RETURN DOWN. REMOVE AND REROUTE AS NECESSARY. FIELD VERIFY EXISTING SIZE AND LOCATION
- 5 EXISTING 400 CFM LINEAR DIFFUSER TO BE REMOVED.
  - EXISTING 400 CFM LINEAR DIFFUSER TO BE REMOVED.

7 EXISTING INSTANTANEOUS WATER HEATER ABOVE CEILING TO

- 6 EXISTING 200 CFM EXHAUST LINEAR DIFFUSER TO BE
- REMOVED.
- 8 EXISTING SUPPLY DOWN TO REMAIN.
- 9 EXISTING RETURN DUCT TO REMAIN.
- 10 EXISTING 56"X38" RETURN UP TO REMAIN.11 EXISTING EXHAUST DUCTWORK TO BE REMOVED AND
- REPLACED WITH NEW TO ACCOMMODATE NEW RESTROOM LAYOUT. REFER TO 2/M1-4 FOR NEW DUCT ROUTING.
- 12 EXISTING EXHAUST DUCTWORK TO BE REMOVED AND REPLACED WITH NEW TO ACCOMMODATE NEW RESTROOM LAYOUT. REFER TO 1/M1-4 FOR NEW DUCT ROUTING.
- 13 EXISTING SUPPLY DUCT TO REMAIN.



MISSOURI STATE CERTIFICATE OF AUTHORITY NUMBER A-2016000415
637 COLLEGE STREET
SPRINGFIELD, MO 65806


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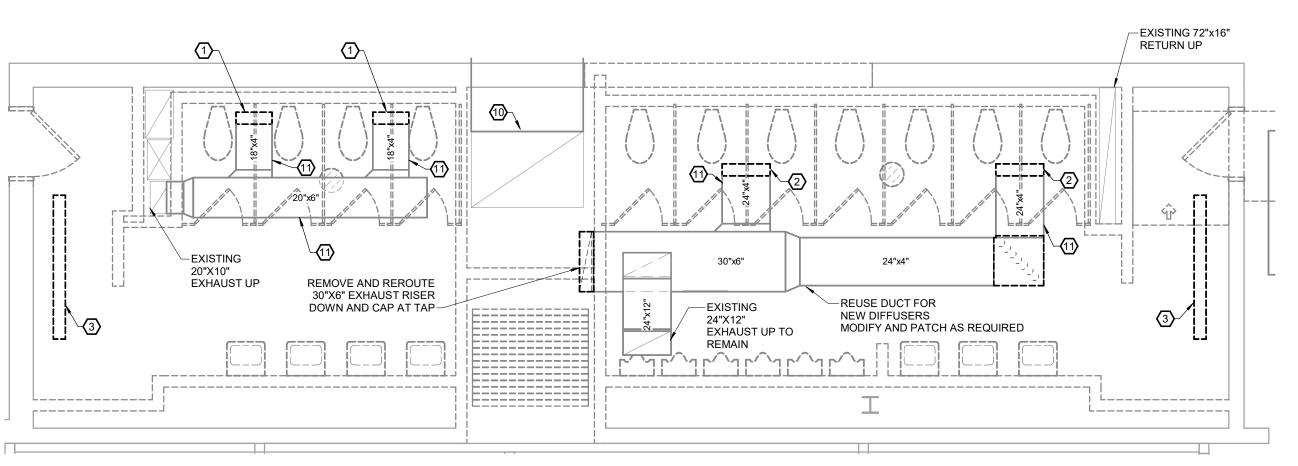
STATE OF MISSOURI CERTIFICATE OF AUTHORITY: #2014035826 FOR ENGINEERING

JENNIFER A. LUCE E-2001018772




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REVISION SCHEDULE

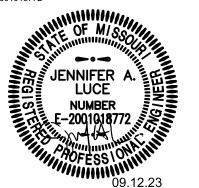

# SECOND LEVEL RESTROOM MECHANICAL DEMO PLAN SCALE: 1/4" = 1'-0"

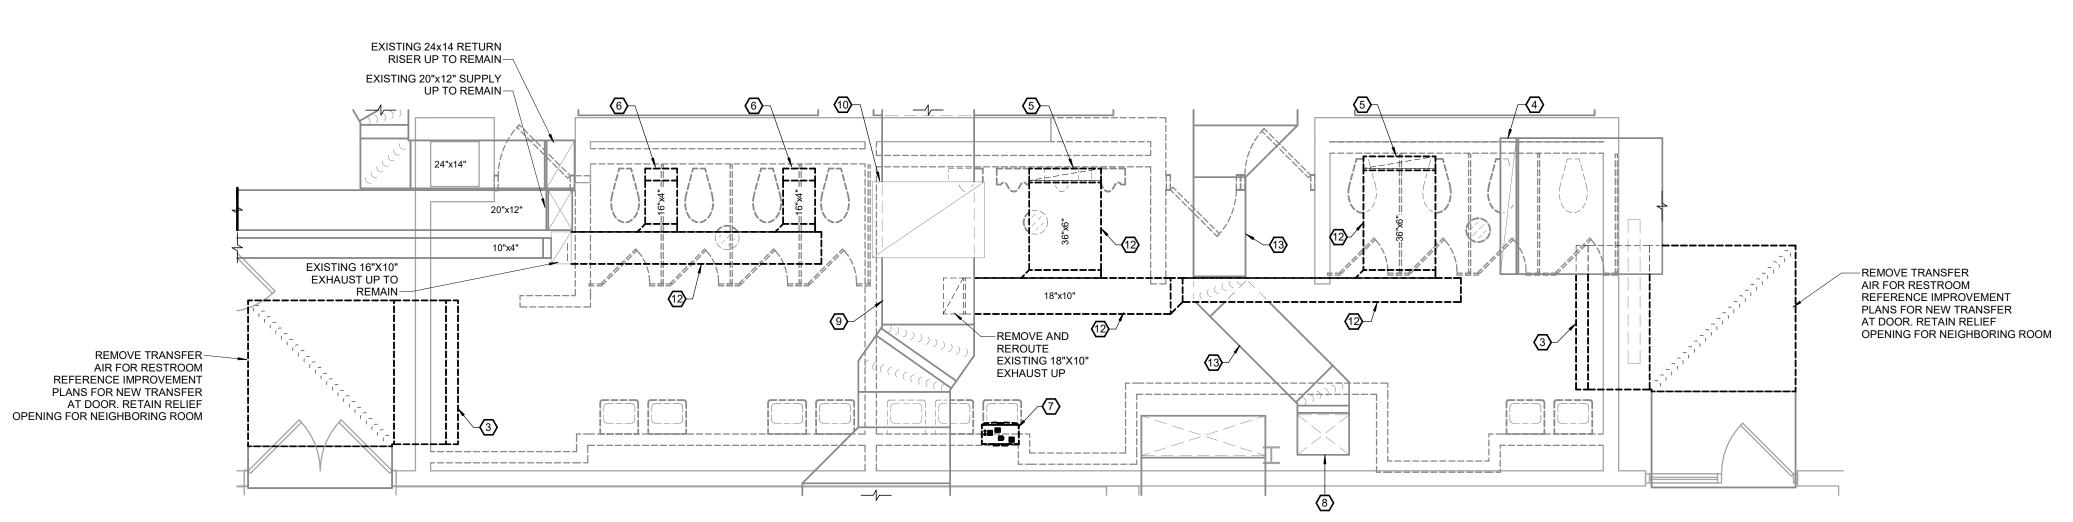

FIRST LEVEL RESTROOM MECHANCIAL DEMO PLAN
MO-4 SCALE: 1/4" = 1'-0"

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CENTENNIAL HALL IMPROVEMENT
AND RENOVATION

PROJECT NUMBER: 22-703A RC000638 DATE: 8.28.2023

PROJECT ENGINEER: Approver

DRAWN BY:

CHECKED BY:

ENLARGED MECHANICAL DEMO PLAN

SHEET NUMBER:

M0-4

REFER TO SHEET M2-1 FOR GENERAL NOTES.



637 COLLEGE STREET SPRINGFIELD, MO 65806


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#2014035826 FOR ENGINEERING

JENNIFER A. LUCE E-2001018772



REVISION SCHEDULE

CENTENNIAL HALL IMPROVEMENTS
AND RENOVATION

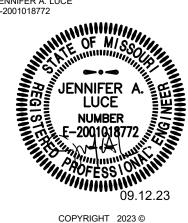PROJECT ENGINEER: Approver DRAWN BY: LDN CHECKED BY:


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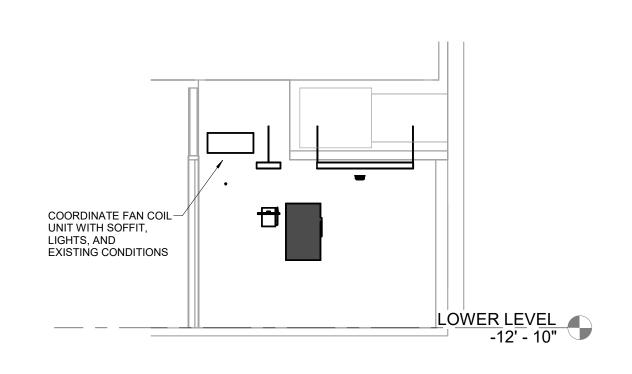
DATE: 8.28.2023

LOWER LEVEL MECHANICAL PLAN

SHEET NUMBER:


M1-1



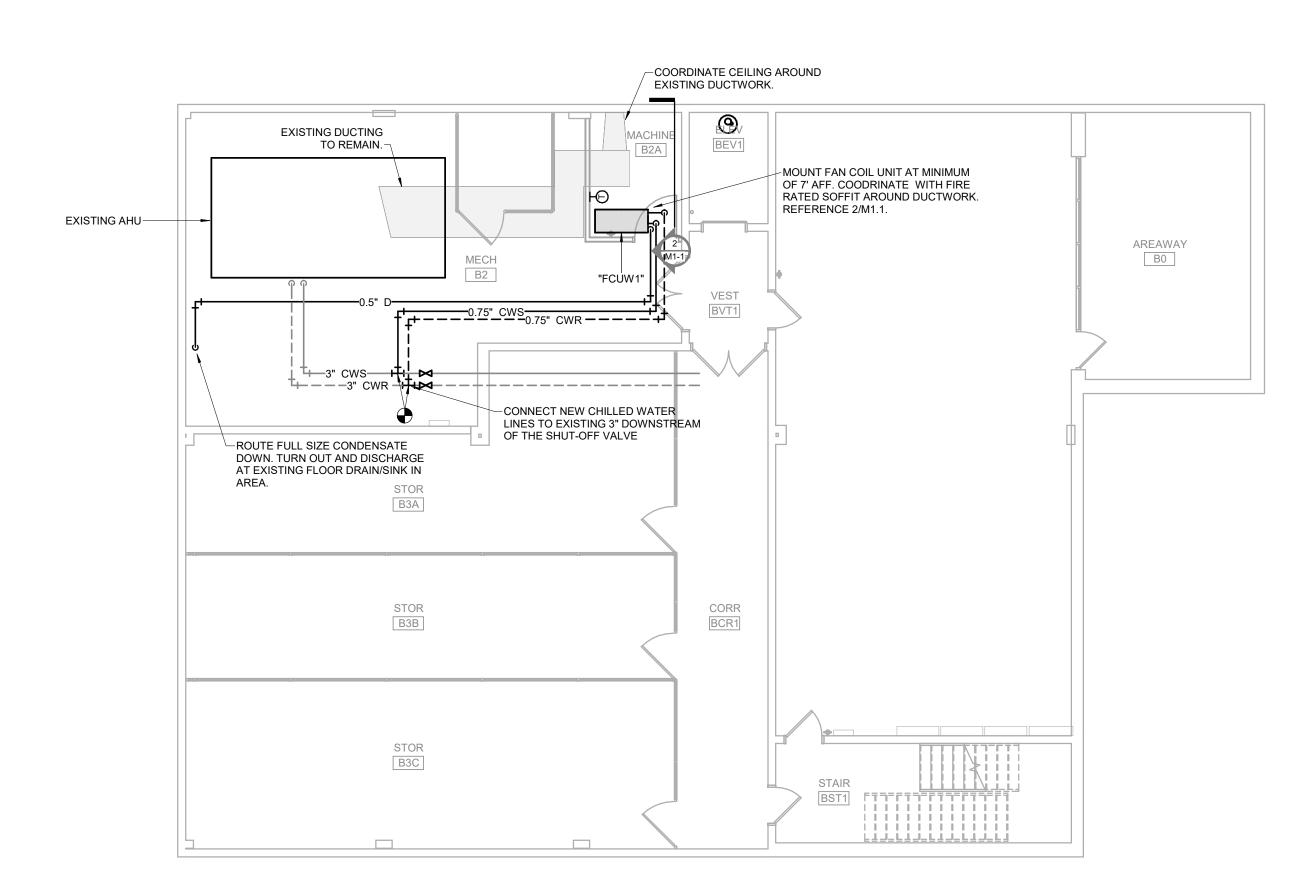



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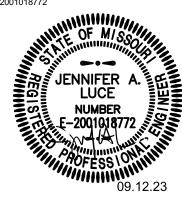
MISSOURI STATE CERTIFICATE OF AUTHORITY NUMBER A-2016000415 637 COLLEGE STREET SPRINGFIELD, MO 65806
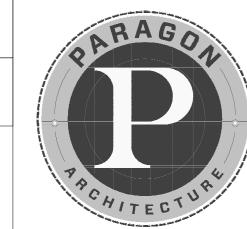
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CENTENNIAL HALL IMPROVEMENTS
AND RENOVATION


PROJECT ENGINEER: Approver DRAWN BY:

PROJECT NUMBER: 22-703A RC000638

FIRST LEVEL MECHANICAL PLAN

SHEET NUMBER:

M1-2

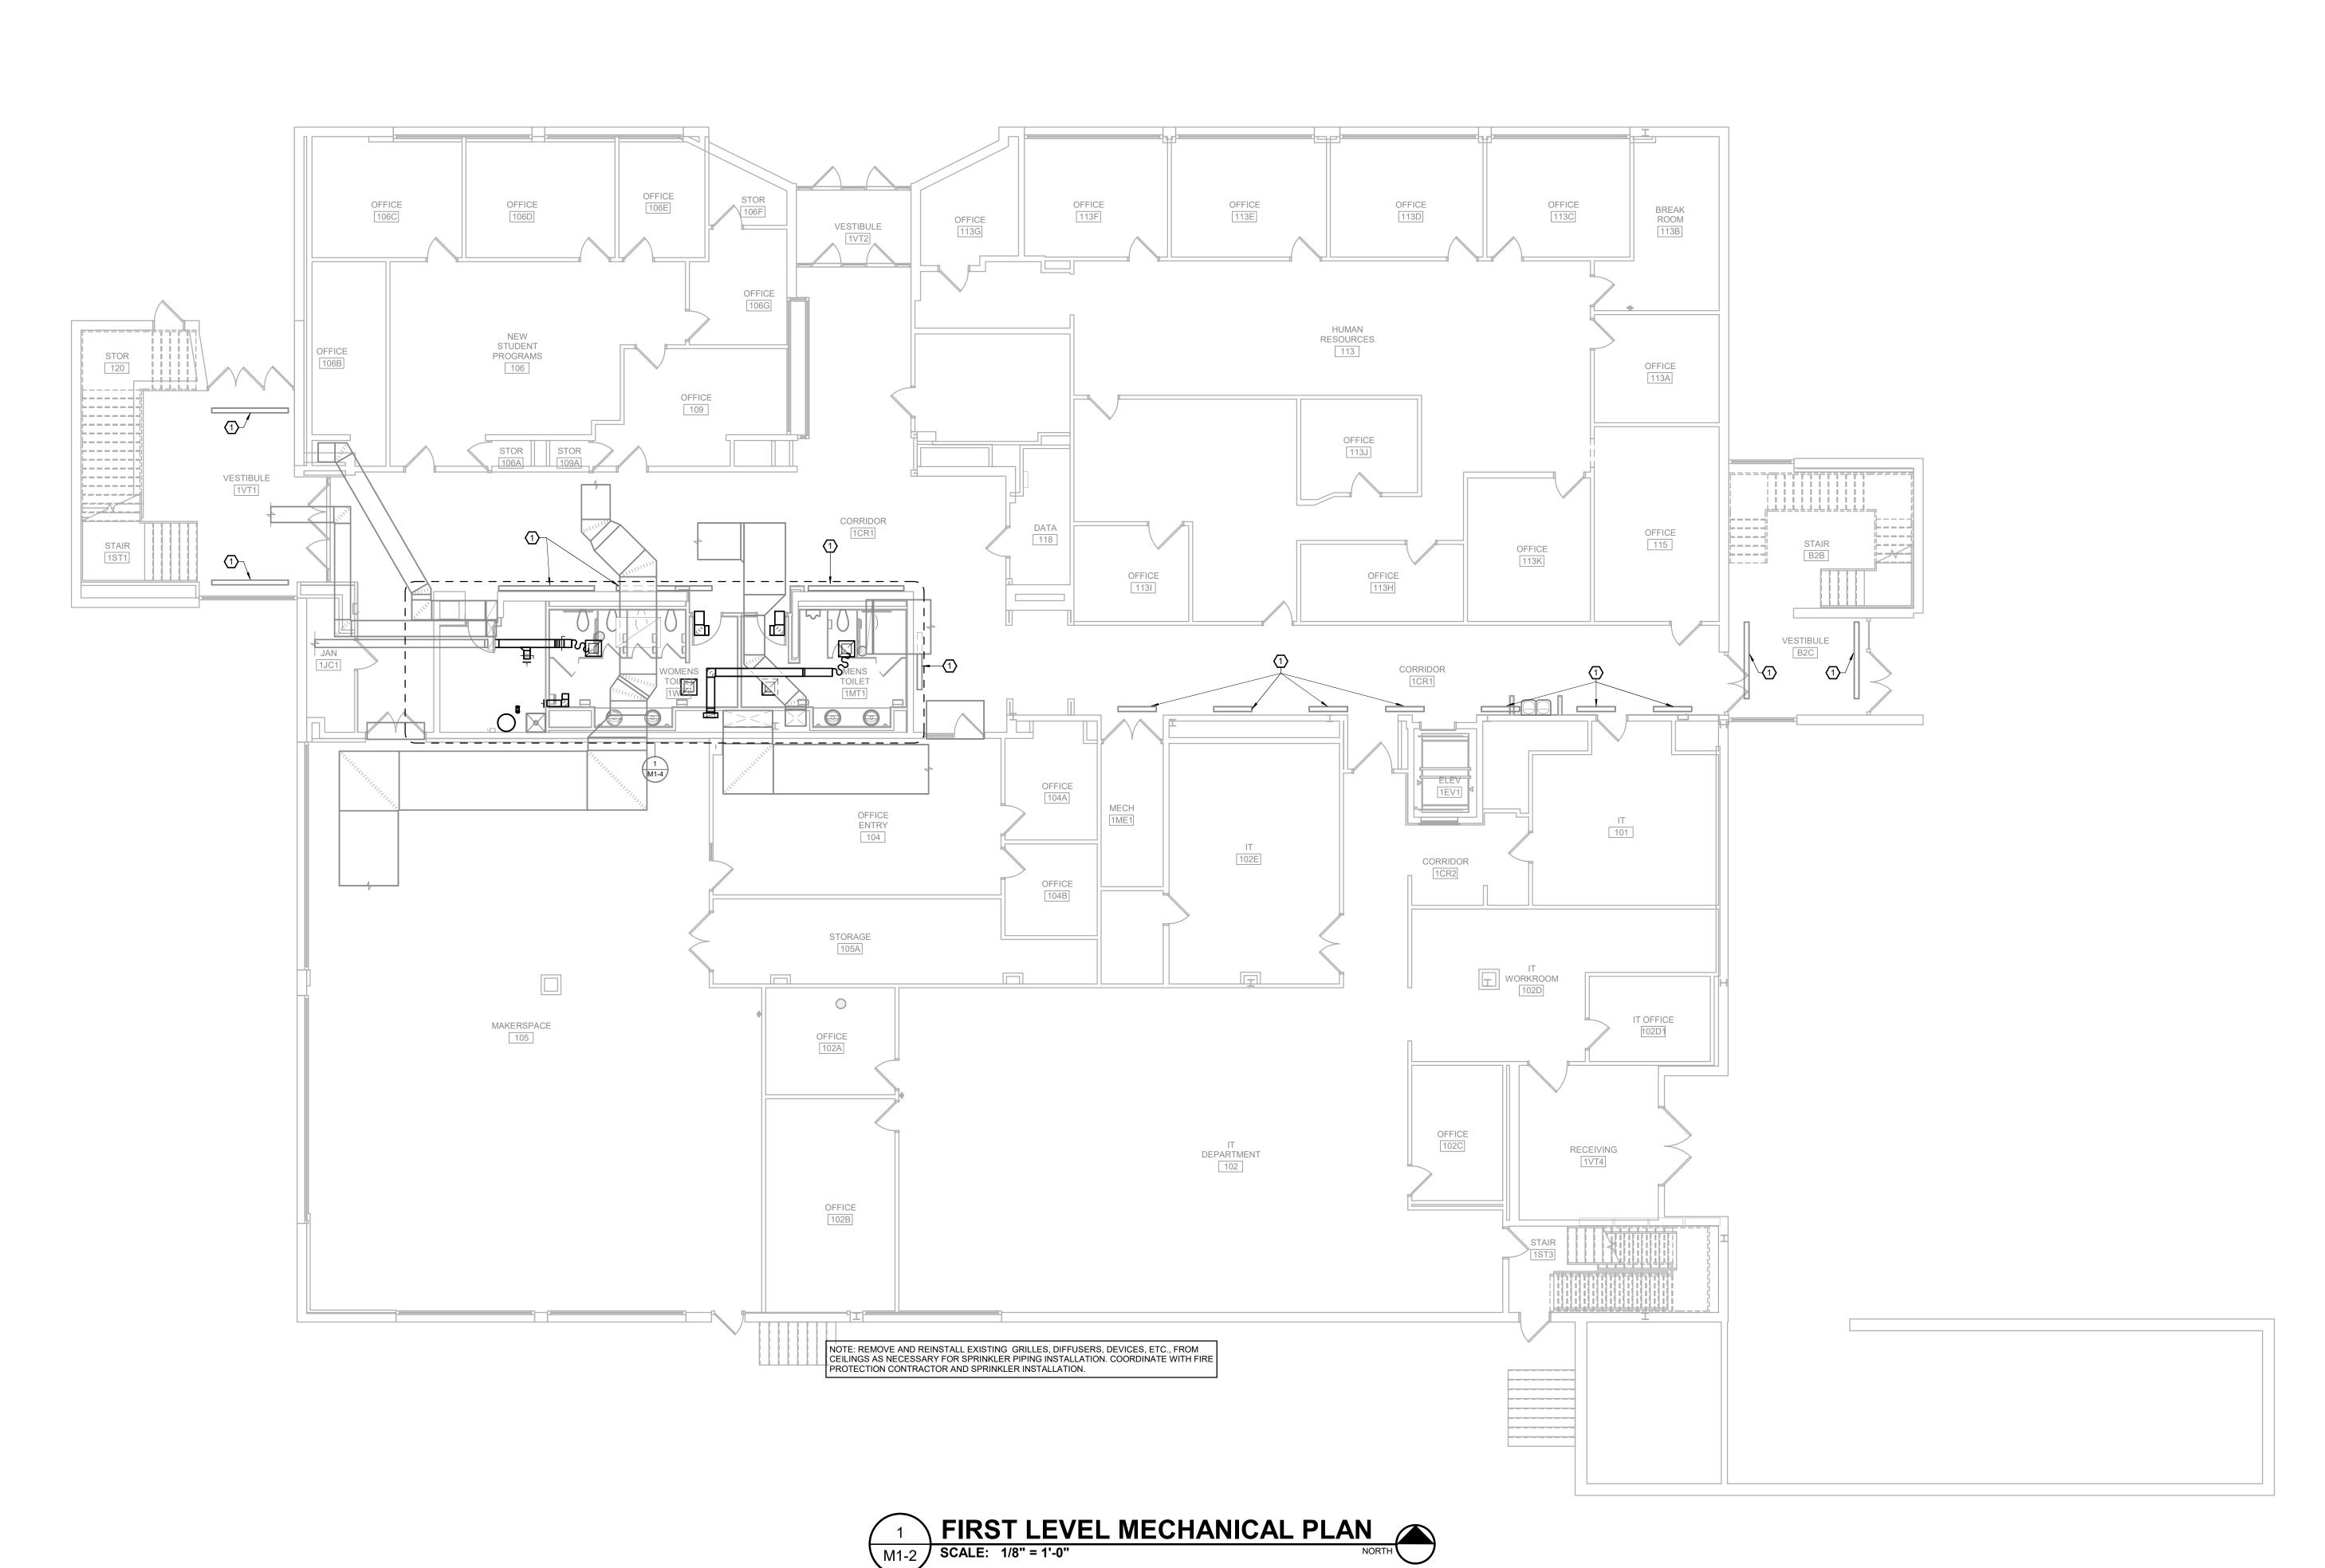


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**GENERAL NOTES:** 

REFER TO SHEET M2-1 FOR GENERAL NOTES.

**PLAN HEX NOTES:** 

1 EXISTING LINEAR DIFFUSER/GRILLE IN CEILING TO BE REMOVED AND REPLACED IN COORDINATION WITH CEILING AND FIRE PROTECTION WORK.

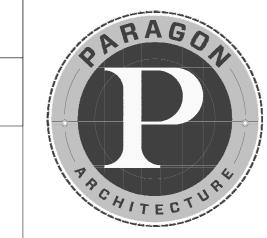

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CENTENNIAL HALL IMPROVEMENTS AND RENOVATION

PROJECT ENGINEER: Approver DRAWN BY: CHECKED BY:


PROJECT NUMBER: 22-703A RC000638

8.28.2023

SECOND LEVEL MECHANICAL PLAN

SHEET NUMBER:


M1-3

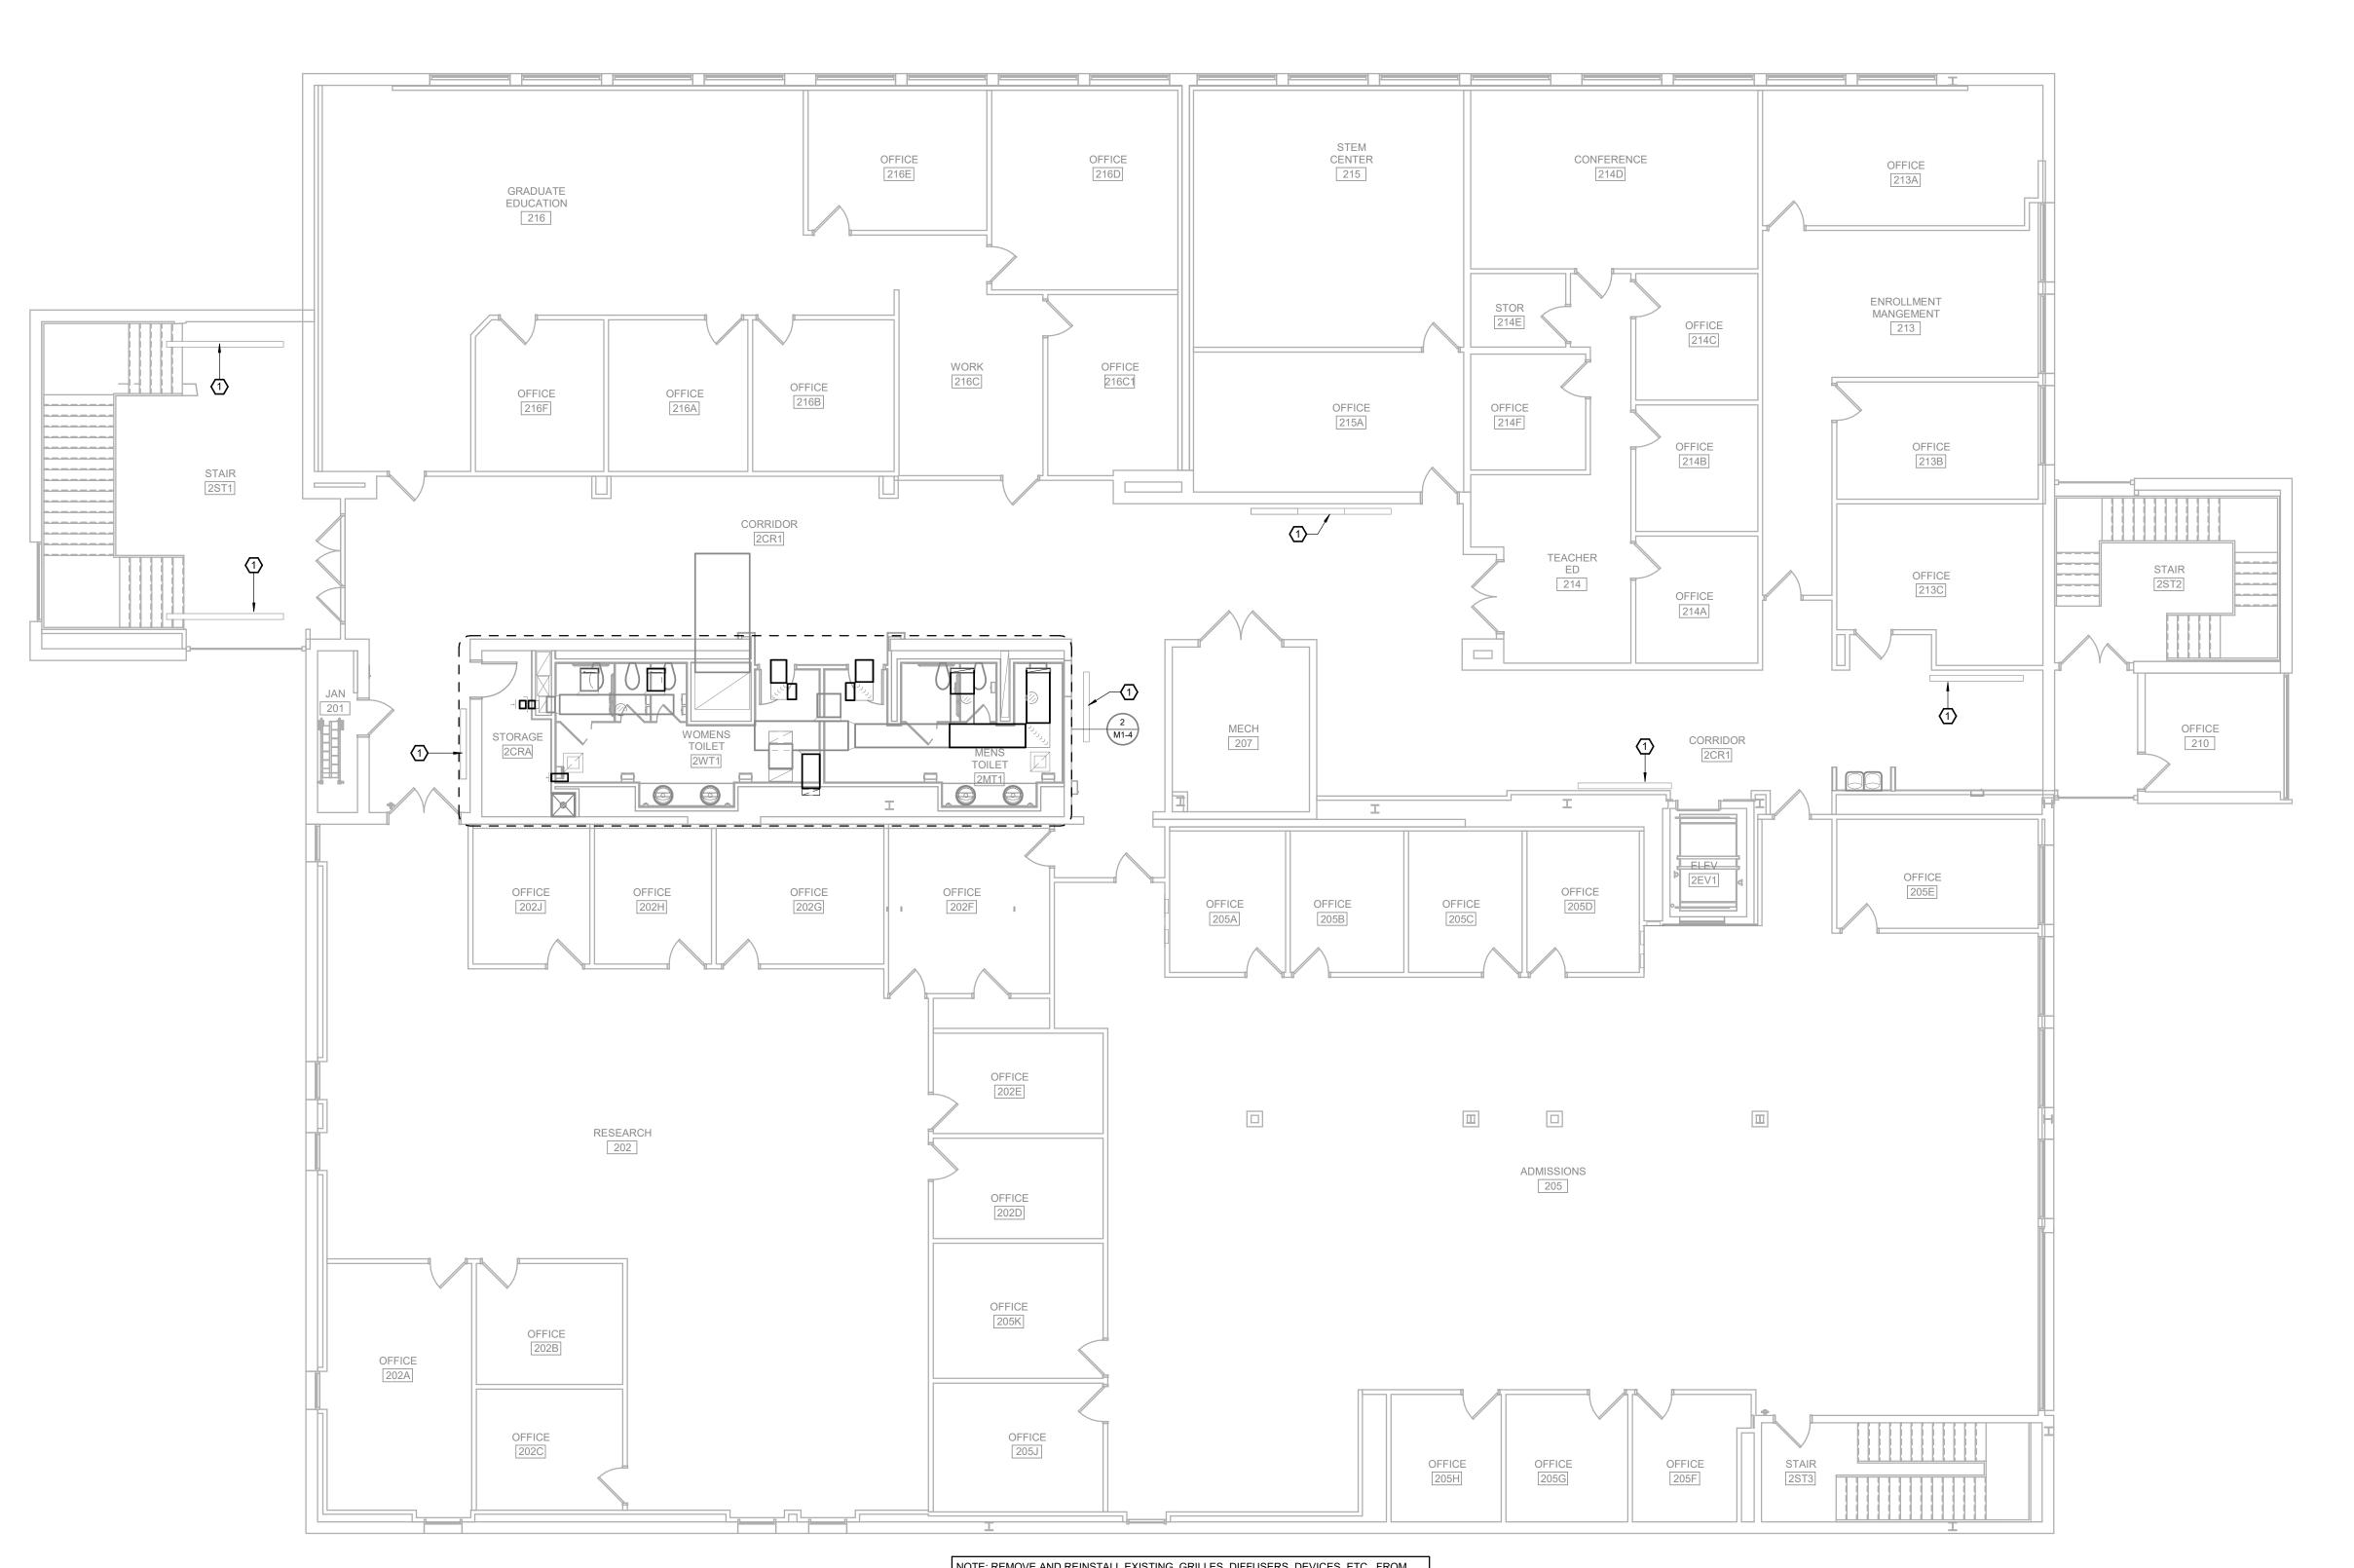

NOTE: REMOVE AND REINSTALL EXISTING GRILLES, DIFFUSERS, DEVICES, ETC., FROM CEILINGS AS NECESSARY FOR SPRINKLER PIPING INSTALLATION. COORDINATE WITH FIRE PROTECTION CONTRACTOR AND SPRINKLER INSTALLATION.

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SECOND LEVEL MECHANICAL PLAN
SCALE: 1/8" = 1'-0"
NORTH

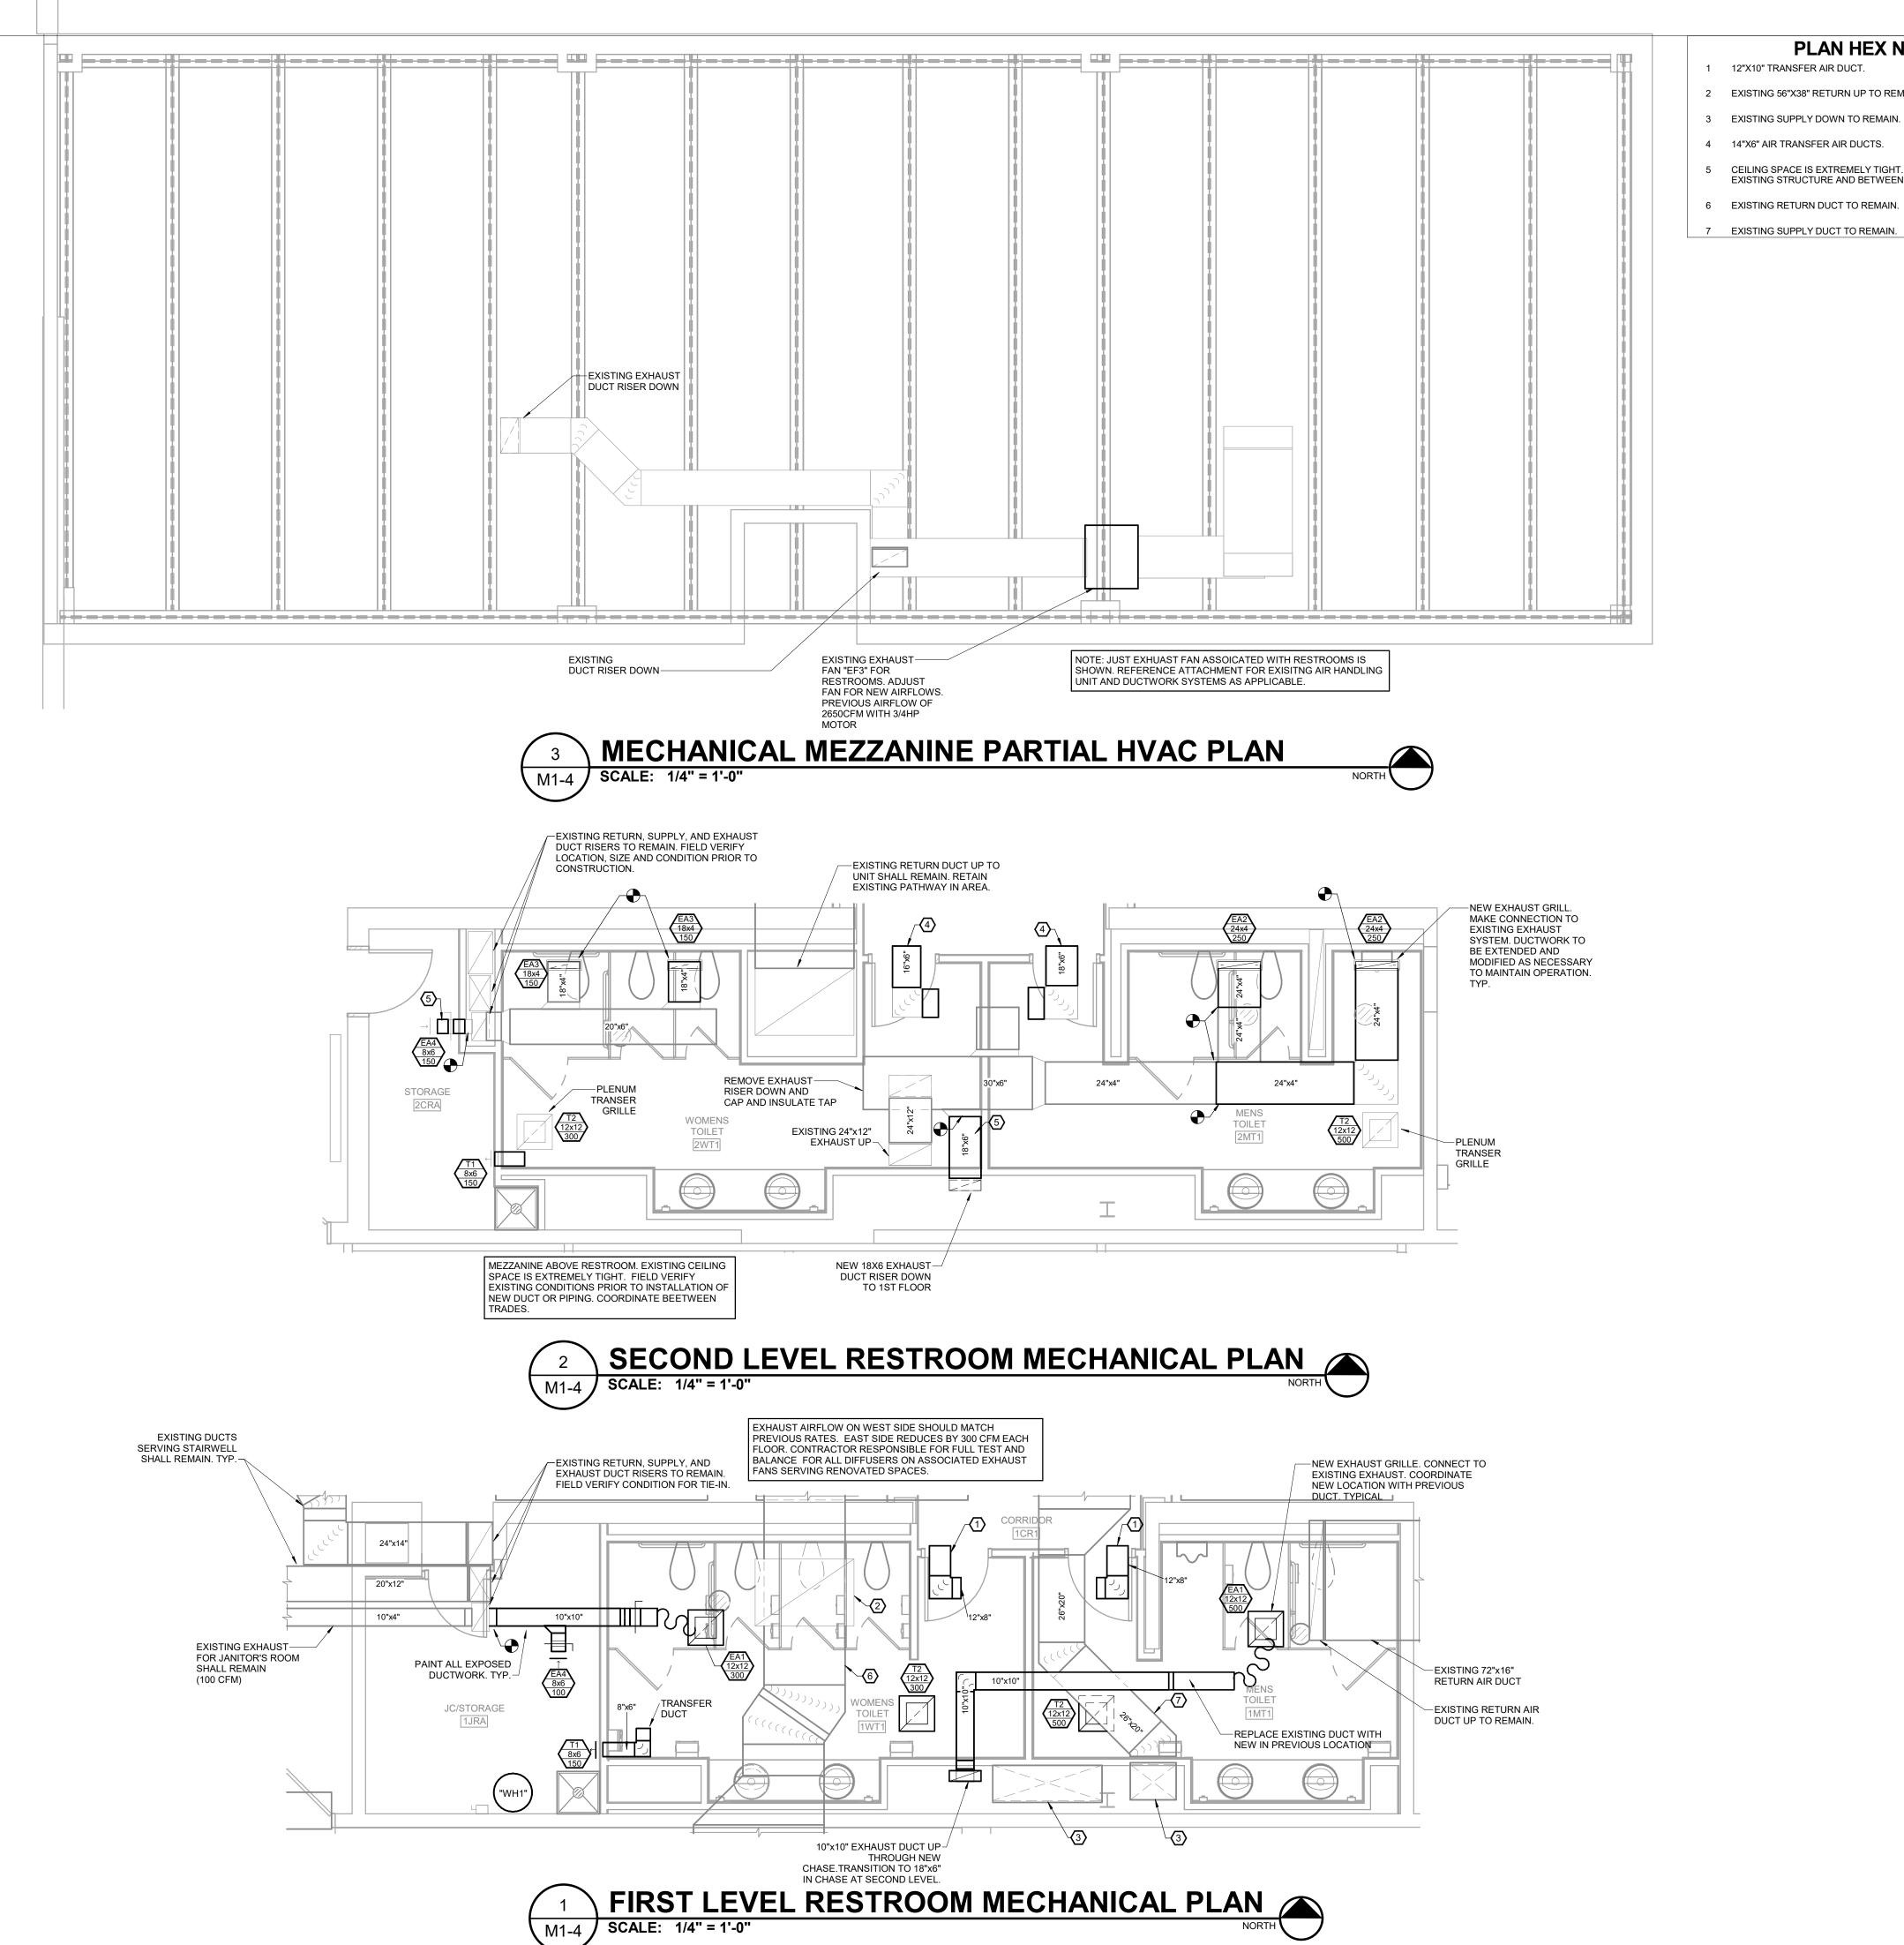

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**PLAN HEX NOTES:** 

- 2 EXISTING 56"X38" RETURN UP TO REMAIN.
- 4 14"X6" AIR TRANSFER AIR DUCTS.
- 5 CEILING SPACE IS EXTREMELY TIGHT. COORDINATE DUCT WITH EXISTING STRUCTURE AND BETWEEN LIGHTS.
- 6 EXISTING RETURN DUCT TO REMAIN.
- 7 EXISTING SUPPLY DUCT TO REMAIN.



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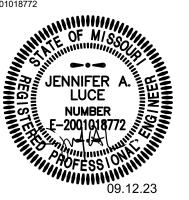
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STATE OF MISSOURI

CERTIFICATE OF AUTHORITY: #2014035826 FOR ENGINEERING

JENNIFER A. LUCE E-2001018772



REVISION SCHEDULE

ENTENNIAL HALL IMPROVEMENT ND RENOVATION

PROJECT ENGINEER: Approver DRAWN BY: CHECKED BY:

PROJECT NUMBER: 22-703A RC000638

8.28.2023

**ENLARGED** MECHANICAL PLAN

SHEET NUMBER:


M1-4

GR	ILLE, F	REGIS	STER	AND	) DIF	FUS	SER	SCH	EDU	LE	
PLAN MARK	MANUFACTURER	MODEL	APPLICATION	FINISH	FRAME TYPE	VOLUME DAMPER	MAXIMUM NC	MINIMUM THROW (FT)	MAXIMUM THROW (FT)	MAXIMUM ΔP (IN WG)	NOTES
EA1	TITUS	50R-24 x 24	EXHAUST	WHITE	GRID	No	30	0	0	0.10	24X24 SQUARE EGGCRATE FACE WITH PLENUM FOR DUCT CONNECTION
EA2	TITUS	MLR-39	EXHAUST	WHITE	GRID	No	30	0	0	0.10	24" LINEAR SLOT DIFFUSER W/ 3-2" SLOT & INSULATED PLENUM BOX
EA3	TITUS	MLR-39	EXHAUST	WHITE	GRID	No	30	0	0	0.10	18" LINEAR SLOT DIFFUSER W/ 3-2" SLOT & INSULATED PLENUM BOX
EA4	TITUS	351-RL	EXHAUST	WHITE	FLANGE	No	30	0	0	0.10	WALL GRILLE - SINGLE DEFLECTION - STEEL - BLADES PARALLEL TO LONG DIMENSION
SA124	TITUS	CT-480	SUPPLY	(Color)	SURFACE	No	30	12	25	0.10	48" CONTINUOUS FLOWBAR LINEAR SLOT DIFFUSER W/ 2" SLOT & INSULATED PLENUM BOX
SA124	TITUS	CT-480	SUPPLY	(Color)	SURFACE	No	30	12	25	0.10	48" CONTINUOUS FLOWBAR LINEAR SLOT DIFFUSER W/ 2" SLOT & INSULATED PLENUM BOX
T1	TITUS	301-FL	SUPPLY	WHITE	SURFACE	No	30	0	0		WALL GRILLE - SINGLE DEFLECTION - STEEL - BLADES PARALLEL TO LONG DIMENSION
FA	N COIL	5 RP X P	T SCI	IEDL	GFID	No	30	0	0	0.10	24X24 SQUARE EGGCRATE FACE WITH PLENUM FOR DUCT CONNECTION
							6001	NC DATA		-	TECTRICAL DATA
PLAN			AIR FLOW	FAN MOTOR E	ST. ESP	TOTAL CAPA		NG DATA LOW E.W.	T. COIL WPD		ELECTRICAL DATA

PLAN	MANUEACTURER	MODEL	AIR FLOW	MOTOR	EST. ESP	TOTAL CAPACITY	FLOW	E.W.T.	COIL WPD	VOL TA OF	DUAGE	1404	MOOD (A)	NOTES
MARK	MANUFACTURER	MODEL	(CFM)	(HP)	(IN WG)	(BTU/H)	(GPM)	(°F)	(FT)	VOLTAGE	PHASE	MCA	MOCP (A)	NOTES
FCUW1	IEC	CXB06	500	0.10	0.2	13,000	2.9	46	2.3	120	1	2	15	BS,BR,F,DM,DDC,2W,DP
ABBREVIA	TIONS													

- BS BUTTOM SUPPLY GRILLE
- BR BACK RETURN
  F FILTER WITH BOTTOM ACCESS
- DM DISCONNECT MEANS
  DDC DDC BACNET CONTROLLER AND THERMOSTAT
- V 2-WAY CONTROL VALVE
- 2-WAY CONTROL VALVE
  DRAIN PAN WITH FLOAT SWITCH
- LITTLE GIANT CONDENSATE PUMP EQUAL TO EC-1-DV (120V)

PIPE MATERIAL SCH	<del>I</del> EDU	LE										
			PIPING				FITT	INGS	MAX. V	VORKING	FIELD	TEST
									PRESS.	TEMP.	PRESS.	
SYSTEM	SIZE	TYPE	SCHEDULE	GRD	ASTM	MATERIAL	MATERIAL	TYPE	(PSI)	(°F)	(PSI)	TIME
CONDENSATE DRAIN ABOVE GRADE	ALL	M	-	-	B88	CP	CP	DR\S	10 FT	40-70	10 FT	1 HR
CHILLED WATER SUPPLY & RETURN	0.5" - 3"	L	-	_	B88	CP	CP	CJ	125	5-804	150	1 HR

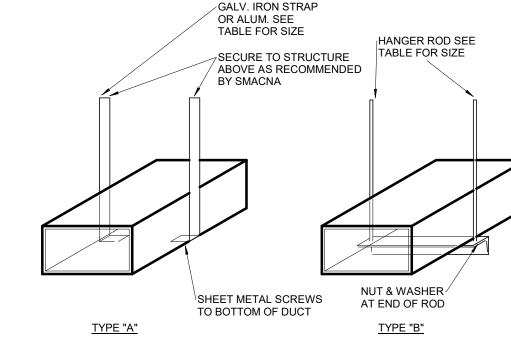

١			DUCT	HANGER SCHI	EDULE	
ł						
	DUCT SIZE (INCH)	TYPE OF HANGER	HANGER SPACING (FT)	STRAP SIZE	ROD SIZE (INCH)	ANGLE FOR BRACING
	UP TO 12 13 TO 18 19 TO 30 31 TO 42 43 TO 54 55 TO 60 61 TO 84 85 TO 96 OVER 96	A A A/B B B B B B	8'-0" 8'-0" 8'-0" 8'-0" 8'-0" 8'-0" 8'-0"	1"x16GA 1"x16GA 1"x16GA N.A. N.A. N.A. N.A.	N.A. N.A. 1/4" 1/4" 1/4" 1/4" 1/4" 3/8"	N.A. N.A. 1-1/2"x1-1/2"x1/8" 1-1/2"x1-1/2"x1/8" 1-1/2"x1-1/2"x1/8" 1-1/2"x1-1/2"x3/16" 1-1/2"x1-1/2"x3/16" 2"x2"x1/4"

NOTES:


1. FOR SEVERAL DUCTS ON ONE HANGER, TYPE "B" MAY BE USED. SIZE OF HANGER WILL BE SELECTED ON THE SUM OF DUCT WIDTHS EQUAL TO MAX WIDTH OF DUCT SCHEDULE.


2. ON TYPE "A" HANGER, PROVIDE 3 HANGERS AT EACH TAKE-OFF OR BRANCH.



# **DUCT SUPPORT DETAIL**

SCALE: NOT TO SCALE

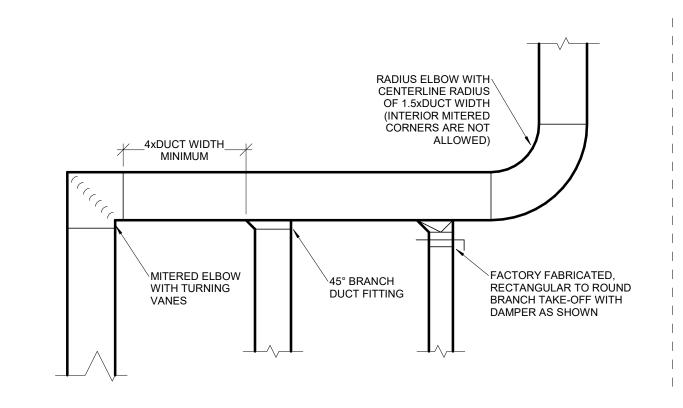


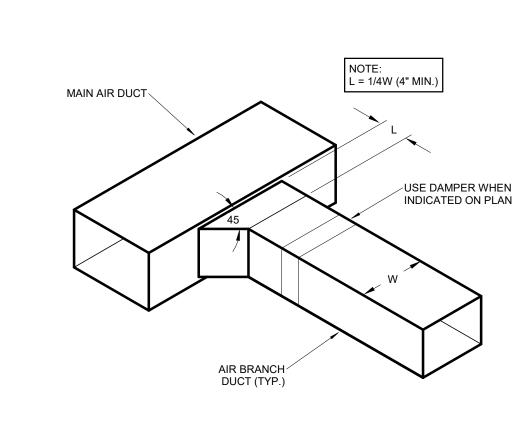

# 2 DI SCA

# **DUCTWORK CONSTRUCTION DETAIL**


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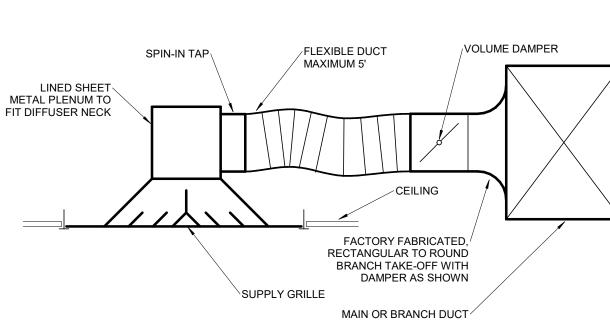


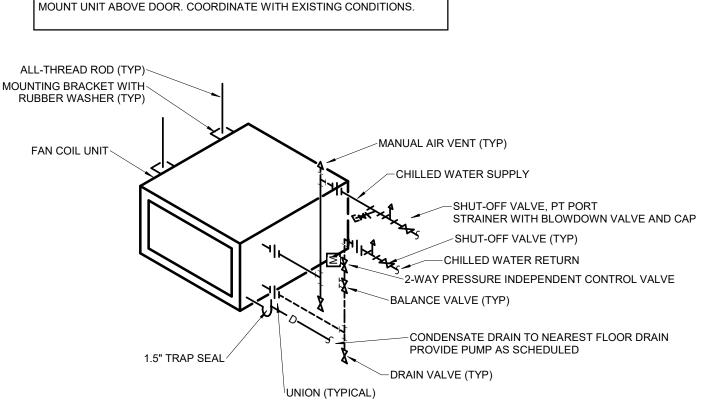

PROVIDE CONDENSATE PUMP AND INSTALL CONDENSATE PIPING PER EQUIPMENT MANUFACTURER'S RECOMMENDATIONS. REFER TO MANUFACTURER'S LISTED CONDENSATE PUMP LIFT CAPABILITIES AND INSTALL THE CONDENSATE PIPING AS HIGH AS POSSIBLE AND WITHIN THE

LIMITS GIVEN BY THE MANUFACTURER.



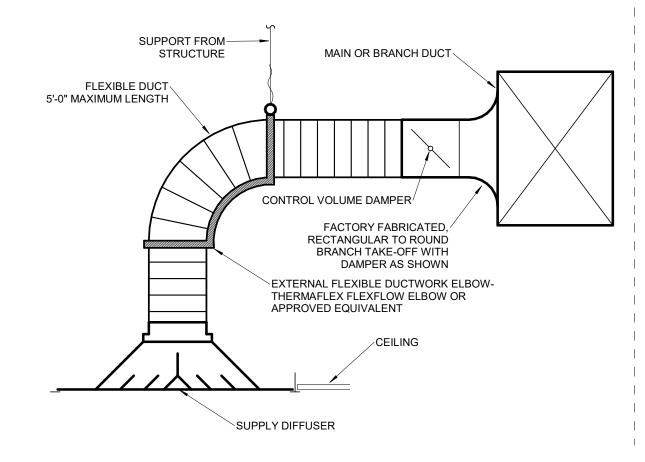

1 CEILING DIFFUSER DETAIL

M2-1 SCALE: NOT TO SCALE

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### **GENERAL NOTES:**

- A. ALL MECHANICAL WORK SHALL BE IN ACCORDANCE WITH THE REQUIREMENTS OF THE 2021 INTERNATIONAL MECHANICAL CODE AS ADOPTED BY MISSOURI UNIVERSITY OF SCIENCE & TECHNOLOGY.
- B. FOR ALL MECHANICAL QUESTIONS ON THIS PROJECT, CONTACT RTM ENGINEERING CONSULTANTS AT (417) 881-0020. CONTACT: LARRY NEUHAUS.
- FINAL ACCEPTANCE OF WORK SHALL BE SUBJECT TO THE CONDITION THAT ALL SYSTEMS, EQUIPMENT, APPARATUS, AND APPLIANCES OPERATE SATISFACTORILY AS DESIGNED AND INTENDED; WORK SHALL INCLUDE REQUIRED REPLACEMENT, ADJUSTMENT OF SYSTEMS AND CONTROL EQUIPMENT AND ALL REQUIRED PROGRAMMING INSTALLED. PROVIDE FOR ALL WORK INDICATED ON DRAWINGS OR AS REASONABLY IMPLIED.
- TEST ALL LINES, SYSTEMS, EQUIPMENT BEFORE THEY ARE INSULATED, PAINTED, OR CONCEALED BY CONSTRUCTION OR BACKFILLING. PROVIDE FUEL, WATER, ELECTRICITY, MATERIALS, LABOR, AND EQUIPMENT REQUIRED FOR TESTS. REPAIR OR REPLACE DEFECTS, LEAKS, AND MATERIALS FAILURES REVEALED BY TESTS AND THEN RETESTED UNTIL SATISFACTORY. MAKE REPAIRS WITH NEW MATERIALS.
- PROVIDE NECESSARY MATERIALS AND ACCESSORIES FOR INSTALLATION OF FIXTURES, EQUIPMENT, ETC AS REQUIRED FOR COMPLETE AND FUNCTIONAL OPERATION AS NOTED ON DRAWINGS OR IN NOTES.
- ACCESS PANELS SHALL BE PROVIDED WHEREVER
  NECESSARY TO PROVIDE ACCESS TO VALVES, JUNCTION
  BOXES, ETC., LOCATED IN CONCEALED SPACES. PROVIDE
  ACCESS DOOR FOR ALL FIRE DAMPERS AS REQUIRED
- ALL EQUIPMENT, FIXTURES, MATERIALS, ETC SHALL BE INSTALLED IN NEAT, PROFESSIONAL MANNER IN ACCORDANCE WITH MANUFACTURER
- RECOMMENDATIONS.

  PROVIDE ALL FIRE RATED MATERIAL FOR PATCH AND REPAIR FOR ALL FIRE RATED ASSEMBLIES. ALL OPENINGS SHALL BE SEALED AND CLOSED IN APPROVED MANNER. PROVIDE SLEEVE WHERE NEEDED DUE TO
- SCOPE OF WORK.

  EXISTING CONDITIONS ON THIS SET OF BID DOCUMENTS
  WERE TAKEN FROM EXISTING DRAWINGS, LIMITED SITE
  VISITS, AND VISUAL OBSERVATIONS. FIELD VERIFY ALL
  EXISTING CONDITIONS PRIOR TO SUBMITTING FINAL BIDS.
  CHANGE ORDERS WILL NOT BE PAID DUE TO
- CONTRACTOR SHALL SCHEDULE AND EXECUTE ALL WORK WITH REGARD TO THE OWNER'S USE OF THE BUILDING.

UNANTICIPATED CONDITIONS TO MEET INTENT OF WORK.

PLANS ARE DIAGRAMMATIC AND SHALL NOT BE SCALED.
REFER TO ARCHITECTURAL DRAWINGS FOR DIMENSIONS.

NECK UNLESS NOTED OTHERWISE.

PROVIDE TURNING VANES IN ALL RECTANGULAR MITERED ELBOWS.

BRANCH DUCTS SHALL BE THE SAME SIZE AS DIFFUSER

- N. THERMOSTATS AND CONTROL WIRING SHALL BE SUPPLIED BY THE HVAC CONTRACTOR. THE ELECTRICAL CONTRACTOR SHALL FURNISH AND INSTALL THE NECESSARY CONDUIT, BOXES, ETC. FOR THE INSTALLATION OF THERMOSTATS. THE HVAC CONTRACTOR SHALL BE RESPONSIBLE FOR THE INSTALLATION AND CONNECTION OF THERMOSTATS.
- D. NEW PIPING AND DUCTWORK SHALL NOT BE ROUTED OVER EXISTING AND NEW ELECTRICAL PANELS OR OVER ELEVATOR EQUIPMENT.
- ALL EQUIPMENT SHALL BE INSTALLED TO ALLOW FULL MAINTENANCE ACCESS PER MANUFACTURER'S RECOMMENDATIONS.
- D. PROVIDE BALANCE DAMPER ON ALL SUPPLY, EXHAUST, AND OUTSIDE AIR BRANCH DUCTS TO OUTLETS, WHETHER INDICATED IN PLANS OR NOT.
- R. INSULATE AND SEAL ALL CAPPED DUCTS WHERE NOTED.

  MECHANICAL CONTRACTOR SHALL BE RESPONSIBLE FOR

TRANSITIONS TO ALL EQUIPMENT OPENING SIZES.

- T. MECHANICAL CONTRACTOR SHALL REMOVE AND REPLACE CEILING TILES IN ALL EXISTING AREAS WITH NEW DUCT AND IS RESPONSIBLE FOR REPLACING TILES IF DAMAGED DURING CONSTRUCTION.
- REFER TO ARCHITECTURAL PLANS FOR ANY ADDITIONAL CONSTRUCTION PHASING REQUIREMENTS.
- CONTRACTOR SHALL BE RESPONSIBLE FOR ANY TEMPORARY EQUIPMENT REQUIRED FOR DUST CONTROL AND TEMPORARY EXHAUST. COORDINATE REQUIREMENTS WITH OWNER.

PARAGON

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#2014035826

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JENNIFER A. LUCE E-2001018772

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NUMBER
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JENNIFER A. WESS

NUMBER
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NTENNIAL HALL IMPROVEMENTS
D RENOVATION

PROJECT ENGINEER: Approver DRAWN BY: LDN CHECKED BY: JAL

PROJECT NUMBER: 22-703A RC000638

DATE: 8.28.2023

MECHANICAL DETAILS & SCHEDULES

SHEET NUMBER:

**M2-1** 

### **GENERAL DEMOLITION NOTES:**

REFER TO SHEET E0-4 FOR GENERAL NOTES.

### PLAN HEX NOTES:

- 1 EXISTING CONDUIT WITH FEED FROM EXISTING MDP2 TO EXISTING PANEL "2NLP1B" TO BE REMOVED. FIRE CAULK PENETRATIONS AS REQUIRED. EXISTING WIRING TO BE REROUTED WITH NEW FEEDER OUTSIDE OF THE ELEVATOR
- 2 EXISTING ELEVATOR CONTROLLER SHALL BE REMOVED.
- 3 REMOVE ELEVATOR DISCONNECT. EXTEND AND MODIFY EXISTING FEEDER FOR NEW DISCONNECT AND ADDITION OF GROUND PER IMPROVEMENTS PLANS.
- 4 EXISTING HYDRAULIC UNIT TO BE REMOVED.
- 5 EXISTING FIRE ALARM SYSTEM. NFS-320 NOTIFIER.
- 6 ELEVATOR TO BE FULLY REFURBISHED. ALL ELECTRICAL REQUIREMENTS AND WORK TO BE COORDINATED WITH OWNERS VENDOR. REMOVE POWER AND RECONNECT.


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CENTENNIAL HALL IMPROVEMENTS AND RENOVATION

EXISTING PANEL E

STOR

B3A

STOR

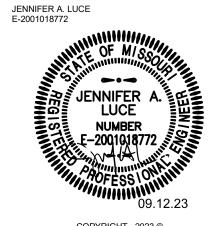B3B

STOR

1 LOWER LEVEL ELECTRICAL DEMO PLAN
E0-1 SCALE: 1/8" = 1'-0"

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LOWER LEVEL ELECTRICAL DEMO PLAN

SHEET NUMBER:

PROJECT NUMBER: 22-703A RC000638

DATE: 8.28.2023

E0-1

### **GENERAL DEMOLITION NOTES:**

REFER TO SHEET E0-4 FOR GENERAL NOTES.

### **PLAN HEX NOTES:**

- 1 EXISTING CONDUIT WITH FEED FROM EXISTING MDP2 TO EXISTING PANEL "2NLP1B" TO BE REMOVED. FIRE CAULK PENETRATIONS AS REQUIRED. EXISTING WIRING TO BE REROUTED WITH NEW FEEDER OUTSIDE OF THE ELEVATOR
- 2 ELEVATOR TO BE FULLY REFURBISHED. ALL ELECTRICAL REQUIREMENTS AND WORK TO BE COORDINATED WITH OWNERS VENDOR. REMOVE POWER AND RECONNECT.
- 3 EXISTING PANEL B. FIELD VERIFY EXISTING CIRCUITS IN PANEL PRIOR TO CONSTRUCTION. PROVIDE UPDATED TYPED LABELS AND SCHEDULE FOR PANELBOARD.



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PROJECT ENGINEER: Approver DRAWN BY:


PROJECT NUMBER: 22-703A RC000638

8.28.2023

FIRST LEVEL ELECTRICAL DEMO PLAN

SHEET NUMBER:

**E0-2** 

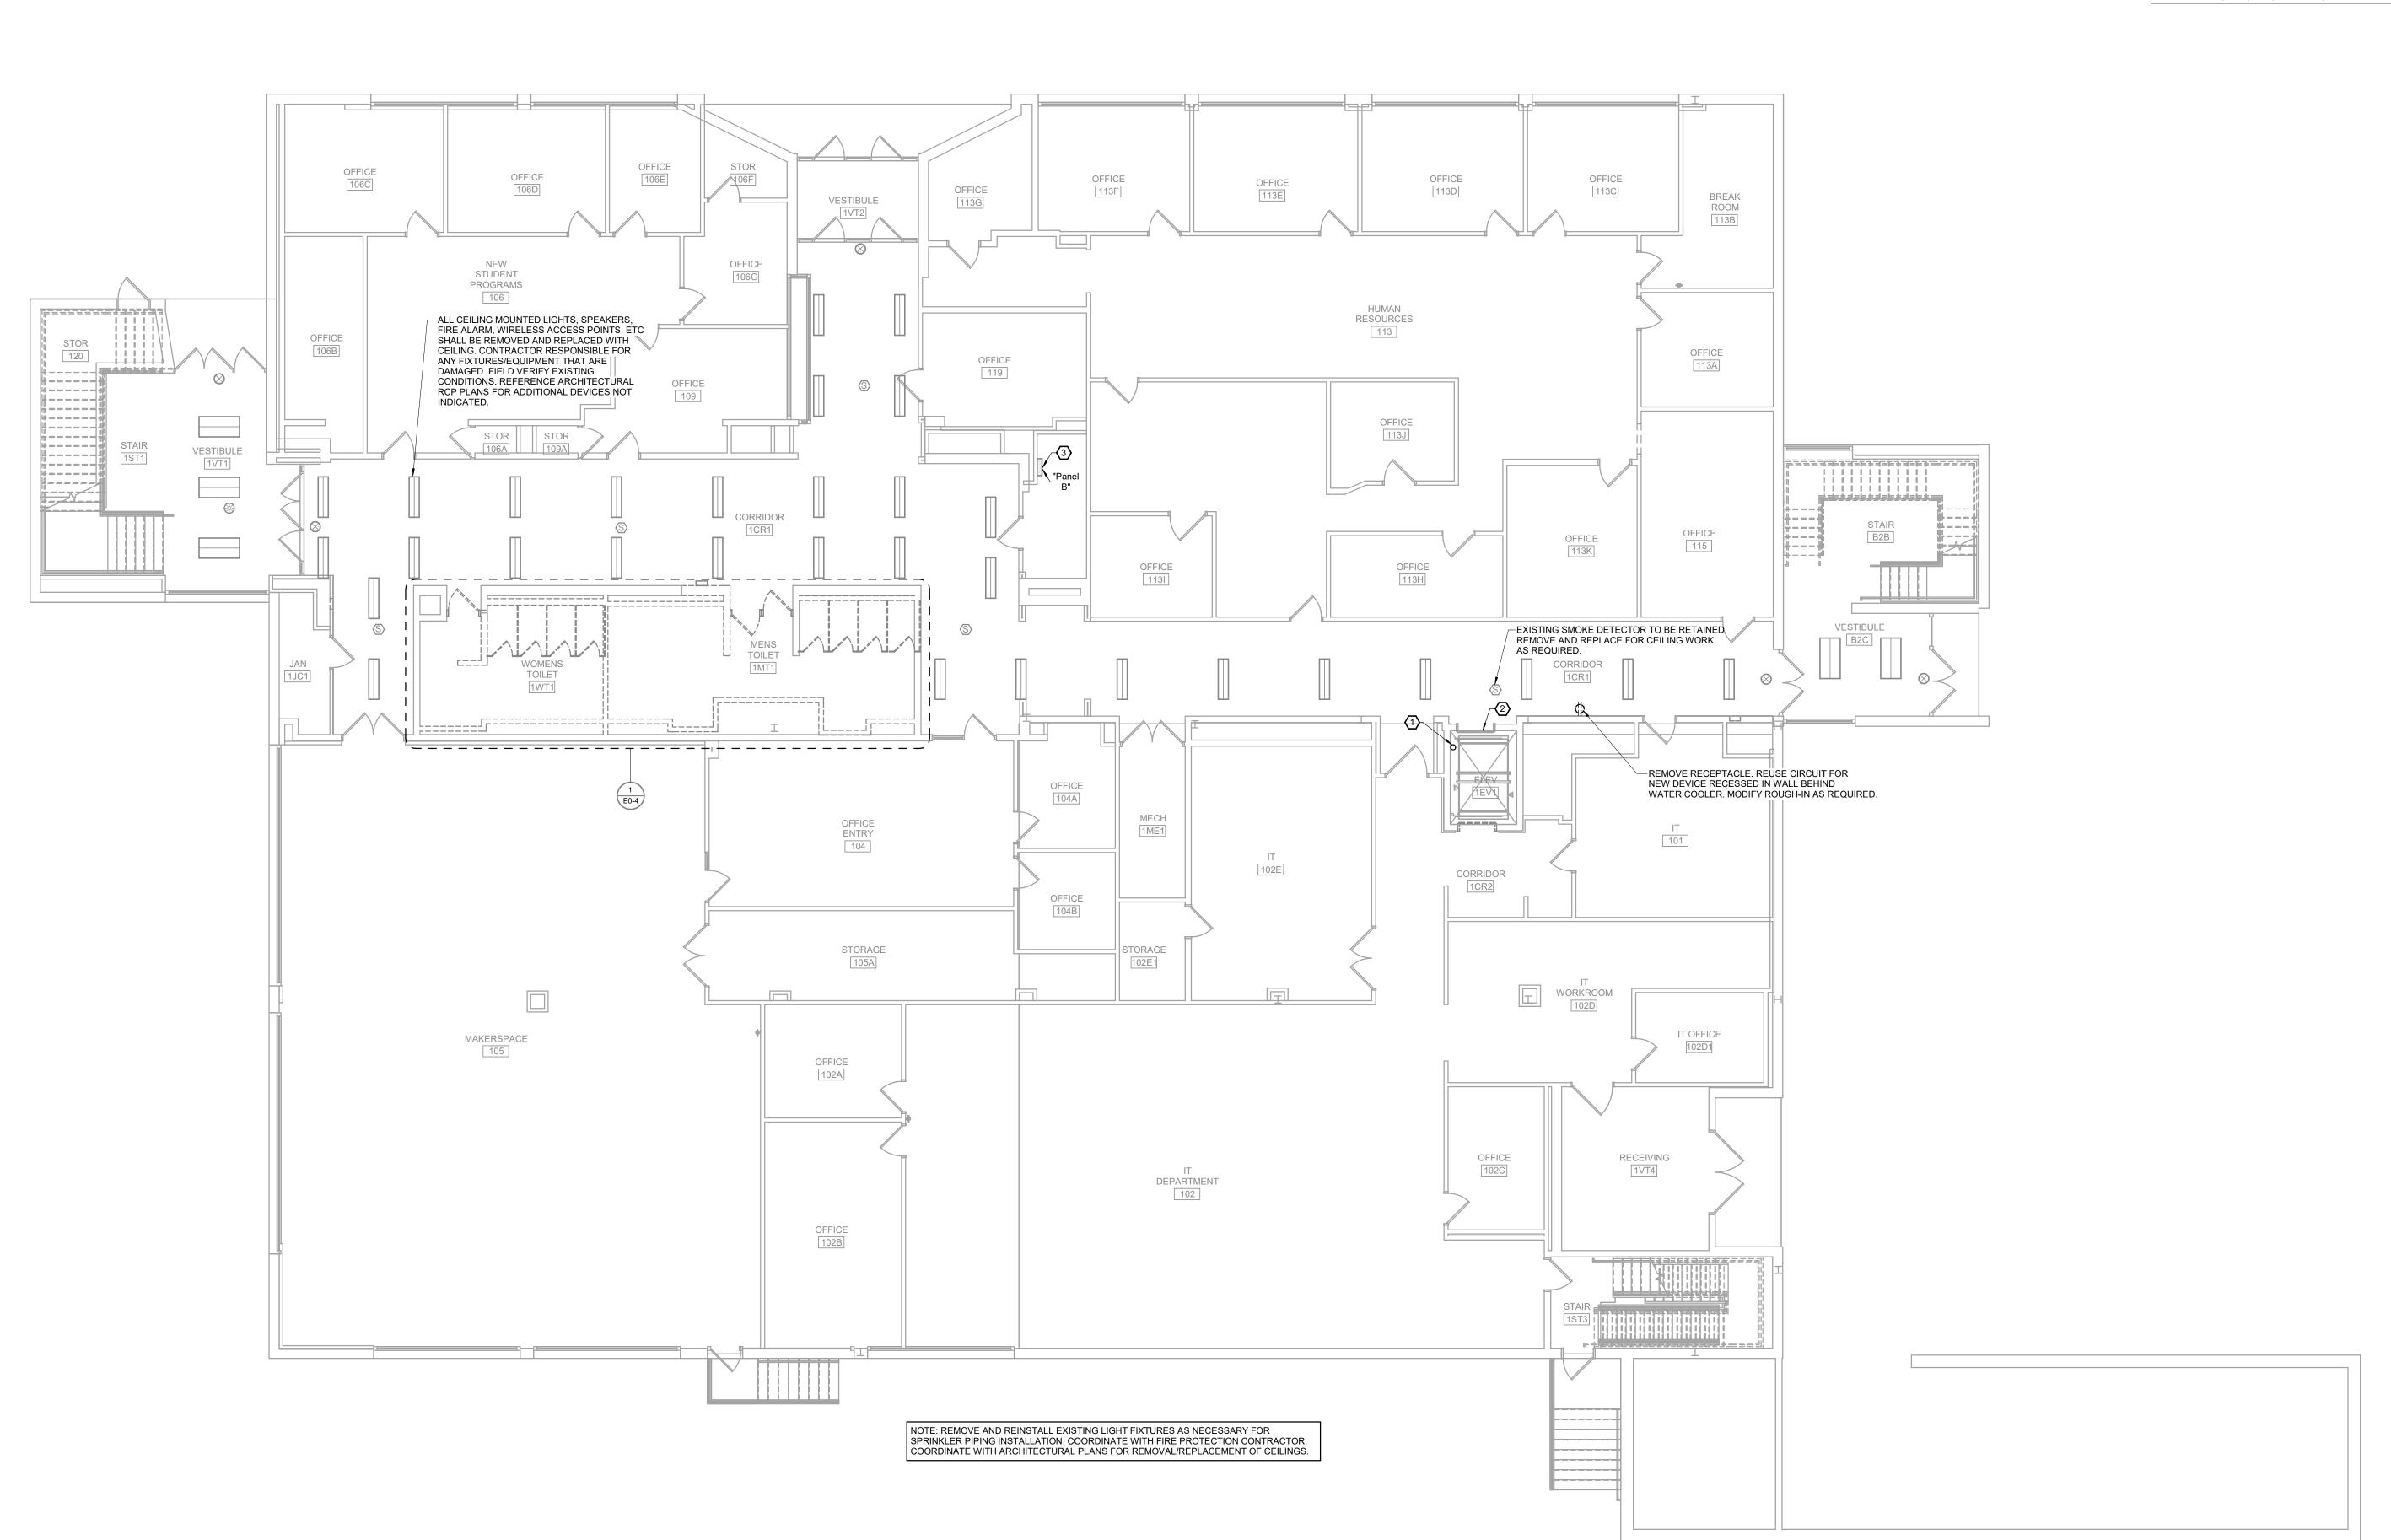

1 FIRST LEVEL ELECTRICAL DEMO PLAN SCALE: 1/8" = 1'-0"

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REFER TO SHEET E0-4 FOR GENERAL NOTES.

### **PLAN HEX NOTES:**

- 1 REMOVE EXISTING 1X4 LIGHT FIXTURES FROM CORRIDOR GRID CEILING. MAINTAIN WIRING AND CONDUIT WHERE POSSIBLE TO BE REUSED FOR INSTALLATION OF NEW 2X4 FIXTURES.
- 2 REMOVE EXISTING CAN DOWN LIGHT FIXTURES FROM CORRIDOR WOOD SLAT CEILING. MAINTAIN WIRING AND CONDUIT WHERE POSSIBLE TO BE REUSED FOR INSTALLATION OF NEW 2X4 FIXTURES.
- 3 ELEVATOR TO BE FULLY REFURBISHED. ALL ELECTRICAL REQUIREMENTS AND WORK TO BE COORDINATED WITH OWNERS VENDOR. REMOVE POWER AND RECONNECT.
- 4 EXISTING CONDUIT WITH FEED FROM EXISTING MDP2 TO EXISTING PANEL "2NLP1B" TO BE REMOVED. FIRE CAULK PENETRATIONS AS REQUIRED. EXISTING WIRING TO BE REROUTED WITH NEW FEEDER OUTSIDE OF THE ELEVATOR SHAFT.






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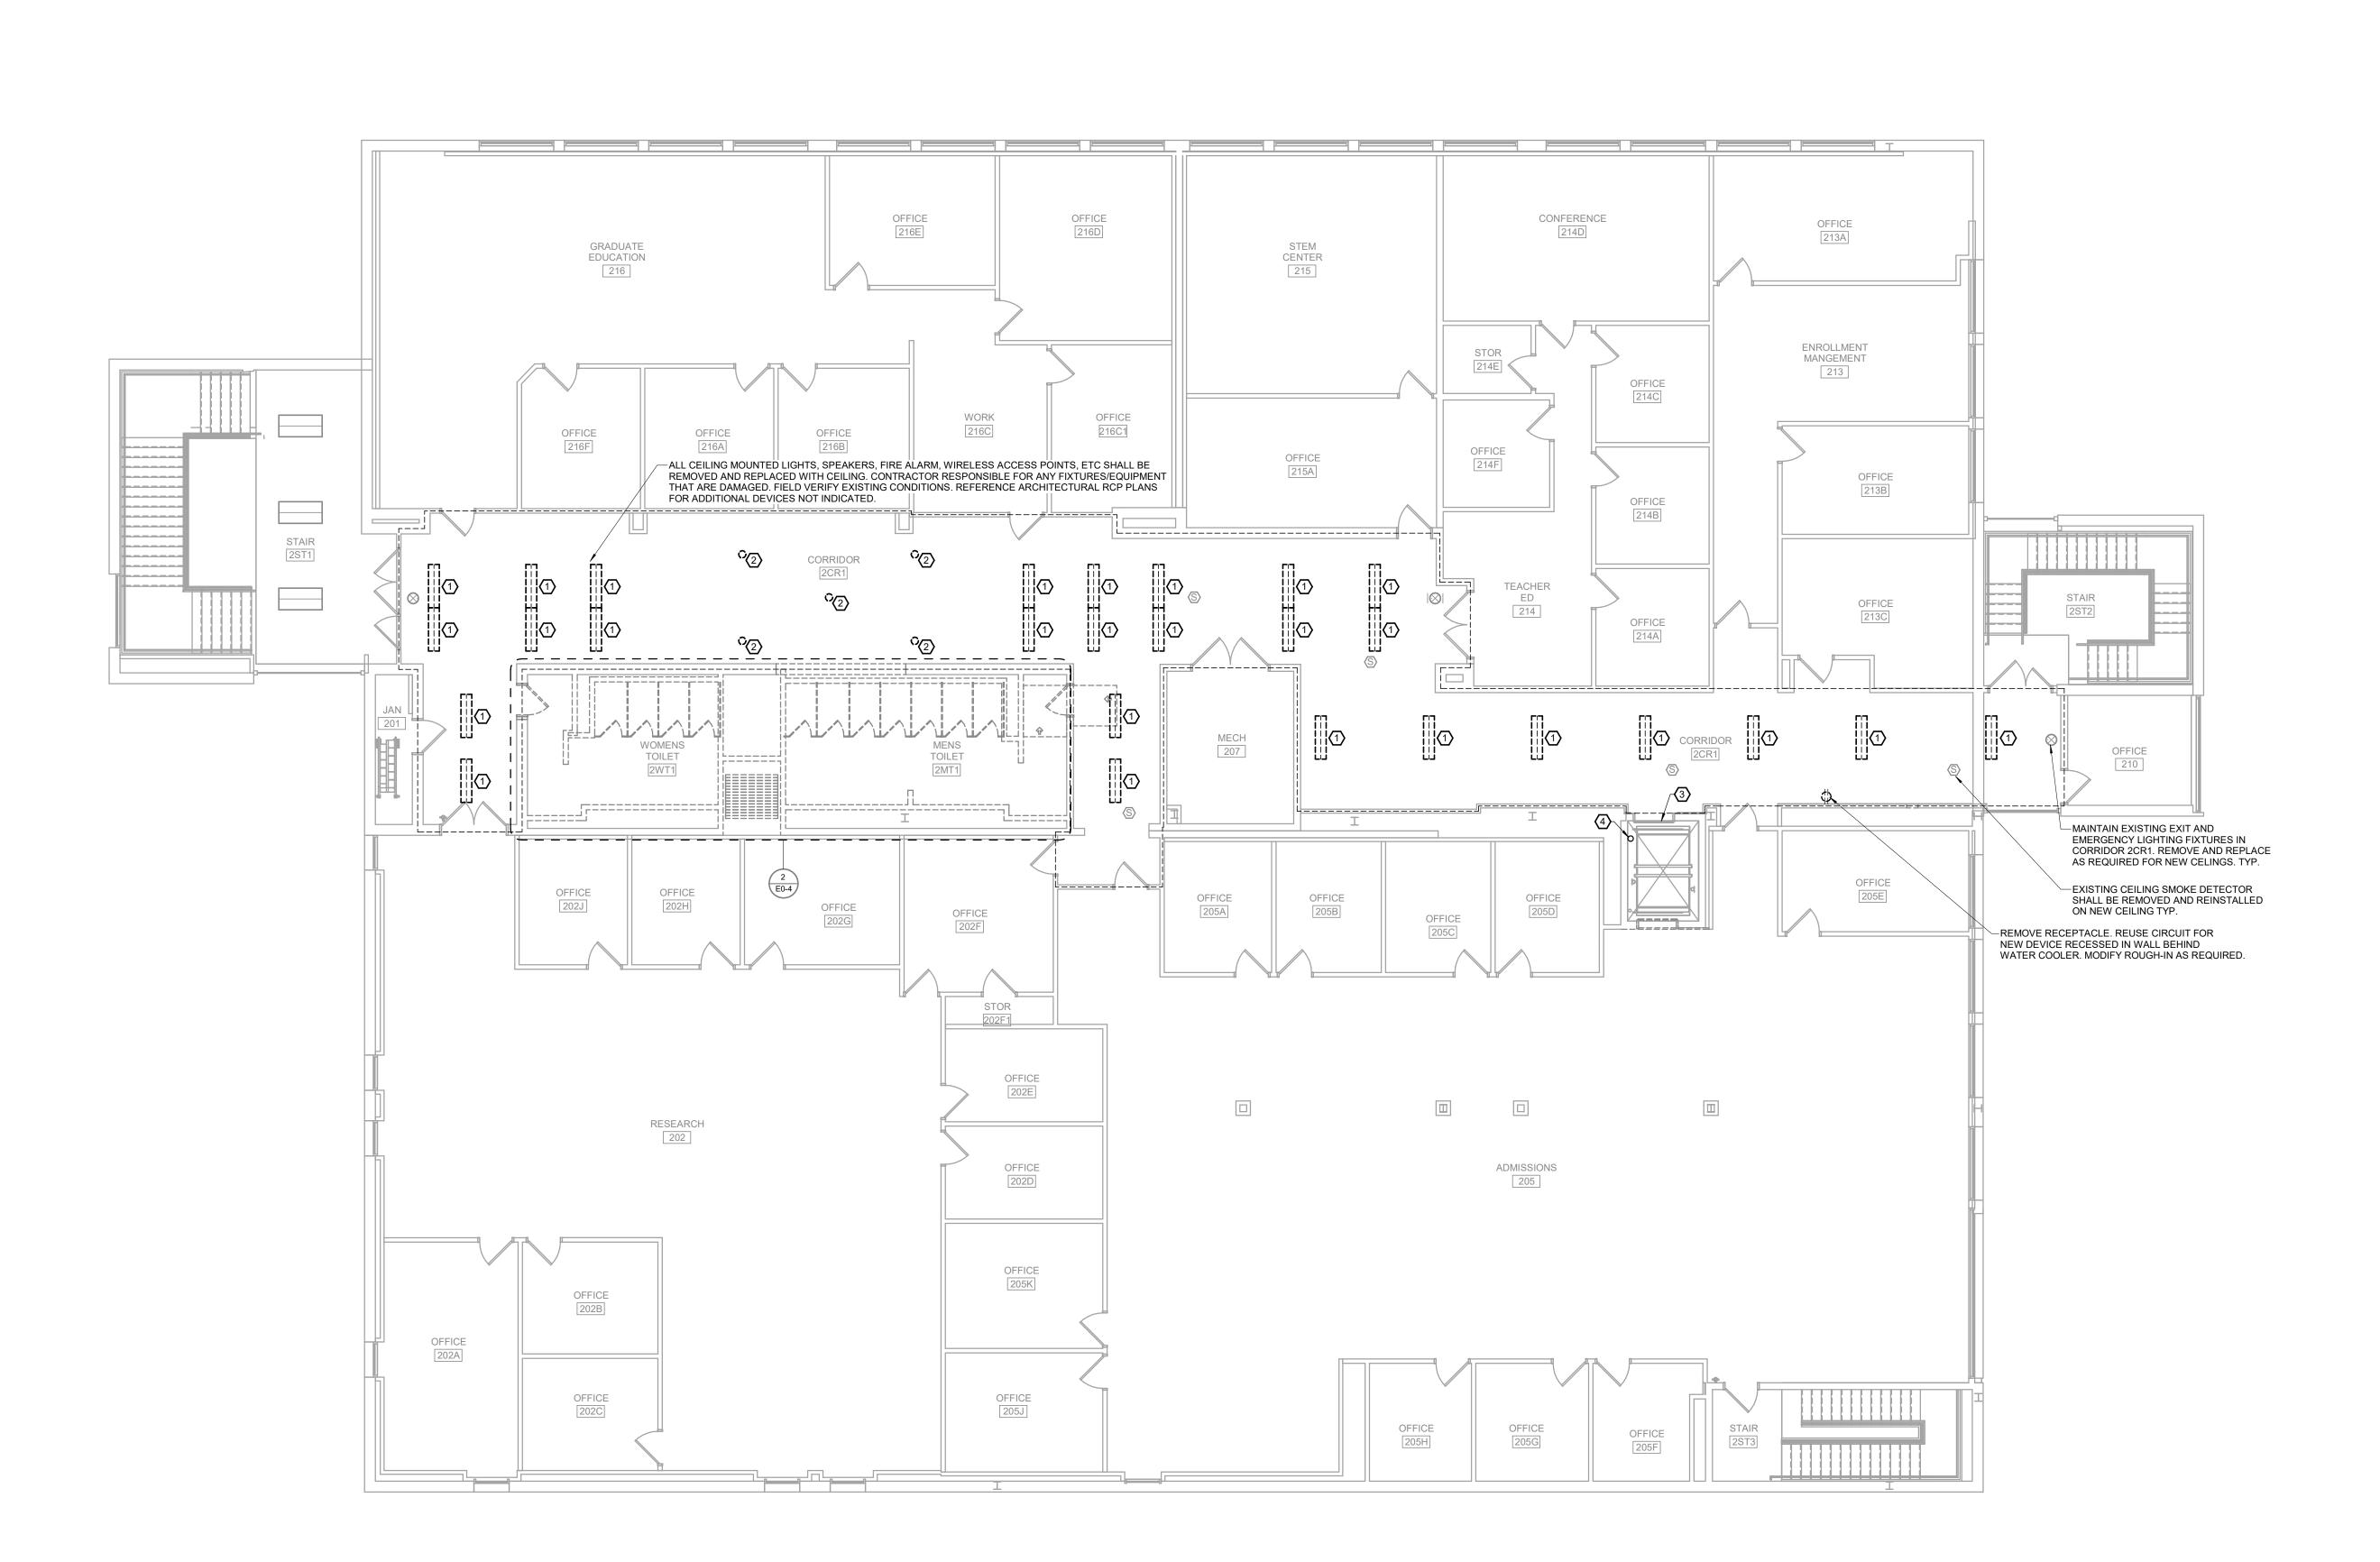
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DATE: 8.28.2023


SECOND LEVEL ELECTRICAL DEMO PLAN

SHEET NUMBER:


E0-3

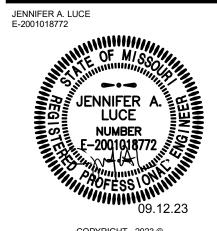

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FIRST LEVEL RESTROOM ELECTRICAL DEMO PLAN SCALE: NOT TO SCALE
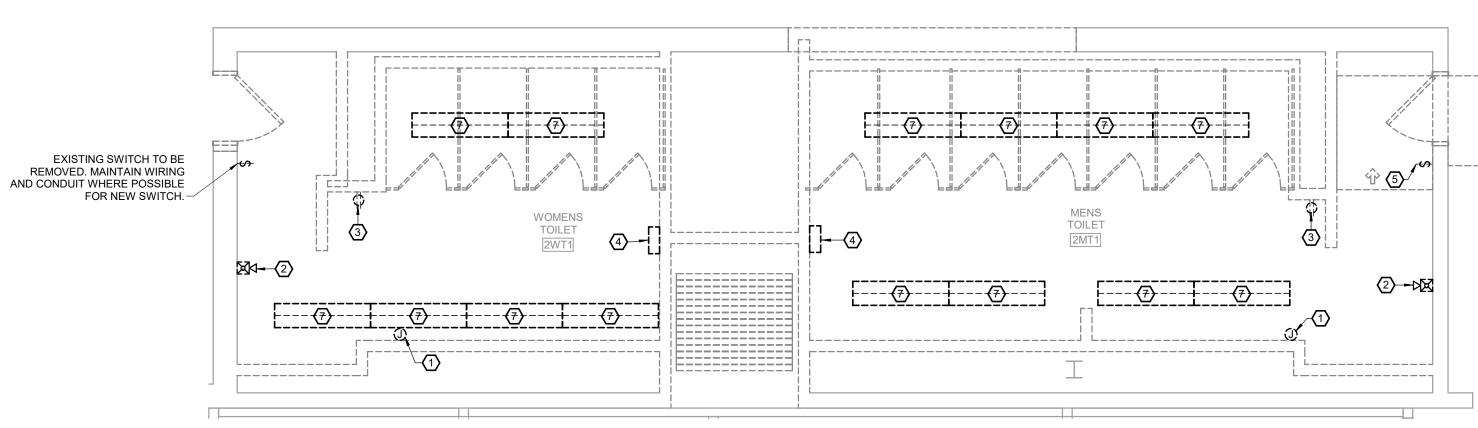
### **GENERAL DEMOLITION NOTES:**

- A. THESE GENERAL NOTES APPLY TO ALL ELECTRICAL AND SPECIAL SYSTEMS DRAWINGS. REFER TO DIVISION 26, 27 AND 28 SPECIFICATIONS FOR ADDITIONAL ELECTRICAL AND SPECIAL SYSTEMS SPECIFICATIONS AND REQUIREMENTS.
- B. AL ELECTRICAL WORK SHALL BE IN COMPLIANCE WITH THE 2017 NEC AS ADOPTED BY THE LOCAL AHJ.
- C. REMOVE ALL UNUSED CONDUIT, CONDUCTORS, PULL BOXES, ETC. FOR DEMOLISHED ITEMS. TURN OFF BREAKERS AND LABEL AS "SPARE" IN THE PANELBOARD DIRECTORY.
- D. OWNER SHALL HAVE FIRST RIGHT OF REFUSAL FOR ALL DEMOLISHED MATERIALS AND EQUIPMENT. STORE ITEMS ON SITE AS DIRECTED BY OWNER.
- E. COORDINATE WITH THE ELECTRICAL UTILITY COMPANY AND ARRANGE FOR SERVICE AND ADJUSTMENTS AS INDICATED ON DRAWINGS. INCLUDE ALL COSTS, CHARGES, FEEDS, ETC. INCURRED BY LOCAL AUTHORITIES INTO BID. PROVIDE ALL MATERIALS AS REQUIRED BY LOCAL AUTHORITIES FOR SERVICE INSTALLATION. ALL WORK SHALL BE IN ACCORDANCE WITH THE REQUIREMENTS OF LOCAL AUTHORITIES.
- F. WHERE DEMOLISHED ELECTRICAL DEVICES ARE PART OF A CIRCUIT THAT IS THRU-WIRED, OR HAS ADDITIONAL DEVICES ON THE CIRCUIT THAT ARE TO REMAIN UNCHANGED, THE CONTRACTOR IS RESPONSIBLE FOR MAINTAINING THE INTEGRITY OF THE EXISTING CIRCUIT. ANY ADDITIONAL CONDUIT, WIRING, BOXES, ETC. NEEDED TO MODIFY THE EXISTING CIRCUIT TO MAINTAIN THE INTEGRITY ARE THE RESPONSIBILITY OF THE CONTRACTOR AND SHALL BE INCLUDED IN THE BASE BID.
- G. EXISTING CONDITIONS ON THIS SET OF CONSTRUCTION DOCUMENTS WERE TAKEN FROM EXISTING DRAWINGS, LIMITED SITE VISITS, AND VISUAL OBSERVATIONS. FIELD VERIFY ALL EXISTING CONDITIONS PRIOR TO SUBMITTING FINAL BIDS. CHANGE ORDERS WILL NOT BE PAID DUE TO UNANTICIPATED CONDITIONS TO MEET INTENT OF WORK.
- REFER TO ARCHITECTURAL DEMOLITION PLANS FOR PHASING AND EXTENTS OF DEMOLITION.
- PROVIDE TEMPORARY POWER OR LIGHTING REQUIRED BY THE CONSTRUCTION MANAGER.
- J. CONTRACTOR RESPONSIBLE FOR ALL CORING, PATCH, AND REPAIR OF ALL WALL AND FLOOR SYSTEMS AS REQUIRED DUE TO NEW CONSTRUCTION. MAINTAIN ALL FIRE RATINGS.
- K. REMOVE ALL UNUSED CONDUIT AND WIRING LOCATED WITHIN THE AREA OF CONSTRUCTION.
- L. REMOVE AND REPLACE COVERPLATES AS NEEDED ON EXISTING WALLS DUE TO NEW FINISHES.
- M. REFER TO ARCHITECTURAL DRAWINGS FOR ALL EXISTING
  EQUIPMENT REQUIRED TO BE RELOCATED. CONTRACTOR
  SHALL FULLY COORDINATE SCHEDULE OF RELOCATING
  FOUIPMENT WITH OWNER
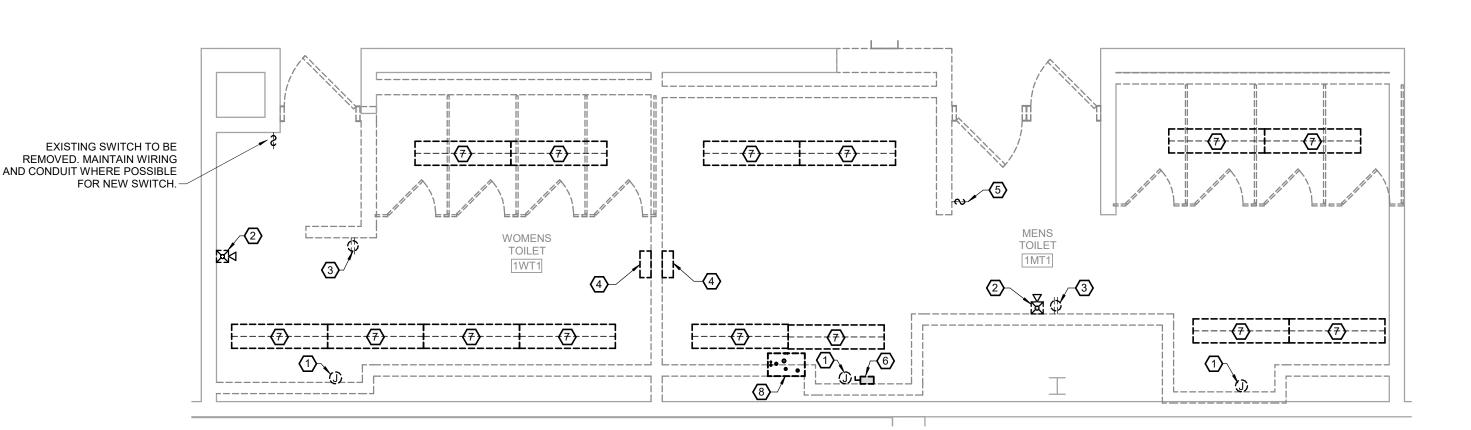
### **PLAN HEX NOTES:**

- 1 EXISTING HAND DRYER TO BE REMOVED. REMOVED UNUSED WIRE BACK TO PANEL. REMOVE ALL UNUSED CONDUIT AND WIRE
- 2 EXISTING FIRE ALARM SPEAKER/STROBE TO BE REUSED. EXTEND WIRING AND CONDUIT AS NECESSARY. REMOVE SURFACE MOUNTED RACEWAY.
- 3 EXISTING DUPLEX TO BE DEMOLISHED. REMOVE UNUSED WIRING AND CONDUIT WHILE MAINTAINING CIRCUITING FOR ANY REMAINING CONNECTED DEVICES.
- 4 EXISTING SURFACE MOUNTED EM FIXTURE TO BE DEMOLISHED. REMOVE UNUSED WIRE BACK TO PANEL AND CAP ASSOCIATED CONDUIT AS NECESSARY. REMOVE SURFACE MOUNTED RACEWAY.
- 5 EXISTING WALL SWITCH TO BE DEMOLISHED. REMOVE UNUSED WIRING AND CONDUIT WHERE NOT REUSED. PATCH WALL AS APPLICABLE.
- 6 EXISTING DISCONNECT FOR INSTANTANEOUS WATER HEATER ABOVE CEILING TO BE REMOVED. REMOVE UNUSED WIRING AND CONDUIT BACK TO PANEL.
- 7 EXISTING 1X4 FIXTURE TO BE REMOVED. RETAIN WIRING AND CONDUIT WHERE POSSIBLE FOR NEW FIXTURES TO BE PLACED ON EXISTING CIRCUIT.
- 8 EXISTING INSTANTANEOUS WATER HEATER ABOVE CEILING TO BE DEMOLISHED. REMOVE ALL ASSOCIATED POWER, DISCONNECT, PIPING, ETC. REMOVE ASSOCIATED WIRING BACK TO PANEL AND NOTE BREAKER AS SPARE IF NOT REUSED. REMOVE AND ABANDON UNUSED CONDUIT WHERE CONCEALED.



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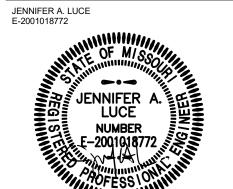


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PROJECT ENGINEER: Approver DRAWN BY: LDN CHECKED BY: JAL


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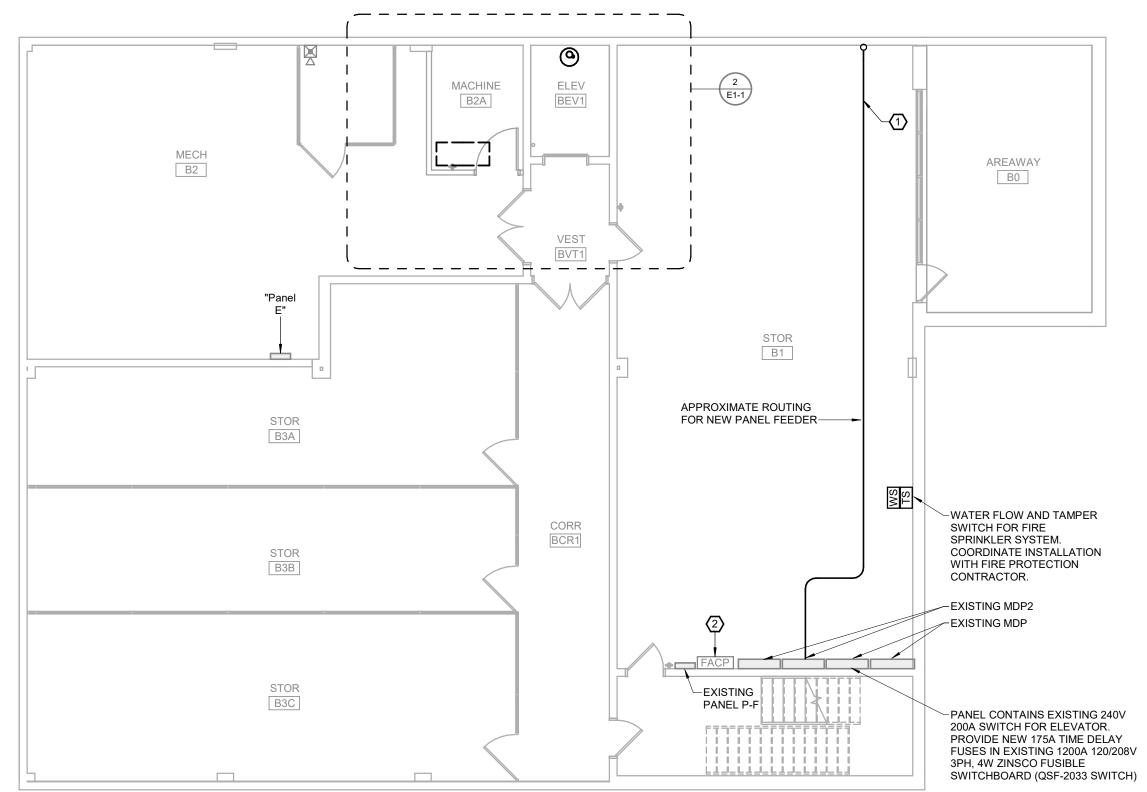
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ENLARGED ELECTRICAL DEMO PLAN

SHEET NUMBER:

**E0-4** 



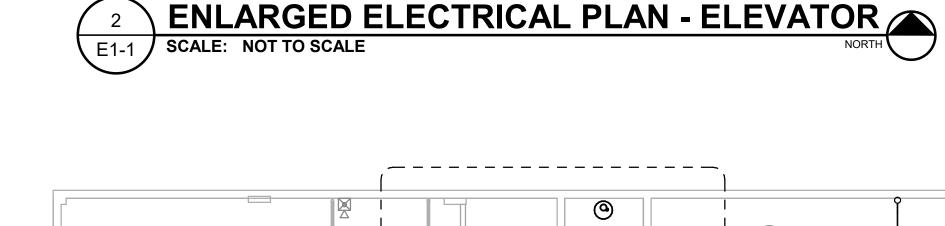

LOWER LEVEL ELECTRICAL PLAN

**GENERAL NOTES:** 

REFER TO SHEET E2-1 FOR GENERAL NOTES.

### **PLAN HEX NOTES:**

- ROUTE NEW 200A FEEDER FROM EXISTING MDP2 TO EXISTING PANEL "2NLP1B". ROUTE 4 - #3/0 AND #6 GROUND IN 2.5" CONDUIT FEEDER AS NECESSARY TO AVOID CONFLICTING WITH EXISTING AND NEW PIPING, CONDUIT, ETC. DO NOT ROUTE IN ELEVATOR SHAFT OR MACHINE ROOM. FIELD VERIFY TERMINATION POINT VIA PULL BOX LOCATED ABOVE THE PANEL ON THE UPPER FLOOR.
- 2 EXISTING FIRE ALARM SYSTEM. NFS-320 NOTIFIER.
- 3 LIGHT FIXTURE INSTALLED VERTICALLY ADJACENT TO THE STAIR TO THE BOTTOM OF THE SHAFT. VERIFY EXACT LOCATION FIXTURE ORIENTATION AND MOUNTING HEIGHT OF SWITCH AND LIGHT FIXTURE WITH ELEVATOR EQUIPMENT INSTALLER PRIOR TO ANY ROUGH-IN.
- 4 CONNECT TO NEW DEDICATED CIRCUIT FED FROM EXISTING PANEL E. PROVIDE NEW 20A 120V BREAKER IN EMPTY SPACE OF EXISTING PANEL E LOCATED IN MECH B2. THERE SHOULD BE ONE 120V DEDICATED CIRCUIT FOR ELEVATOR SHAFT BASED ON EXISTING DOCUMENTATION.
- CONNECT TO EXISTING ZINSCO QSF-2033 FUSIBLE SWITCHBOARD 200A SWITCH FOR ELEVATOR, 240V/3. PROVIDE
- APPROXIMATE LOCATION OF ELEVATOR CONTROLLER. E/C SHALL MAKE ALL FINAL CONNECTIONS OF ALL POWER CIRCUITS VERIFY ALL REQUIREMENTS WITH EQUIPMENT WITH EXISTING EQUIPMENT PRIOR TO INSTALLATION.
- TWO CAT6 IT CONNECTIONS FOR ELEVATOR CONTROLLER PHONE COMMUNICATION SYSTEM. COORDINATE WITH OWNER FOR ANALOG CONVERSION AND EXISTING CONDITIONS FOR COMMUNICATIONS AS REQUIRED. FIELD VERIFY EXACT LOCATION IN MACHINE ROOM.
- UNDER 2019 NFPA 72 SMOKE SENSORS AND HEAT SENSORS SHALL BE INSTALLED IN THE HOISTWAY OR PIT IN MANNER TO BE TESTED AND SERVICED. REMOTE SENSORS SHALL BE INSTALLED IN THE ELEVATOR HOISTWAY WITH AN ACCESSIBLE MEANS TO TEST THE HEAT AND SMOKE SENSOR FROM OUTSIDE SMOKE SENSOR FROM OUTSIDE THE HOISTWAY.
- 9 ELEVATOR TO BE FULLY REFURBISHED. ALL ELECTRICAL REQUIREMENTS AND WORK TO BE COORDINATED WITH OWNERS VENDOR. REMOVE POWER AND RECONNECT.
- 10 CONNECT TO PREVIOUS CIRCUIT FOR ELEVATOR LIGHTING. PROVIDE NEW CIRCUIT IF NOT DEDICATED.
- 11 INSTALL NEW CEILING MOUNTED SMOKE DETECTOR OUTSIDE ELEVATOR DOORS. CONNECT TO EXISTING FIRE ALARM SYSTEM.

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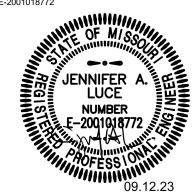
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CHECKED BY: PROJECT NUMBER:

22-703A RC000638

8.28.2023

LOWER LEVEL

SHEET NUMBER:

NOTES:

. VERIFY ALL WIRING REQUIREMENTS WITH THE ELEVATOR EQUIPMENT SUPPLIER PRIOR TO ANY

2. E/C SHALL VERIFY THAT INSTALLATION IS IN COMPLETE COMPLIANCE WITH THE LATEST EDITION

3. ALL SMOKE DETECTORS ARE TO BE PROVIDED WITH NORMALLY CLOSED, DRY ISOLATED

4. ONE LOBBY IS DESIGNATED AS THE MAIN FIRE

DESIGNATION WITH THE LOCAL FIRE MARSHALL

AND THE ELEVATOR EQUIPMENT SUPPLIER PRIOR

5. ALL FIRE ALARM DEVICES SHALL BE CONNECTED

NORMALLY CLOSED AUXILIARY CONTACT IN-THE MODULE. CONTACTS SHALL OPEN TO

NOTIFY CONTROLLER THAT POWER HAS

POWER MODULE

FIRE ALARM RELAY IN THE POWER-MODULE. ACTIVATION OF ANY HEAT DETECTOR IN THE MACHINE ROOM OR

THE SHAFT SHALL SHUNT TRIP THE MAIN

VOLTAGE MONITORING RELAY

FUSIBLE-

SWITCH AT

MAIN PANEL

POWER DISCONNECT SWITCH IN THE

ZAM

DISCONNECTING MEANS

ALARM MANUFACTURER.

BUSSMAN ELEVATOR POWER MODULE SWITCH IN

THE ELEVATOR MACHINE ROOM. PROVIDE WITH

TRIP MECHANISM, CONTROL TRANSFORMER AND

NORMALLY CLOSED AUXILIARY CONTACTS. VERIFY ALL WIRING REQUIREMENTS WITH E/M AND FIRE

NEMA 1 ENCLOSURE. SWITCH SHALL BE LOCATED IN

KEYED TEST SWITCH, GREEN PILOT LIGHT, 120V FIRE

ALARM RELAY, VOLTAGE-MONITORING RELAY, SHUNT

SHUNT-TRIPPED.

CONTACTS AND SHALL BE NON-RESETTING.

FLOOR LOBBY, E/C SHALL VERIFY LOBBY

TO THE BUILDING FIRE ALARM SYSTEM.

OF THE ANSI ELEVATOR CODE.

TO ANY ROUGH-IN.

PROVIDE FIRE ALARM CONTROL MODULE -

AND WIRE TO FIRE ALARM SYSTEM SUCH

THAT CONTROL VOLTAGE IS MONITORED

LOSS OF VOLTAGE SHALL PRODUCE A

TROUBLE ALERT AT THE FIRE ALARM

FOR ELEVATOR EMERGENCY OPERATION.

# **ELEVATOR FIRE/SMOKE CONTROL SCHEMATIC**

SCALE: NOT TO SCALE

ELEVATOR LOBBY (NOT-

FIRE FLOOR LOBBY.)

DESIGNATED AS THE MAIN

/SMOKE DETECTOR AT TOP OF ELEVATOR SHAFT. HEAT DETECTOR SHALL BE WITHIN 2'-0" OF SPRINKLER HEAD.

HEAT DETECTOR AT TOP OF ELEVATOR SHAFT TO BE

MECHANISM IN THE ELEVATOR POWER MODULE.

—ELEVATOR LOBBY (NOT

FIRE FLOOR LOBBY.)

DESIGNATED AS THE MAIN

ELEVATOR MACHINE ROOM

**ELEVATOR** 

CONTROLLER

ELEVATOR LOBBY

(DESIGNATED AS THE MAIN

WITH THE FIRE MARSHALL)

FIRE FLOOR - VERIFY FLOOR

LOCATED WITHIN 2'-0" OF EACH SPRINKLER HEAD IN THE

CONTRACTOR. ACTIVATION OF THIS HEAT DETECTOR SHALL

CAUSE A FIRE ALARM RELAY TO ACTIVATE THE SHUNT-TRIP

HEAT DETECTOR AT ELEVATOR MACHINE ROOM TO BE

HEAT DETECTOR AT BASE OF ELEVATOR SHAFT TO BE

ROOM. COORDINATE QUANTITY WITH FIRE SPRINKLER

LOCATED WITHIN 2'-0" OF EACH SPRINKLER HEAD IN THE

CONTRACTOR. ACTIVATION OF THIS HEAT DETECTOR SHALL

CAUSE A FIRE ALARM RELAY TO ACTIVATE THE SHUNT-TRIP

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ROOM. COORDINATE QUANTITY WITH SPRINKLER

MECHANISM IN THE ELEVATOR POWER MODULE.

MECHANISM IN THE ELEVATOR POWER MODULE.

PROVIDE FIRE ALARM MODULES TO PROVIDE PRIMARY

ALL WIRING REQUIREMENTS WITH FIRE ALARM MANUFACTURER AND ELEVATOR EQUIPMENT SUPPLIER.

LOCATE IN THE ELEVATOR MACHINE ROOM.

FLOOR RECALL, ALTERNATE FLOOR RECALL AND "FIREMAN'S

HAT" INDICATION AT THE ELEVATOR CONTROLLER. VERIFY

LOCATED WITHIN 2'-0" OF EACH SPRINKLER HEAD IN THE


CONTRACTOR. ACTIVATION OF THIS HEAT DETECTOR SHALL CAUSE A FIRE ALARM RELAY TO ACTIVATE THE SHUNT-TRIP

ROOM. COORDINATE QUANTITY WITH FIRE SPRINKLER



### PLAN HEX NOTES:

- 1 ELEVATOR TO BE FULLY REFURBISHED. ALL ELECTRICAL REQUIREMENTS AND WORK TO BE COORDINATED WITH OWNERS VENDOR. REMOVE POWER AND RECONNECT.
- 2 NEW CONDUIT 3" WITH 3/0 FEEDER DOWN THROUGH EXISTING CHASE TO LOWER LEVEL MECHANICAL ROOM.
- 3 EXISTING PANEL B. FIELD VERIFY EXISTING CIRCUITS IN PANEL PRIOR TO CONSTRUCTION. PROVIDE UPDATED TYPED LABELS AND SCHEDULE FOR PANELBOARD.
- 4 MAINTAIN EXISTING EXIT AND EMERGENCY LIGHTING FIXTURES IN CORRIDOR. MAINTAIN AND REUSE EXISTING WIRING AND CONDUIT WHERE POSSIBLE.

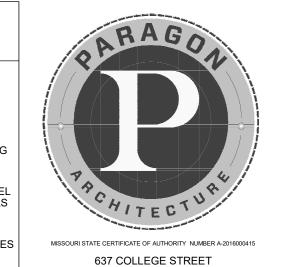

PH: 417.885.0002 www.paragonarchitecture.com

SPRINGFIELD, MO 65806



engineering consultants
3333 E. Battlefield Rd | Suite 1000
Springfield, MO 65804
417.881.0020 | www.rtmec.com
STATE OF MISSOURI

#2014035826 FOR ENGINEERING

CERTIFICATE OF AUTHORITY:

JENNIFER A. LUCE E-2001018772 OF M/



THESE PRINTS ARE THE PROPERTY OF PARAGON
ARCHITECTURE, LLC AND SHALL BE USED ONLY FOR THE
PROJECT REFERENCE BELOW

REVISION SCHEDULE

SECT DESCRIPTION:
SENTENNIAL HALL IMPROVEMENTS
ND RENOVATION

PROJECT ENGINEER: Approver DRAWN BY: LDN CHECKED BY: JAL


PROJECT NUMBER: 22-703A RC000638

DATE: 8.28.2023

FIRST LEVEL ELECTRICAL PLAN

SHEET NUMBER:

E1-2

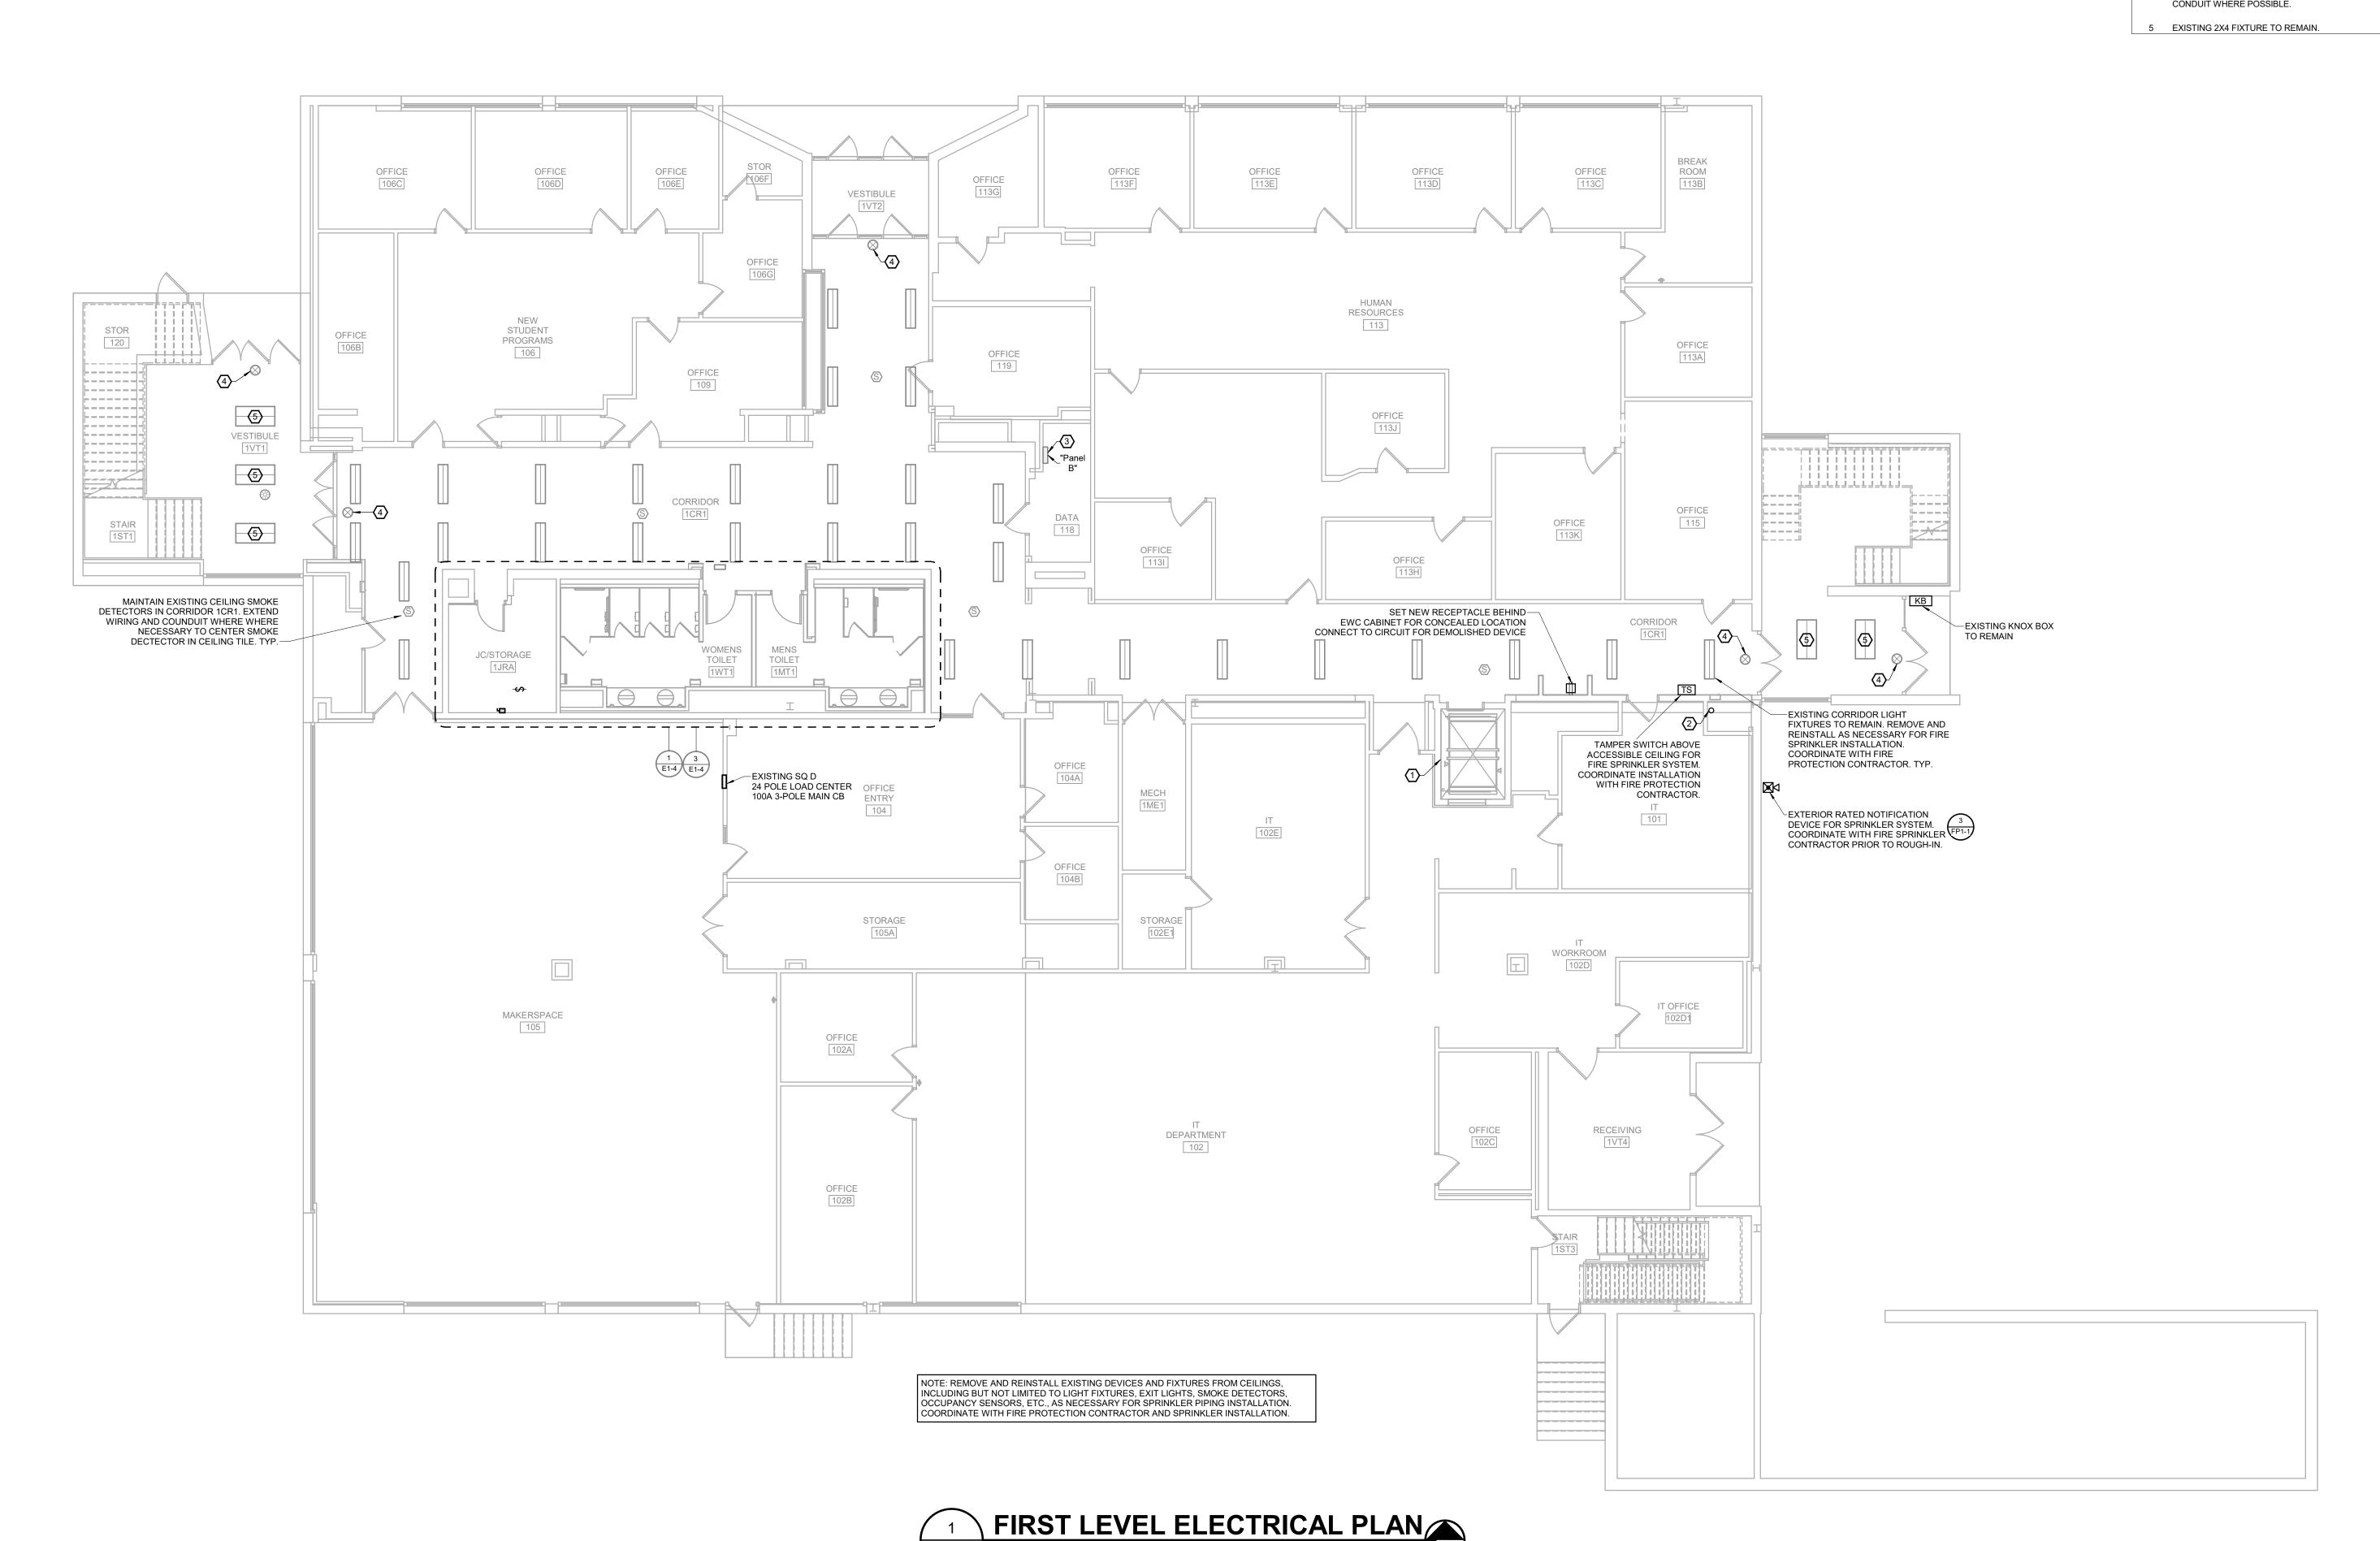

E1-2 | SCALE: 1/8" = 1'-0"

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### **GENERAL NOTES:**

REFER TO SHEET E2-1 FOR GENERAL NOTES.

### **PLAN HEX NOTES:**

- 1 NEW 3" CONDUIT AND 3/0 FEEDER ABOVE ACCESSIBLE CEILING TO EXISTING ABOVE CEILING JUNCTION BOX TO REROUTE EXISTING 3/0 FEED FROM EXISTING MDP TO EXISTING PANEL "2NLP1B". APPROXIMATE ROUTING INDICATED. COORDINATE INSTALLATION WITH EXISTING CONDITIONS. DO NOT ROUTE IN ELEVATOR SHAFT.
- 2 NEW CONDUIT 3" WITH 3/0 FEEDER DOWN THROUGH EXISTING

INSTALLED IN THE ELEVATOR HOISTWAY WITH AN ACCESSIBLE MEANS TO TEST THE HEAT AND SMOKE SENSOR FROM

- CHASE TO LOWER LEVEL MECHANICAL ROOM. 3 UNDER 2019 NFPA 72 SMOKE SENSORS AND HEAT SENSORS SHALL BE INSTALLED IN THE HOISTWAY OR PIT IN MANNER TO BE TESTED AND SERVICED. REMOTE SENSORS SHALL BE
- 4 CONNECT TO EXISTING CORRIDOR LIGHTING CIRCUIT IN EXISTING PANEL E, LOCATED IN ADMISSIONS 205.

OUTSIDE SMOKE SENSOR FROM OUTSIDE THE HOISTWAY.

- 5 ELEVATOR TO BE FULLY REFURBISHED. ALL ELECTRICAL REQUIREMENTS AND WORK TO BE COORDINATED WITH OWNERS VENDOR. REMOVE POWER AND RECONNECT.
- 6 EXISTING RECESSED PANELBOARD TO REMAIN. PROVIDE UPDATED TYPED LABELS AND SCHEDULES FOR ANY CHANGES MADE TO PANELBOARD.
- 7 EXISTING 2X4 FIXTURE TO REMAIN.
- 8 MAINTAIN EXISTING EXIT AND EMERGENCY LIGHTING FIXTURES IN CORRIDOR. MAINTAIN AND REUSE EXISTING WIRING AND CONDUIT WHERE POSSIBLE.

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> PH: 417.885.0002 www.paragonarchitecture.com



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FOR ENGINEERING

JENNIFER A. LUCE E-2001018772



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REVISION SCHEDULE

ENTENNIAL HALL IMPROVEMENT

PROJECT ENGINEER: Approver DRAWN BY: LDN CHECKED BY:

PROJECT NUMBER: 22-703A RC000638

8.28.2023

SECOND LEVEL ELECTRICAL PLAN

SHEET NUMBER:

E1-3

PIPING INSTALLATION. COORDINATE WITH FIRE PROTECTION CONTRACTOR AND SPRINKLER INSTALLATION. PROVIDE NEW #12 GAUGE WIRE SUPPORTS FOR NEW FIXTURES REINSTALLED UNDER THIS CONTRACT. SECOND LEVEL ELECTRICAL PLAN SCALE: 1/8" = 1'-0"

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NOTE: REMOVE AND REINSTALL EXISTING DEVICES AND FIXTURES FROM

CEILINGS, INCLUDING BUT NOT LIMITED TO LIGHT FIXTURES, EXIT LIGHTS, SMOKE DETECTORS, OCCUPANCY SENSORS, ETC., AS NECESSARY FOR SPRINKLER

REFER TO SHEET E2-1 FOR GENERAL NOTES.

AND CONDUIT WHERE POSSIBLE.

### **PLAN HEX NOTES:**

- 1 CONNECT TO EXISTING CORRIDOR LIGHTING CIRCUIT FED FROM EXISTING PANEL B LOCATED IN DATA 118. FIXTURES TO
- BE CONTROLLED WITH EXISTING CORRIDOR FIXTURES. 2 CONNECT TO EXISTING RESTROOM LIGHTING CIRCUIT FED FROM EXISTING PANEL B LOCATED IN DATA 118. REUSE WIRING
- 3 NEW LOW VOLTAGE CEILING MOUNTED OCCUPANCY SENSOR AND POWER PACK ABOVE CEILING. WIRE MULTIPLE SENSORS TO POWER PACK PER MANUFACTURER RECOMMENDATIONS.
- 4 NEW CEILING MOUNTED EMERGENCY FIXTURE.
- 5 NEW SUSPENDED FIXTURE. FIXTURE SHALL BE SUPPORTED BY A MINIMUM OF TWO #12 GAGE HANGER WIRES. SUSPEND TO 10'
- 6 NEW RECESSED CAN LIGHT, CENTERED IN SOFIT.
- 7 CONNECT TO HALLWAY RECEPTACLE CIRCUIT FED FROM EXISTING PANEL B.
- ALL WIRING AS NECESSARY FOR NEW LOCATION AS REQUIRED.

8 EXISTING RELOCATED FIRE ALARM SPEAKER/STROBE. EXTEND

- 9 CONNECT TO EXISTING 120V 20A BREAKER IN EXISTING PANEL "2NLP2B" LOCATED IN ADMISSIONS 205.
- 10 CONNECT TO EXISTING 120V 20A SPARE BREAKER IN EXISTING PANEL "2NLP2A" LOCATED IN ADMISSIONS 205.
- 11 CONNECT RECEPTACLES TO EXISTING CIRCUIT FROM DEMOLISHED HAND DRYERS.
- 12 PROVIDE NEW 30A 2 POLE BREAKER IN EXISTING PANEL B LOCATED IN DATA 118. VERIFY LOCATION FOR DEMOLISHED WATER HEATER BREAKER. REMOVE AND REPLACE BREAKER AS REQUIRED.
- 13 CONNECT TO 20A, 1-POLE CIRCUIT BREAKER IN EXISTING PANEL. PANEL 'B' IF AVAILABLE OR PANEL IN LAB.



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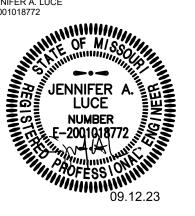
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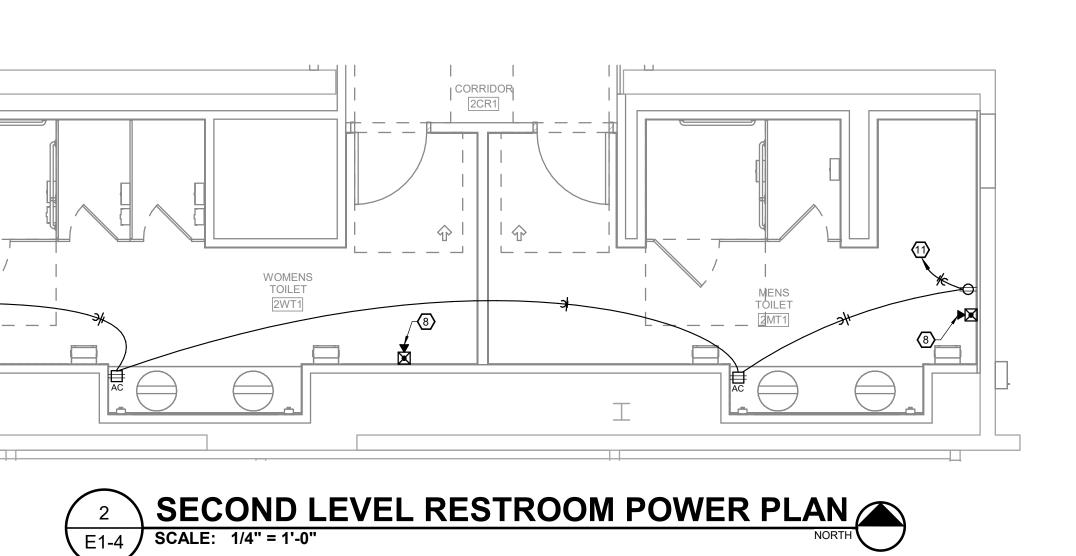
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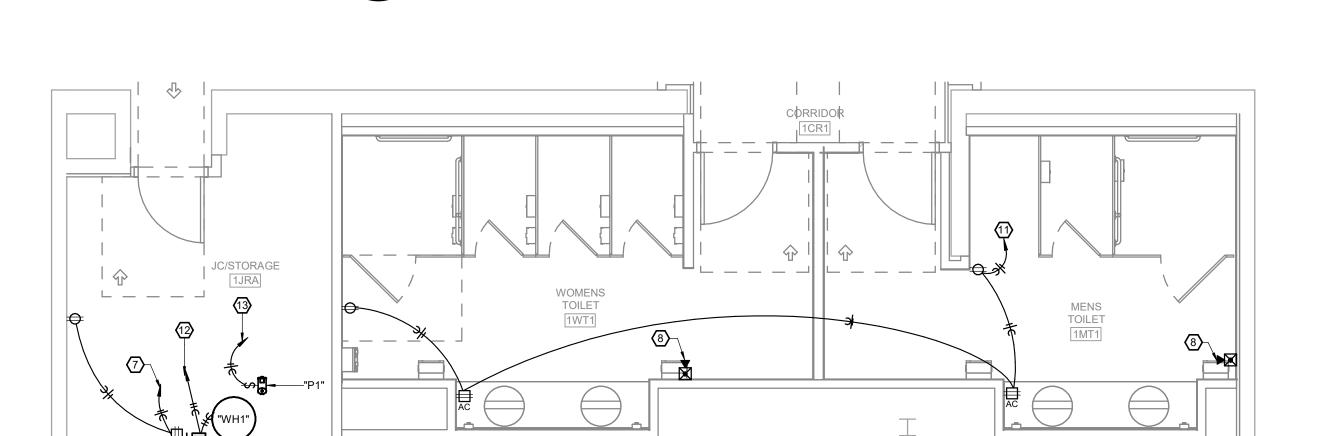
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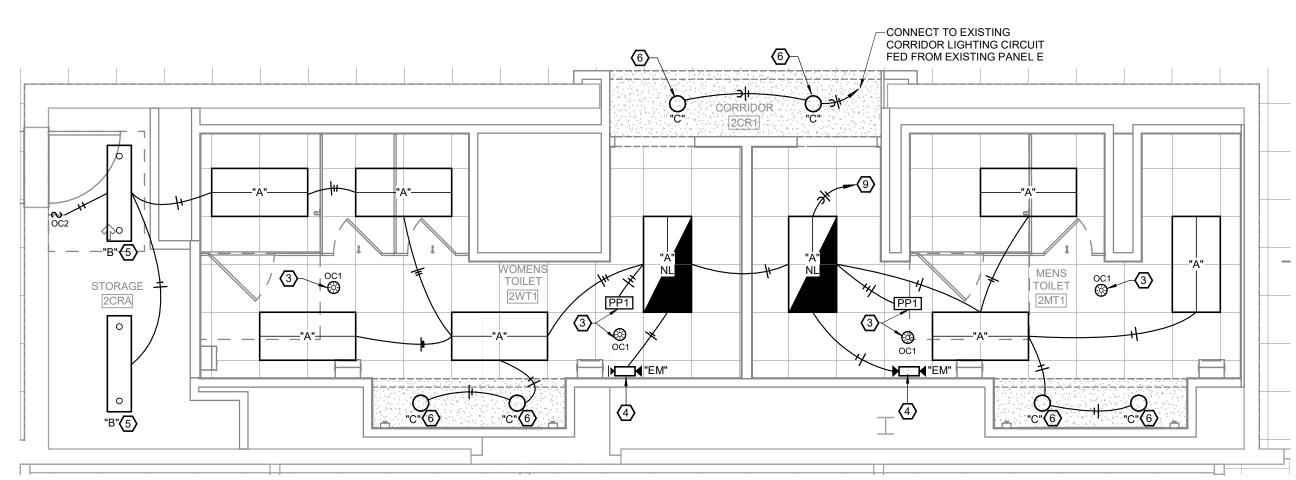


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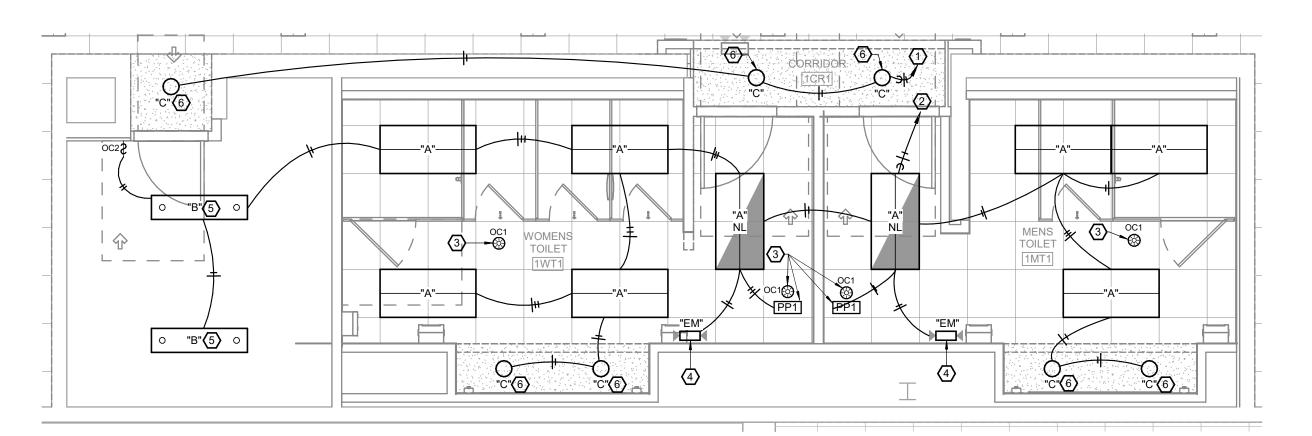
FIRST LEVEL RESTROOM POWER PLAN

E1-4 SCALE: 1/4" = 1'-0"

NORTH









**ENLARGED** 

ELECTRICAL PLAN

CENTENNIAL HALL IMPROVEMENTS AND RENOVATION


SHEET NUMBER:

PROJECT NUMBER: 22-703A


RC000638

8.28.2023

E1-4

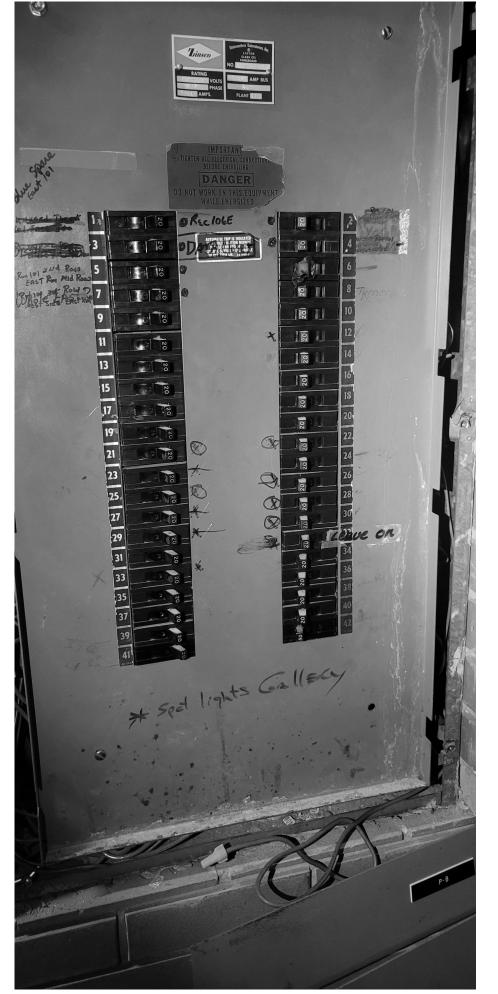



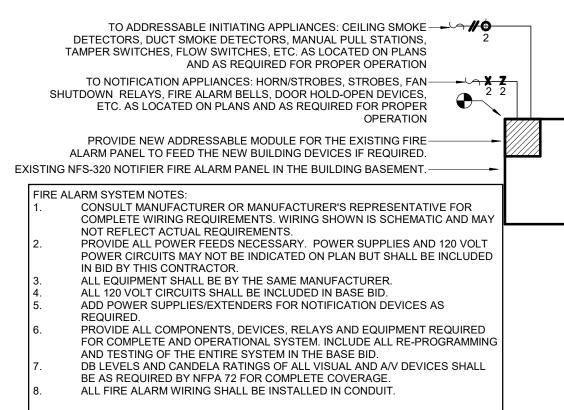

F12-1 SCALE: NOT TO SCALE	ISER DIAGRA	<u>\M</u>
LIGHT SWITCH(ES) FOR OVERRIDE (WHERE SHOWN ON THE PLANS). OVERRIDE TURNS LIGHTS OFF REGARDLESS OF SENSOR CONTROL.  LIGHTING FIXTURES	RED BLACK BLUE  CONTROL UNIT  SH	OCCUPANCY SENSOR (WALL OR CEILING-MOUNTED). UP TO FOUR SENSORS CAN BE CONTROLLED FROM A SINGLE POWER PACK  WATTSTOPPER BZ-150 POWER PACK FOR USE WITH CEILING MOUNTED OCCUPANCY SENSORS.

1. WIRING DIAGRAM SHOWN IS SCHEMATIC. WIRE AND INSTALL PER THE MANUFACTURER'S REQUIREMENTS - VERIFY ALL WIRING REQUIREMENTS PRIOR TO ANY ROUGH-IN. 2. UNLESS NOTED OTHERWISE OCCUPANCY SENSOR CONTROL IS AUTOMATIC ON - AUTOMATIC OFF POWER PACK SHALL ONLY CONTROL SENSORS WITHIN SAME ROOM. 4. LOCATE POWER PACK ABOVE AN ACCESSIBLE CEILING AS CLOSE TO THE OCCUPANCY SENSOR AS POSSIBLE. PROVIDE VOLTAGE TO MATCH FIXTURES SERVED. 5. PROVIDE ADDITIONAL POWER PACKS FOR ADDITIONAL LIGHTING CONTROLLED BY SAME

**OCCUPANCY SENSOR WIRING DIAGRAM** SCALE: NOT TO SCALE

ELEVATOR POWER MODULE SCHEDULE												
PLAN	LOAI	D				SWIT	ГСН	FL	JSE	ENCLOSURE	NOTES	
MARK	EQUIPMENT SERVED	HP	VOLTAGE	MANUFACTURER	MODEL	AMP	POLES	AMP	TYPE	NEMA TYPE	NOTES	
PM-1	ELEVATOR	25	208	BUSSMAN	PS3	200	3	200	LPN-RK	NEMA 1	CT, FR, K, GP, MR, VMR	
GD - GE HD - HE	BBREVIATIONS: D - GENERAL DUTY FR - FIRE SAFETY INTERFACE RELAY VMR - FIRE VOLTAGE MONITORING RELAY D - HEAVY DUTY K - KEYED TEST SWITCH MR - MECHANICAL INTERLOCK AUXILIARY RELAY N - SOLID NEUTRAL GP - GREEN PILOT LIGHT CT - CONTROL POWER TRANSFORMER											
THE ELE	EVATOR SUPPLIER PRIO	R TO OR	DERING AN	Y EQUIPMENT OR	PROVIDIN	NG ROUGI				CONDITIONS.	VERIFY REQUIREMENTS WITH	
THE FUS	SCONNI	EC'	DERING AN	CHEDU	JLE	NG ROUGI		NSTALL	ATION.			
THE FUS	EVATOR SUPPLIER PRIO	EC'	DERING AN	CHEDU	PROVIDIN	NG ROUGI	H-IN OR IN		ATION.	ENCLOSURI	<u> </u>	
THE FUSTHE ELE	SCONNI	EC'	T SC	CHEDU	JLE switch	NG ROUGE	H-IN OR IN	FUS	ATION.	ENCLOSURI	<u> </u>	

LI	GHTIN	G DEVICE	SCHI	EDULI	E
PLAN MARK	MOUNTING TYPE	MANUFACTURER	MODEL	FINISH	NOTES
OC1	CEILING	WATTSTOPPER	DT-305	WHITE	LOW VOLTAGE DUAL TECH CEILING OCCUPANCY SENSOR PROGRAMMED TO AUTO ON/AUTO OFF
PP1	PLENUM	WATTSTOPPER	BZ150		
OC2	WALL	WATTSTOPPER	DW-100	WHITE	LINE VOLTAGE DUAL TECH OCCUPANCY SWITCH PROGRAMMED TO AUTO ON/AUTO OFF

L	JMINA	IRE SCHEDU	ILE								
PLAN			MOUNTING			LUMINAIR	E SOURCE		ELEC1	RICAL	
MARK	MANUFACTURER	MODEL	TYPE	FINISH	SOURCE TYPE	LUMENS	COLOR TEMP (K)	CRI	VOLTAGE	LOAD (VA)	DESCRIPTION
Α	CREE LIGHTING	ZR24-30L-10V5-UNV	GRID	WHITE	LED	3490	3500	80	120	29	1
AE	CREE LIGHTING	ZR24-30L-10V5-UNV-EB	GRID	WHITE	LED	3490	3500	80	120	29	1
В	H.E. WILLIAMS	76R-4-L30/835-DIM-UNV	SUSPENDED	WHITE	LED	3000	3500	80	120	23	1
С	H.E. WILLIAMS	6DR-L15/835-DIM-UNV-OW-OF-WH-MWT	RECESSED	WHITE	LED	1500	3500	80	120	15	1
Е	METALUX	4VT3-LD5-5-G-UNV-L835-CD1-U	SURFACE	WHITE	LED	5000	3500	80	120	49	1
EM	SURE-LITES	APEL	UNIVERSAL	WHITE	LED				120	1	1,5
Х	SURE-LITES	LPX-7-SD	UNIVERSAL	WHITE/GREEN	LED				120	1	1,5
NOTE									·		

CONTRACTOR SHALL PROVIDE ALL MOUNTING HARDWARE, EQUIPMENT, AND ALL ACCESSORIES AS REQUIRED. PROVIDE TWO #12 GUAGE WIRE SUPPORT WIRES PER FIXTURES. SUSPEND LIGHT FIXTURE FROM AIRCRAFT CABLE AT 10'-0" AFF

REFER TO ARCHITECTURAL DRAWINGS FOR MOUNTING HEIGHT OF LIGHT FIXTURE ABOVE MIRROR AND LAVATORY

4 FIXTURE SHALL BE FORMED INTO A RECTANGLE AS SHOWN ON THE PLANS. COORDINATE WITH MANUFACTURER ON POWER FEED LOCATION.

CIDCI	IIT C	DDE	ΛL	

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	PANEL NAME: "2NLP2B"					"2NLP2B" FED BY: MDP2 ENCLOSURE: NEMA 1														AIN TYPE: MLO ATING (A): 225 A		
		MOUNTING: RECESSED								M	ANUFA		R: GE		K II	AQL	l .		MCB RATING (A): MLO MIN. AIC RATING (A): ## KAIC			
СКТ	LOAD DESCRIPTION	С	W	G	СВ	Р	TYPE		A		В	(		TYPE	Р	СВ	G	W	С	LOAD DESCRIPTION	СК	
1	EAST WALL 216E				20	1		0	0					-	1	20				EXIT/EMERGENCY	2	
3	216 A RECEPTACLE				20	1				0	0				1	20				SPARE	4	
5	SPARE				20	1						0	0		1	20				SPARE	6	
7	216 C, D				20	1		0	0						1	20				SPARE	8	
9	WIREMOLD 216 C				20	1				0	0				1	20				SPARE	10	
11	SPARE				20	1						0	0		1	20				216	1:	
13	SPARE				20	1		0	0						1	20				SPARE	14	
15	215 A RECEPTACLE				20	1				0	0				1	20				SPARE	16	
17	WIREMOLD 216 C				20	1						0	0		1	20				215, 215 A, 216 C	18	
19	215, 215 A				20	1		0	0						1	20				SPARE	20	
21	SPARE				20	1				0	0				1	20				STAIRWELL LIGHTS (WEST)	22	
23	SPARE				20	1						0	370	NEW	1	20	#12	#12	3/4"	LIGHTING, 2MT1, 2WT1, 2CRA	24	
25	SPARE				20	1		0	0						1	20				216 F RECEPTACLE	26	
27	SPARE				20	1				0	0				1	20				BATHROOM LIGHTS WOMEN	28	
29	WIREMOLD 216 D				20	1						0	0		1	20				216 C, 216 D, SOUTH WALL	30	
31	216 C				20	1		0	0						1	20				216 B RECEPTACLE	32	
33	SPARE				20	1				0	0				1	20				SPARE	34	
35	SPARE				20	1						0	0		1	20				216 E	36	
37	215 A RECPTACLE				20	1		0	0						1	20				SPARE	38	
39	WIREMOLD 216 C1				20	1				0	0				1	20				SPARE	40	
41	215 A RECEPTACLE				20	1						0	0		1	20				SPARE	4:	
		-	CONNEC	TED	РНА	SE	LOAD	0	VA	0	VA	370	VA						241 0111	ATER RANGE AMERICA		
		*F	PHASE D	DIVE	RSIFI	ED	LOAD	0	VA	0	VA	463	VA					•	CALCUL	ATED PANEL AMPS:		
		*F	PHASE D	OIVEF	RSIFI	ED .	AMPS	0	Α	0	Α	4	Α	1						4 A		
										1		Į.	(*	DIVER	SIF	IED L	OAD	S CALC	ULATE	PER THE NATIONAL ELECTRIC	CODE	
OTES	/ACCESSORIES:														IVERSIFIED LOADS CALCULATED PER THE NATIONAL ELECTRIC COD PANEL TOTALS							
	VIDE SPARE 20A, SINGLE-POL	E DDE AVI	EDC INI A		INII IC	ED :	edvee								TOTAL CONNECTED LOAD: 370 VA							

	PANEL NAME:		LO	CATIO	<b>ON</b> : ME	CH B2				٧	OLTAG	<b>E</b> : 120	/208V,	3Ph	, 4W			M	AIN TYPE: MLO		
	"Panel E"			FED I	BY: ""					ENC	LOSUR	E: NEI	MA 1					BUS RA	ATING (A): 400 A		
	BASEMENT PANEL		MO	UNTII	NG: SU	RFACE			M	ANUFA				)	MCB RATING (A): 400 A						
			PANEL TYPE: NQ											MIN. AIC RATING (A): ## kAIC							
кт	LOAD DESCRIPTION	С	w	G	СВР	TYPE		A	ı	В	(	С	TYPE	Р	СВ	G	W	С	LOAD DESCRIPTION	CK	
1	SPACE (EXISTING)				1			0					<b> </b>	3	110				EDC-1 (EXISTING)	2	
3	DDC-1 (EXISTING)				20 1				0	0										4	
,	SPACE (EXISTING)				1							0								6	
•	AHU-1 LIGHTS (EXISTING)				20 1		0	0						3	110				EDC-1 (EXISTING)	8	
)	RECEPTACLE, MACHINE B2A	3/4"	#12	#12	20 1	NEW			180	0										10	
1	NAE PANEL (EXISTING)				20 1						0	0								12	
3	AHU-1 (EXISTING)				125 3		0	0						1	110				AHU-1 GPS (EXISTING)	14	
5									0	180			NEW	1	20	#12	#12	3/4"	RECEPTACLE, ELEVATOR SHAFT	16	
7											0	98	NEW	1	20	#12	#12	3/4"	LIGHTING, ELEVATOR SHAFT	18	
9	AHU-1 (EXISTING)				125 3		0	180					NEW	1	20	#12	#12	3/4"	MACHINE ROOM B2A FCUW1	20	
1									0	46			NEW	1	20	#12	#12	3/4"	MACHINE ROOM B2A LIGHTING	22	
3											0			1					SPACE	24	
5	SPARE (EXISTING)				20 3		0	0						3	20				SPARE (EXISTING)	26	
7									0	0										28	
9											0	0								30	
1	ELEVATOR CAB LIGHTS				20 1		300							1					SPACE (EXISTING)	32	
3	SPACE				1					0				3	60				(EXISTING)	34	
5	SPACE (EXISTING)				1							0								36	
7	(EXISTING)				60 3		0	0												38	
9									0	0				2	20				(EXISTING)	40	
1											0	0								42	
		(	CONNEC	CTED	PHASE	LOAD	480	) VA	406	S VA	98	VA						AL CIII	ATED DANIEL AMDS:		
		*	PHASE [	DIVEF	RSIFIED	LOAD	498	3 VA	421	VA	101	VA					•	ALCUI	LATED PANEL AMPS:		
		*F	PHASE [	DIVER	RSIFIED	AMPS	5	Α	4	Α	1	Α							5 A		
										SIFI	SIFIED LOADS CALCULATED PER THE NATIONAL ELECTRIC CODE.										
T	ES/ACCESSORIES:												J. V L. I V				- 0, (LO	\	PANEL TOTALS		
	OVIDE NEW BREAKERS IN EXIST														-				D LOAD: 984 VA		

### **GENERAL NOTES:**

- ALL ELECTRICAL WORK SHALL BE IN ACCORDANCE WITH THE 2020 NATIONAL ELECTRIC CODE AS ADOPTED BY MISSOURI S&T
- FOR ALL ELECTRICAL QUESTIONS ON THIS PROJECT, CONTACT RTM ENGINEERING CONSULTANTS AT (417) 881-0020. CONTACT: LARRY NEUHAUS.
- FINAL ACCEPTANCE OF WORK SHALL BE SUBJECT TO THE CONDITION THAT ALL SYSTEMS, EQUIPMENT, APPARATUS, AND APPLIANCES OPERATE SATISFACTORILY AS DESIGNED AND INTENDED; WORK SHALL INCLUDE REQUIRED REPLACEMENT, ADJUSTMENT OF SYSTEMS AND CONTROL EQUIPMENT AND ALL REQUIRED PROGRAMMING INSTALLED. PROVIDE FOR ALL WORK INDICATED ON DRAWINGS OR AS REASONABLY
- TEST ALL LINES, SYSTEMS, EQUIPMENT BEFORE THEY ARE INSULATED. PAINTED. OR CONCEALED BY CONSTRUCTION OR BACKFILLING, PROVIDE FUEL. WATER ELECTRICITY MATERIALS LABOR AND EQUIPMENT REQUIRED FOR TESTS. REPAIR OR REPLACE DEFECTS, AND MATERIALS FAILURES REVEALED BY TESTS AND THEN RETESTED UNTIL SATISFACTORY. MAKE REPAIRS WITH NEW MATERIALS.
- PROVIDE NECESSARY MATERIALS AND ACCESSORIES FOR INSTALLATION OF FIXTURES, EQUIPMENT, ETC AS REQUIRED FOR COMPLETE AND FUNCTIONAL OPERATION AS NOTED ON DRAWINGS OR IN NOTES.
- ACCESS PANELS SHALL BE PROVIDED WHEREVER NECESSARY TO PROVIDE ACCESS TO VALVES, JUNCTION BOXES, ETC., LOCATED IN CONCEALED SPACES.
- ALL EQUIPMENT, FIXTURES, MATERIALS, ETC SHALL BE INSTALLED IN NEAT. PROFESSIONAL MANNER IN ACCORDANCE WITH MANUFACTURER RECOMMENDATIONS.
- THE CONTRACTOR SHALL VERIFY ALL EXISTING CONDITIONS PRIOR TO SUBMITTING BID. NO EXTRAS WILL BE PAID DUE TO UNANTICIPATED EXISTING
- THE CONTRACTOR SHALL SCHEDULE AND EXECUTE ALL WORK WITH REGARD TO THE OWNER'S USE OF THE
- PLANS ARE DIAGRAMMATIC AND SHALL NOT BE SCALED. REFER TO ARCHITECTURAL DRAWINGS FOR DIMENSIONS
- REFER TO ARCHITECTURAL DRAWINGS FOR TYPICAL ROOM INTERIOR ELEVATIONS. COORDINATE EXACT DEVICE LOCATIONS AND MOUNTING HEIGHTS WITH ARCHITECT PRIOR TO COORDINATE ALL WIRING DEVICE LOCATIONS
- SHOWN AT MILLWORK LOCATIONS WITH THE MILLWORK CONTRACTOR AND GENERAL CONTRACTOR PRIOR TO ANY ROUGH-IN OR INSTALLATION. ALL WIRING DEVICES SHALL BE INSTALLED IN ACCESSIBLE LOCATIONS AND SHALL NOT BE CONCEALED.
- PROVIDE PULL BOXES AS REQUIRED TO PROPERLY INSTALL THE RACEWAYS AND CIRCUITS INDICATED. ALL EMPTY CONDUITS SHALL BE PROVIDED WITH ROT-PROOF PULL-TAPE, LABELED AT EACH END. ALL CONDUITS SHALL BE PROVIDED WITH PLASTIC BUSHINGS WHERE TERMINATED OPEN-ENDED.
- EACH CONTRACTOR AND SUB-CONTRACTOR OR TRADE SHALL REVIEW THE BID DOCUMENTS AS A WHOLE, INCLUDING ALL OTHER TRADES' DRAWINGS AND PROVIDE ANY MISC. ITEMS, MATERIALS, WORK, ETC. REQUIRED TO COMPLETE THE WORK AS SHOWN ON ALL BID DOCUMENTS. THIS REQUIREMENT APPLIES TO ALL TRADES, STRUCTURAL, MECHANICAL, ELECTRICAL, PLUMBING, EQUIPMENT VENDORS, ETC. REQUIREMENTS AND RELATED WORK ARE INDICATED THROUGHOUT THE BID DOCUMENTS AND SHALL BE REVIEWED WITH THE SPECIFIC MEP. STRUCTURAL, ARCHITECTURAL, AND EQUIPMENT DRAWINGS FOR OVERALL SCOPE OF WORK.
- ELECTRICAL CONTRACTOR SHALL PROVIDE FINAL CONNECTION TO ALL MECHANICAL EQUIPMENT. WHERE EQUIPMENT IS SHOWN ON THE MECHANICAL PLANS, BUT NOT SHOWN ON THE ELECTRICAL PLANS, ELECTRICAL CONTRACTOR SHALL PROVIDE POWER TO THE EQUIPMENT BASED ON EQUIPMENT REQUIREMENTS AND INCLUDE ALL COSTS IN THE BASE BID.
  - LOCATION SHOWN OF ELECTRICAL CONNECTION TO MECHANICAL EQUIPMENT IS SCHEMATIC AND MAY NOT REFLECT ACTUAL CONNECTION POINTS. ROUGH-IN AND CONNECTION TO EQUIPMENT SHALL BE PER THE EQUIPMENT MANUFACTURER'S REQUIREMENTS AND THE NATIONAL ELECTRICAL CODE PROVIDE STRUCTURAL SUPPORTS AS REQUIRED FOR MOUNTING OF DISCONNECTING MEANS VERIEVALL ROUGH-IN REQUIREMENTS WITH THE MECHANICAL CONTRACTOR AND EQUIPMENT MANUFACTURER PRIOR TO ANY
- PROVIDE FINAL CONNECTION TO ALL EQUIPMENT, INCLUDING ANY CORD AND PLUG SETS FOR EQUIPMENT NOT PROVIDED WITH IT (WHETHER SPECIFICALLY NOTED OR NOT). COORDINATE ALL WORK WITH THE EQUIPMENT SUPPLIÉR AND OWNER; AND VERIFY ALL ROUGH-IN LOCATIONS AND REQUIREMENTS PRIOR TO ANY ROUGH-
- THERMOSTATS AND ALL ASSOCIATED LOW VOLTAGE CONTROL WIRING SHALL BE SUPPLIED AND INSTALLED BY THE HVAC CONTRACTOR THE FLECTRICAL CONTRACTOR SHALL FURNISH AND INSTALL THE NECESSARY CONDUIT, BOXES, ETC. FOR THE INSTALLATION OF THERMOSTATS. THE HVAC CONTRACTOR SHALL BE RESPONSIBLE FOR THE INSTALLATION AND CONNECTION OF THE THERMOSTATS AND ALL CONTROL WIRING. REFER TO MECHANICAL PLANS FOR THERMOSTAT LOCATIONS.
  - PROVIDE BACK BOX AND CONDUIT TO ACCESSIBLE CEILING AS REQUIRED FOR THE DIVISION 23 WALL MOUNTED CONTROL DEVICES FOR BUILDING AUTOMATION SYSTEM DEVICES. COORDINATE EXACT LOCATIONS AND OTHER REQUIREMENTS WITH MECHANICAL DRAWINGS AND THE TEMPERATURE CONTROLS CONTRACTOR PRIOR TO ROUGH-IN. THERMOSTATS TEMPERATURE SENSORS STATIC PRESSURE SENSORS, HUMIDISTATS ETC. SHALL BE INSTALLED AT THE SAME ELEVATION AS THE LIGHT SWITCHES UNLESS REQUIRED OTHERWISE.
  - PROVIDE UNSWITCHED/UNCONTROLLED HOT FROM ROOM LIGHTING CIRCUIT TO NIGHT LIGHT FIXTURES, EXIT SIGNS AND EMERGENCY FIXTURES WITH INTEGRAL
  - PROVIDE A SEPARATE CODE SIZED GREEN EQUIPMENT GROUND CONDUCTOR IN ALL CONDUITS AND RACEWAYS CONTAINING LINE VOLTAGE CIRCUITS (120V OR HIGHER).
- PROVIDE ALL RACEWAYS, SLEEVES, BOXES, CABLE TRAY FTC AS INDICATED FOR THE OWNER PROVIDED. DATA, PHONE, TV CABLING SYSTEM. COORDINATE EXACT REQUIREMENTS WITH OWNER AND OWNER CABLING CONTRACTOR
- COORDINATE EXACT ROUTE FOR ALL COMMUNICATIONS SYSTEM RACEWAYS AND PULL BOX LOCATIONS WITH THE OWNER AND CABLING CONTRACTOR.
- REFER TO ARCHITECTURAL EQUIPMENT DRAWINGS FOR EXACT LOCATIONS OF EQUIPMENT. COORDINATE EXACT REQUIREMENTS WITH EQUIPMENT SUPPLIER.
- NEUTRALS SHALL NOT BE SHARED FOR ANY CIRCUIT. UNLESS SPECIFICALLY NOTED ON PLANS.

### **GENERAL NOTES:**

- INSTALL ALL SWITCHBOARDS, PANELBOARDS, TRANSFORMERS, CONTACTORS, AND ASSOCIATED CONDUIT AND SUPPORT SYSTEMS IN THE FLECTRICAL ROOMS IN A MANNER AND LOCATION TO ACCOMMODATE THE INSTALLATION OF ALL FUTURE PANELBOARDS INDICATED IN THE DRAWINGS. COORDINATE THE FUTURE PANEL BOARD LOCATIONS AND THEIR ASSOCIATED FUTURE REQUIREMENTS WITH ALL OTHER DIVISIONS. MAINTAIN SUFFICIENT PHYSICAL SPACE FOR THE FUTURE INSTALLATION AS WELL AS THE NECESSARY CLEAR WORKING SPACE, HEADROOM, DEDICATED EQUIPMENT SPACE, AND ANY OTHER REQUIRED CLEARANCES.
- PROVIDE FINAL CONNECTION OF POWER AND ASSOCIATED CONTROL CIRCUITS FOR ALL ELEVATOR EQUIPMENT. COORDINATE ALL WIRING REQUIREMENTS WITH THE ELEVATOR EQUIPMENT PROVIDER PRIOR TO ANY ROUGH-IN. COORDINATE EXACT LOCATION OF ALL EQUIPMENT. RECEPTACLES AND WIRING DEVICES IN TH FLEVATOR SHAFT PIT AND MACHINE ROOM WITH THE
  - WIRE SIZE INDICATED BY BRANCH CIRCUIT AT HOMERUN SHALL BE CARRIED THROUGHOUT THE CIRCUIT TO FINAL CONNECTION AT EQUIPMENT. FINAL EXTENSION OF CIRCUIT TO EQUIPMENT MAY NOT BE SHOWN FOR CLARITY BUT IS THE RESPONSIBILITY OF THE ELECTRICAL CONTRACTOR FOR FINAL CONNECTION.

ELEVATOR EQUIPMENT SUPPLIER PRIOR TO ANY ROUGH-

- AT ALL FAN COIL UNITS, ELECTRICAL CONTRACTOR SHALL BE RESPONSIBLE FOR MAKING THE FINAL CONNECTION OF POWER FROM THE FAN COIL CIRCUIT TO ANY CONDENSATE PUMPS OR FLOAT SWITCHES INSTALLED IN ALIXILIARY DRAIN PANS, POWER WIRING SHOULD BE TAPPED DOWNSTREAM OF THE EQUIPMENT DISCONNECT SWITCH SO THAT ALL POWER IS DISCONNECTED AT THE UNIT WHEN THE SWITCH IS IN THE 'OFF' POSITION. COORDINATE ALL ROUGH-IN REQUIREMENTS WITH THE MECHANICAL CONTRACTOR AND EQUIPMENT MANUFACTURER PRIOR TO ANY ROUGH-IN.
- REFER TO THE MECHANICAL DRAWINGS FOR EXACT LOCATIONS AND QUANTITY OF ALL MECHANICAL EQUIPMENT AND FIRE/SMOKE AND/OR SMOKE DAMPERS. LOCATIONS AND QUANTITY SHOWN ON THE ELECTRICAL DRAWINGS ARE APPROXIMATE AND MAY NOT REFLECT FINAL POSITION OR QUANTITY, ELECTRICAL CONTRACTOR SHALL PROVIDE FINAL CONNECTION TO ALL MECHANICAL FOLIPMENT WHERE FOLIPMENT IS SHOWN ON THE MECHANICAL PLANS BUT NOT SHOWN ON THE ELECTRICAL PLANS. ELECTRICAL CONTRACTOR SHALL PROVIDE POWER TO THE EQUIPMENT BASED ON EQUIPMENT REQUIREMENTS AND INCLUDE ALL COSTS IN THE BASE BID. LOCATION SHOWN OF ELECTRICAL CONNECTION TO MECHANICAL EQUIPMENT IS SCHEMATIC AND MAY NOT REFLECT ACTUAL CONNECTION POINTS. ROUGH-IN AND CONNECTION TO EQUIPMENT SHALL BE PER THE EQUIPMENT MANUFACTURER'S REQUIREMENTS AND THE NATIONAL ELECTRICAL CODE. PROVIDE STRUCTURAL SUPPORTS AS REQUIRED FOR MOUNTING OF DISCONNECTING MEANS. VERIFY ALL ROUGH-IN REQUIREMENTS WITH THE MECHANICAL CONTRACTOR AND EQUIPMENT MANUFACTURER PRIOR TO ANY ROUGH-IN.
- PROVIDE CONTACTOR IN A NEMA 1 ENCLOSURE AND FIRE ALARM FAN SHUT DOWN RELAY/CONTROL MODULE AND INTERLOCK WITH THE FIRE ALARM SYSTEM AT EACH FAN-POWERED BOX OR FAN TERMINAL UNIT TO SHUT OFF POWER TO THE UNIT UPON DETECTION OF SMOKE BY THE AREA SMOKE DETECTION SYSTEM OR BY THE DUCT DETECTOR IN THE RETURN AIR OF THE ASSOCIATED AIR HANDLING UNIT. LOCATE CONTACTOR ABOVE THE CEILING ADJACENT TO EACH FAN COIL UNIT. COORDINATE WITH FIRE ALARM CONTRACTOR FOR PROPER COIL VOLTAGE AND CONTROL. REFER TO MECHANICAL SCHEDULES AND POWER PLANS FOR CONTACTOR AMPACITY AND POLE QUANTITY. REFER TO SPECIAL SYSTEMS PLANS FOR ADDITIONAL COORDINATION.
- SUPPORTS, CONDUIT, BOXES, ETC. INSTALLED IN AREAS WITH EXPOSED STRUCTURE SHALL BE PAINTED TO MATCH ADJACENT FINISHES.
- CONTRACTOR RESPONSIBLE FOR ALL PATCH AND REPAIR OF EXISTING SURFACES AS REQUIRED FOR INSTALLATION OF NEW DEVICES. REMOVE AND REPLACE DEVICE ON EXISTING WALL AS NEEDED FOR NEW FINISHES. PROVIDE DETENTION RINGS WHERE
- CONTRACTOR SHALL PROVIDE PANEL AND CIRCUIT NUMBER DESIGNATION ON ALL RECEPTACLES NEW AND
- CONTRACTOR SHALL PROVIDE UPDATED TYPED LABELS AND PANELBOARD SCHEDULES FOR IMPACTED CIRCUITS AND PANELBOARDS.

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STATE OF MISSOURI

CERTIFICATE OF AUTHORITY

#2014035826

FOR ENGINEERING

E-2001018772

CTURE, LLC AND SHALL BE USED ONLY FOR THE PROJECT REFERENCE BELOW

REVISION SCHEDULE

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> PROJECT ENGINEER: Approver DRAWN BY: CHECKED BY:


PROJECT NUMBER: 22-703A

RC000638

8.28.2023

**ELECTRICAL DETAILS &** SCHEDULES

SHEET NUMBER:

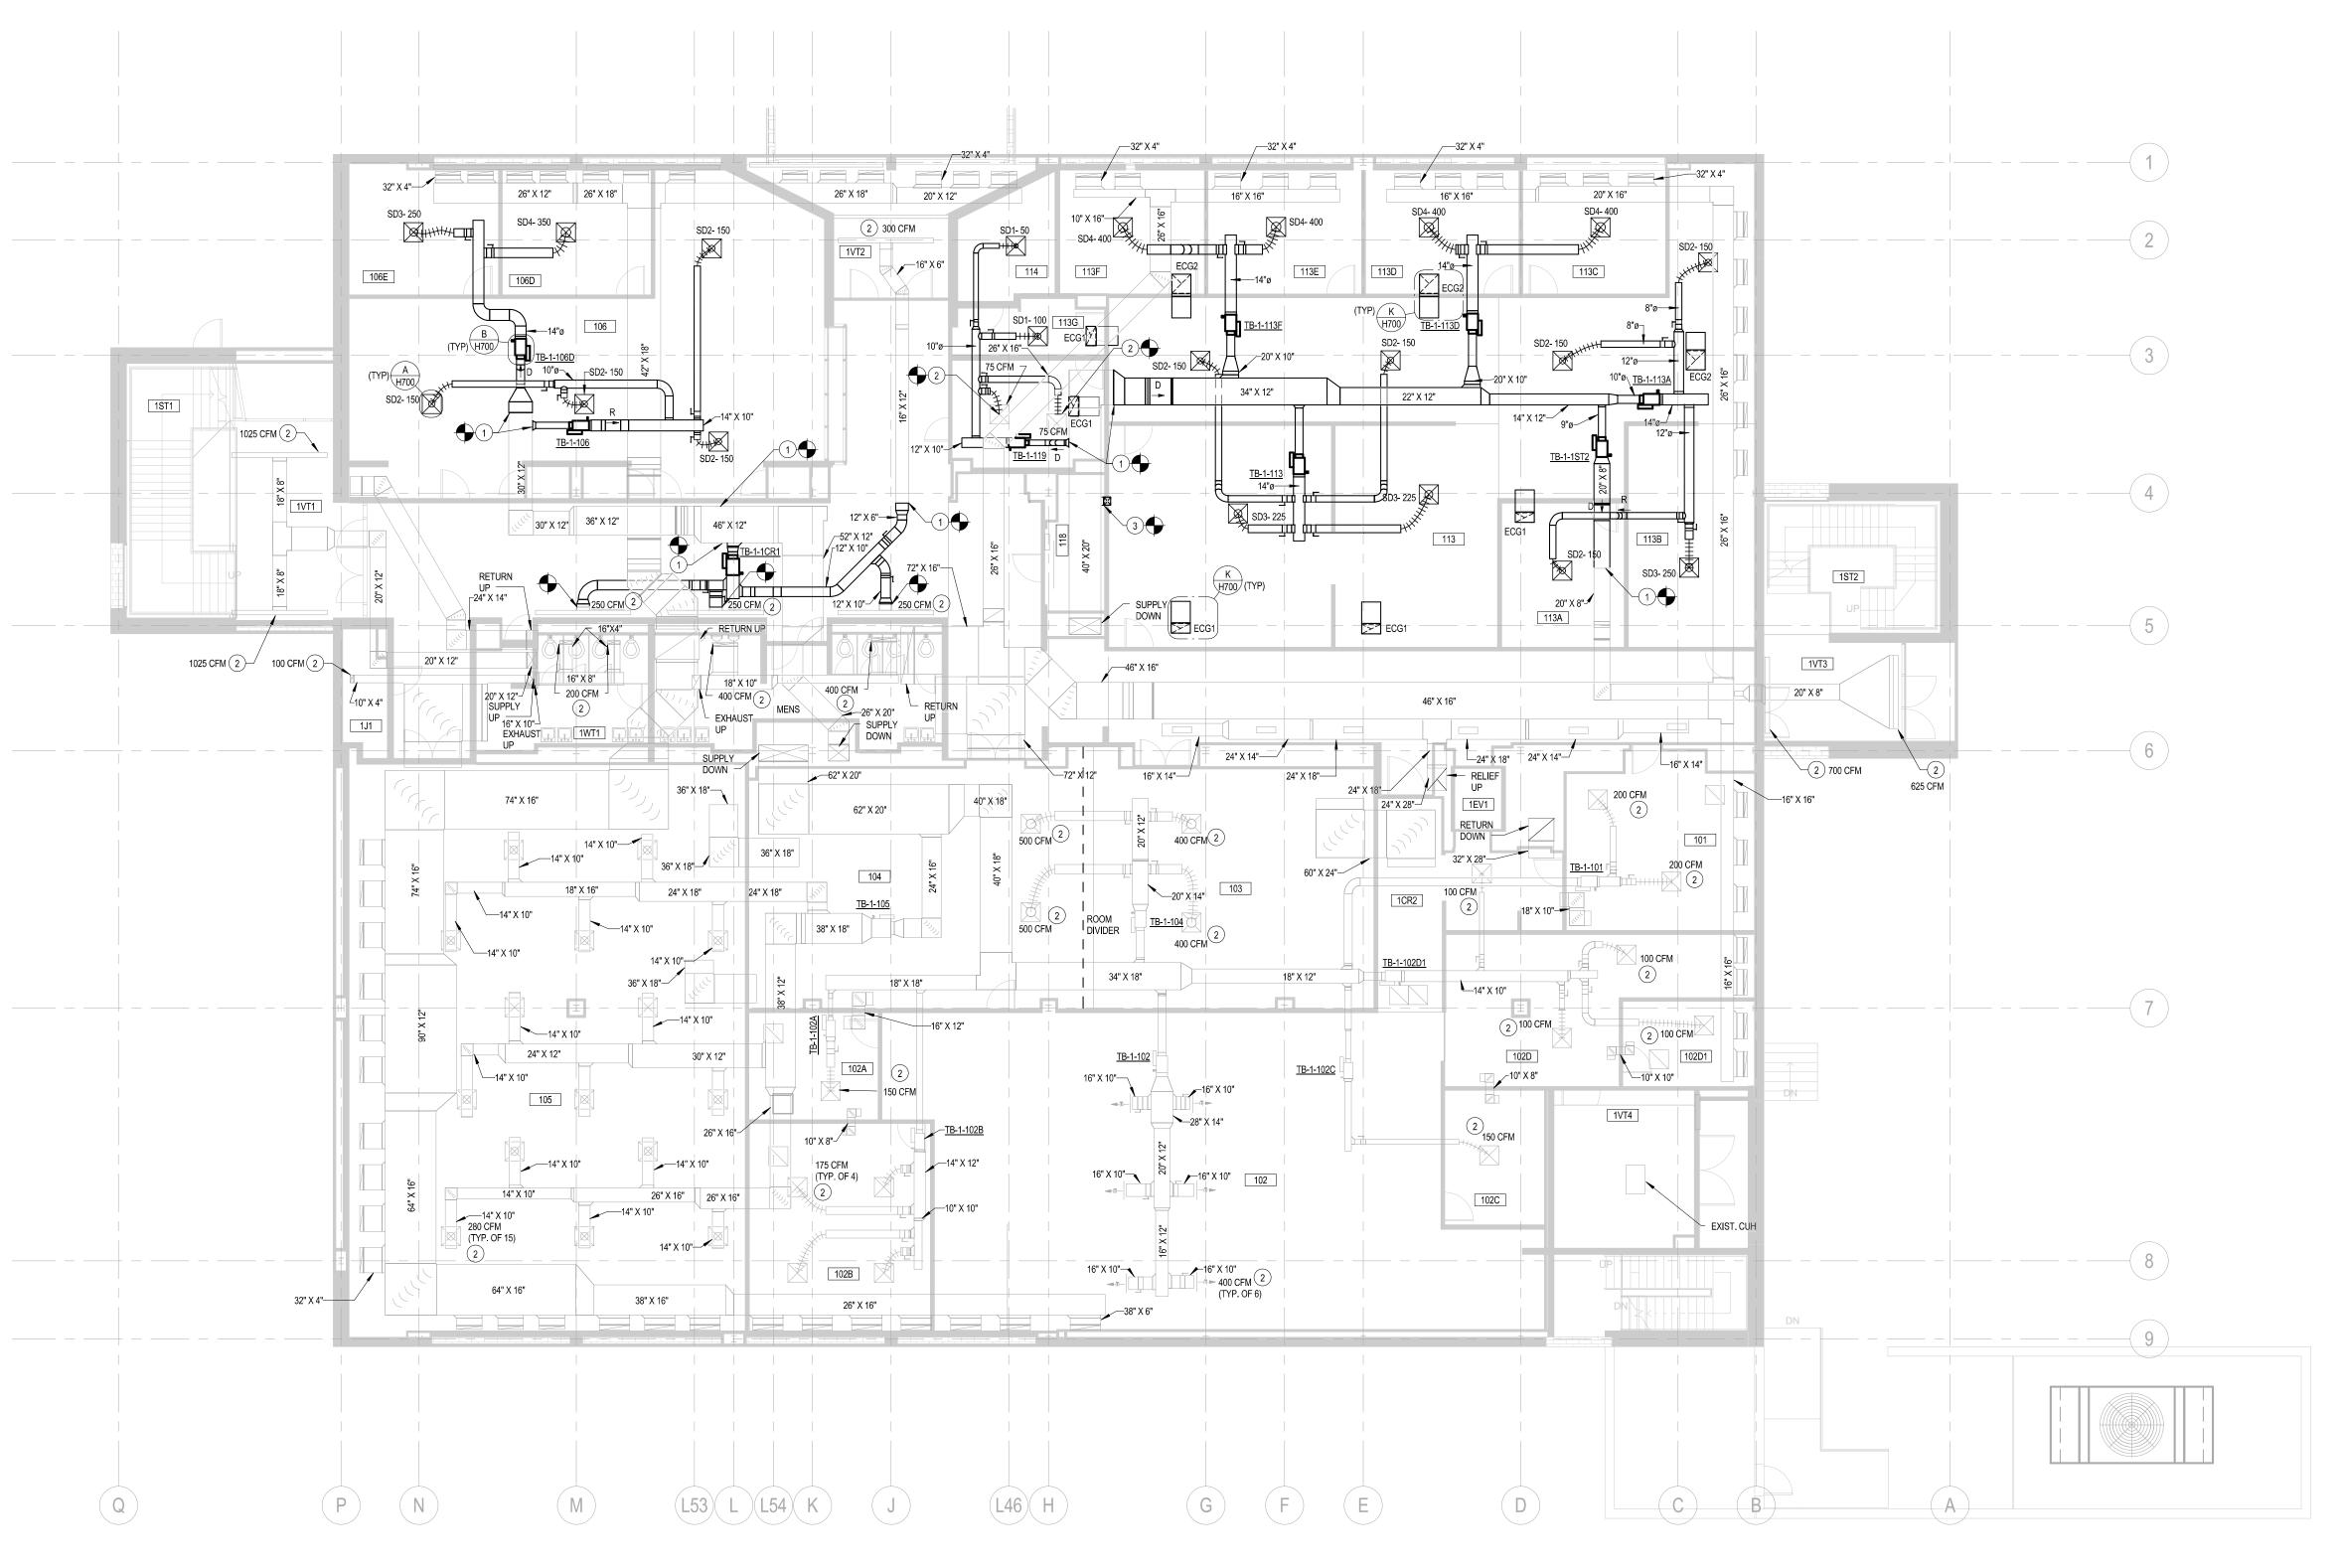

1) FIRST FLOOR HVAC PLAN 1/8" = 1'-0"

### **GENERAL NOTES:**

- A. REFER TO DIFFUSER SCHEDUEL FOR DUCT RUNOUT SIZES TO DIFFUSERS.
  B. REFER TO TERMINAL BOX SCHEDULE FOR DUCT RUNOUT SIZES TO TERMINAL
- C. REFER TO EXISTING TERMINAL BOX SCHEDULE FOR OVERALL NEW BALANCED
- CFM.

  D. INSTALL TERMINAL BOXES NO GREATER THAN 24" ABOVE CEILING.

  E. AT CONTRACTOR'S DISCRETION, ROUND OR RECTANGULAR DUCTWORK MAY BE UTILIZED GIVEN SPATIAL CONDITIONS ABOVE CEILING.
- H201 PLAN NOTES

  1 CONNECT NEW SUPPLY DUCT TO EXISTING SUPPLY DUCT.
- 2 BALANCE EXISTING DIFFUSER/GRILLE TO CFM SHOWN.
- 3 10" X 8" SUPPLY DUCT OUT SIDE OF 40" X 20", ELBOW DUCT DOWN INTO TELECOM ROOM TO 8' A.F.F. INSTALL BALANCING DAMPER IN DUCT DROP AND EXTERNALLY INSULATE DUCT. TERMINATE DUCT WITH EMG AND BALANCE TO




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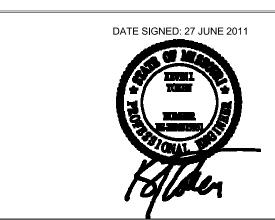
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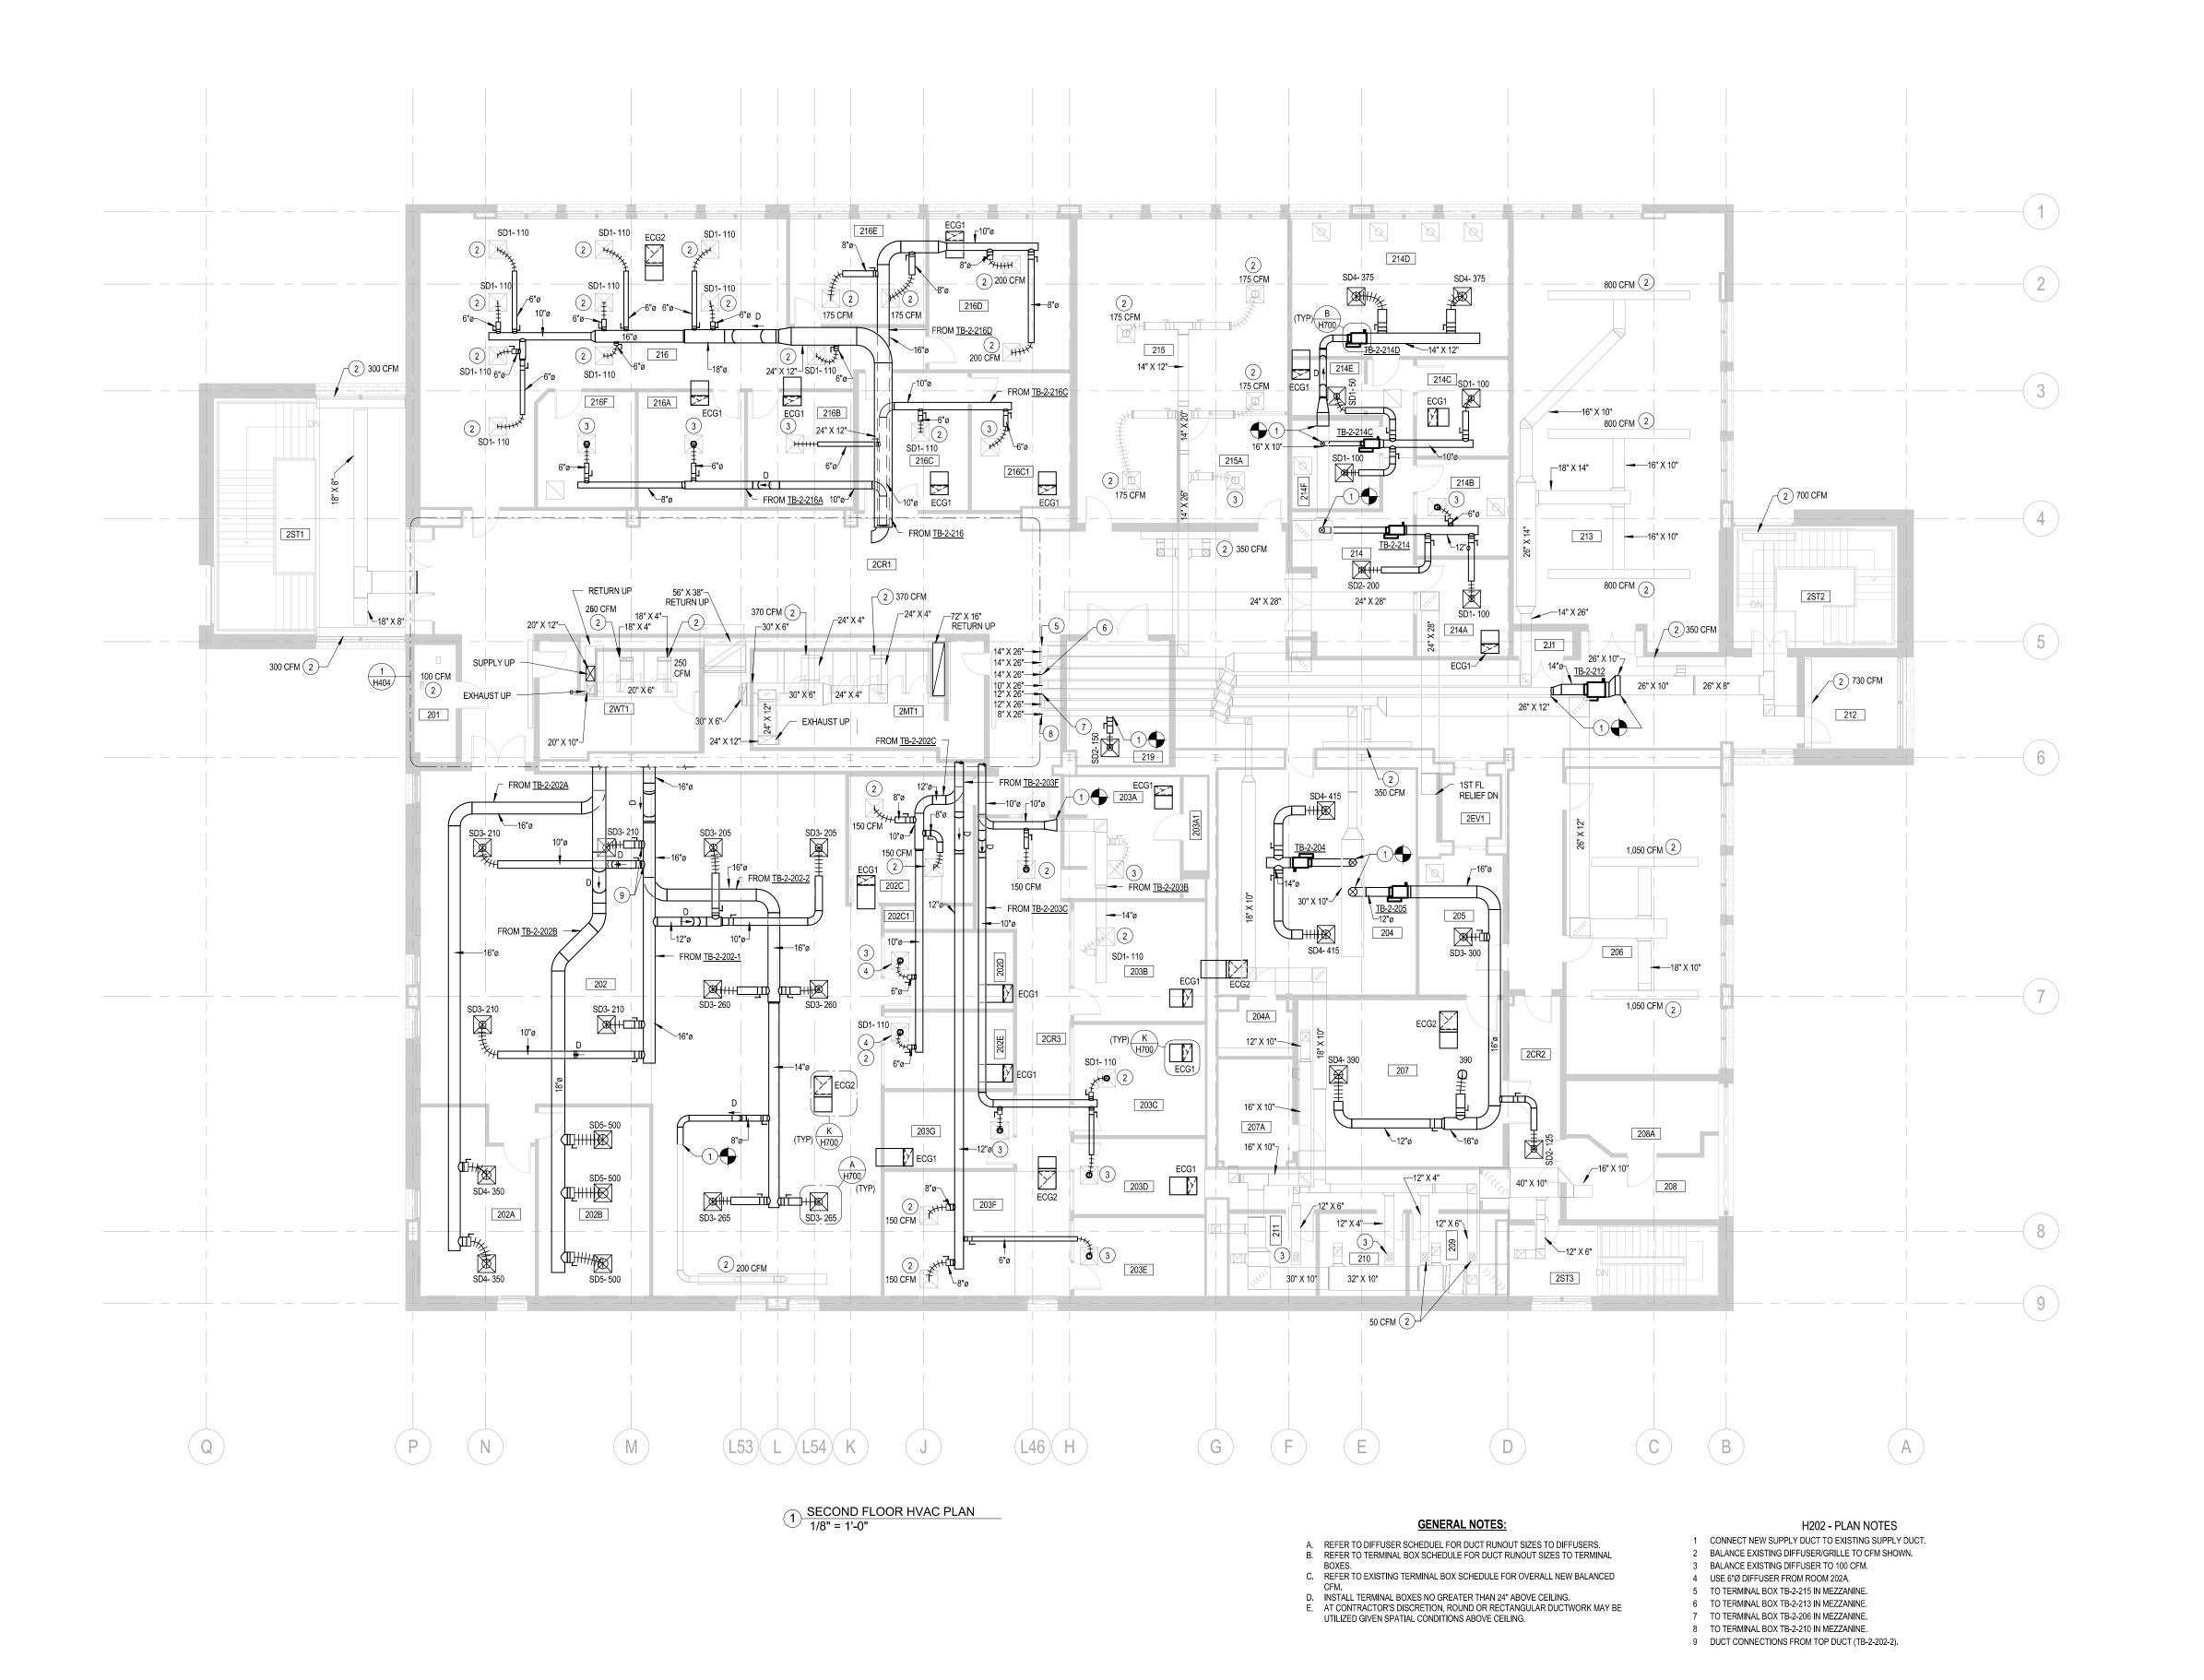
KEYPLAN

MARK DATE DESCRIPTION



FIRST FLOOR HVAC PLAN

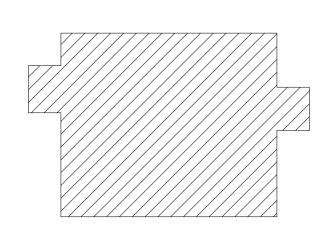SCALE As indicated	CLIENT NO. 088
DATE 05 JULY 2011	PROJECT NO. 0884000
COORD TAW	_
DRAWN TAW	- H201
APPROVED KJT	1 120 1
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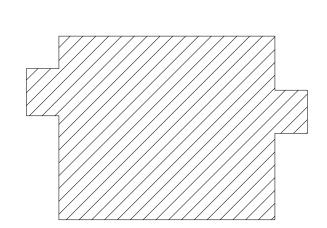


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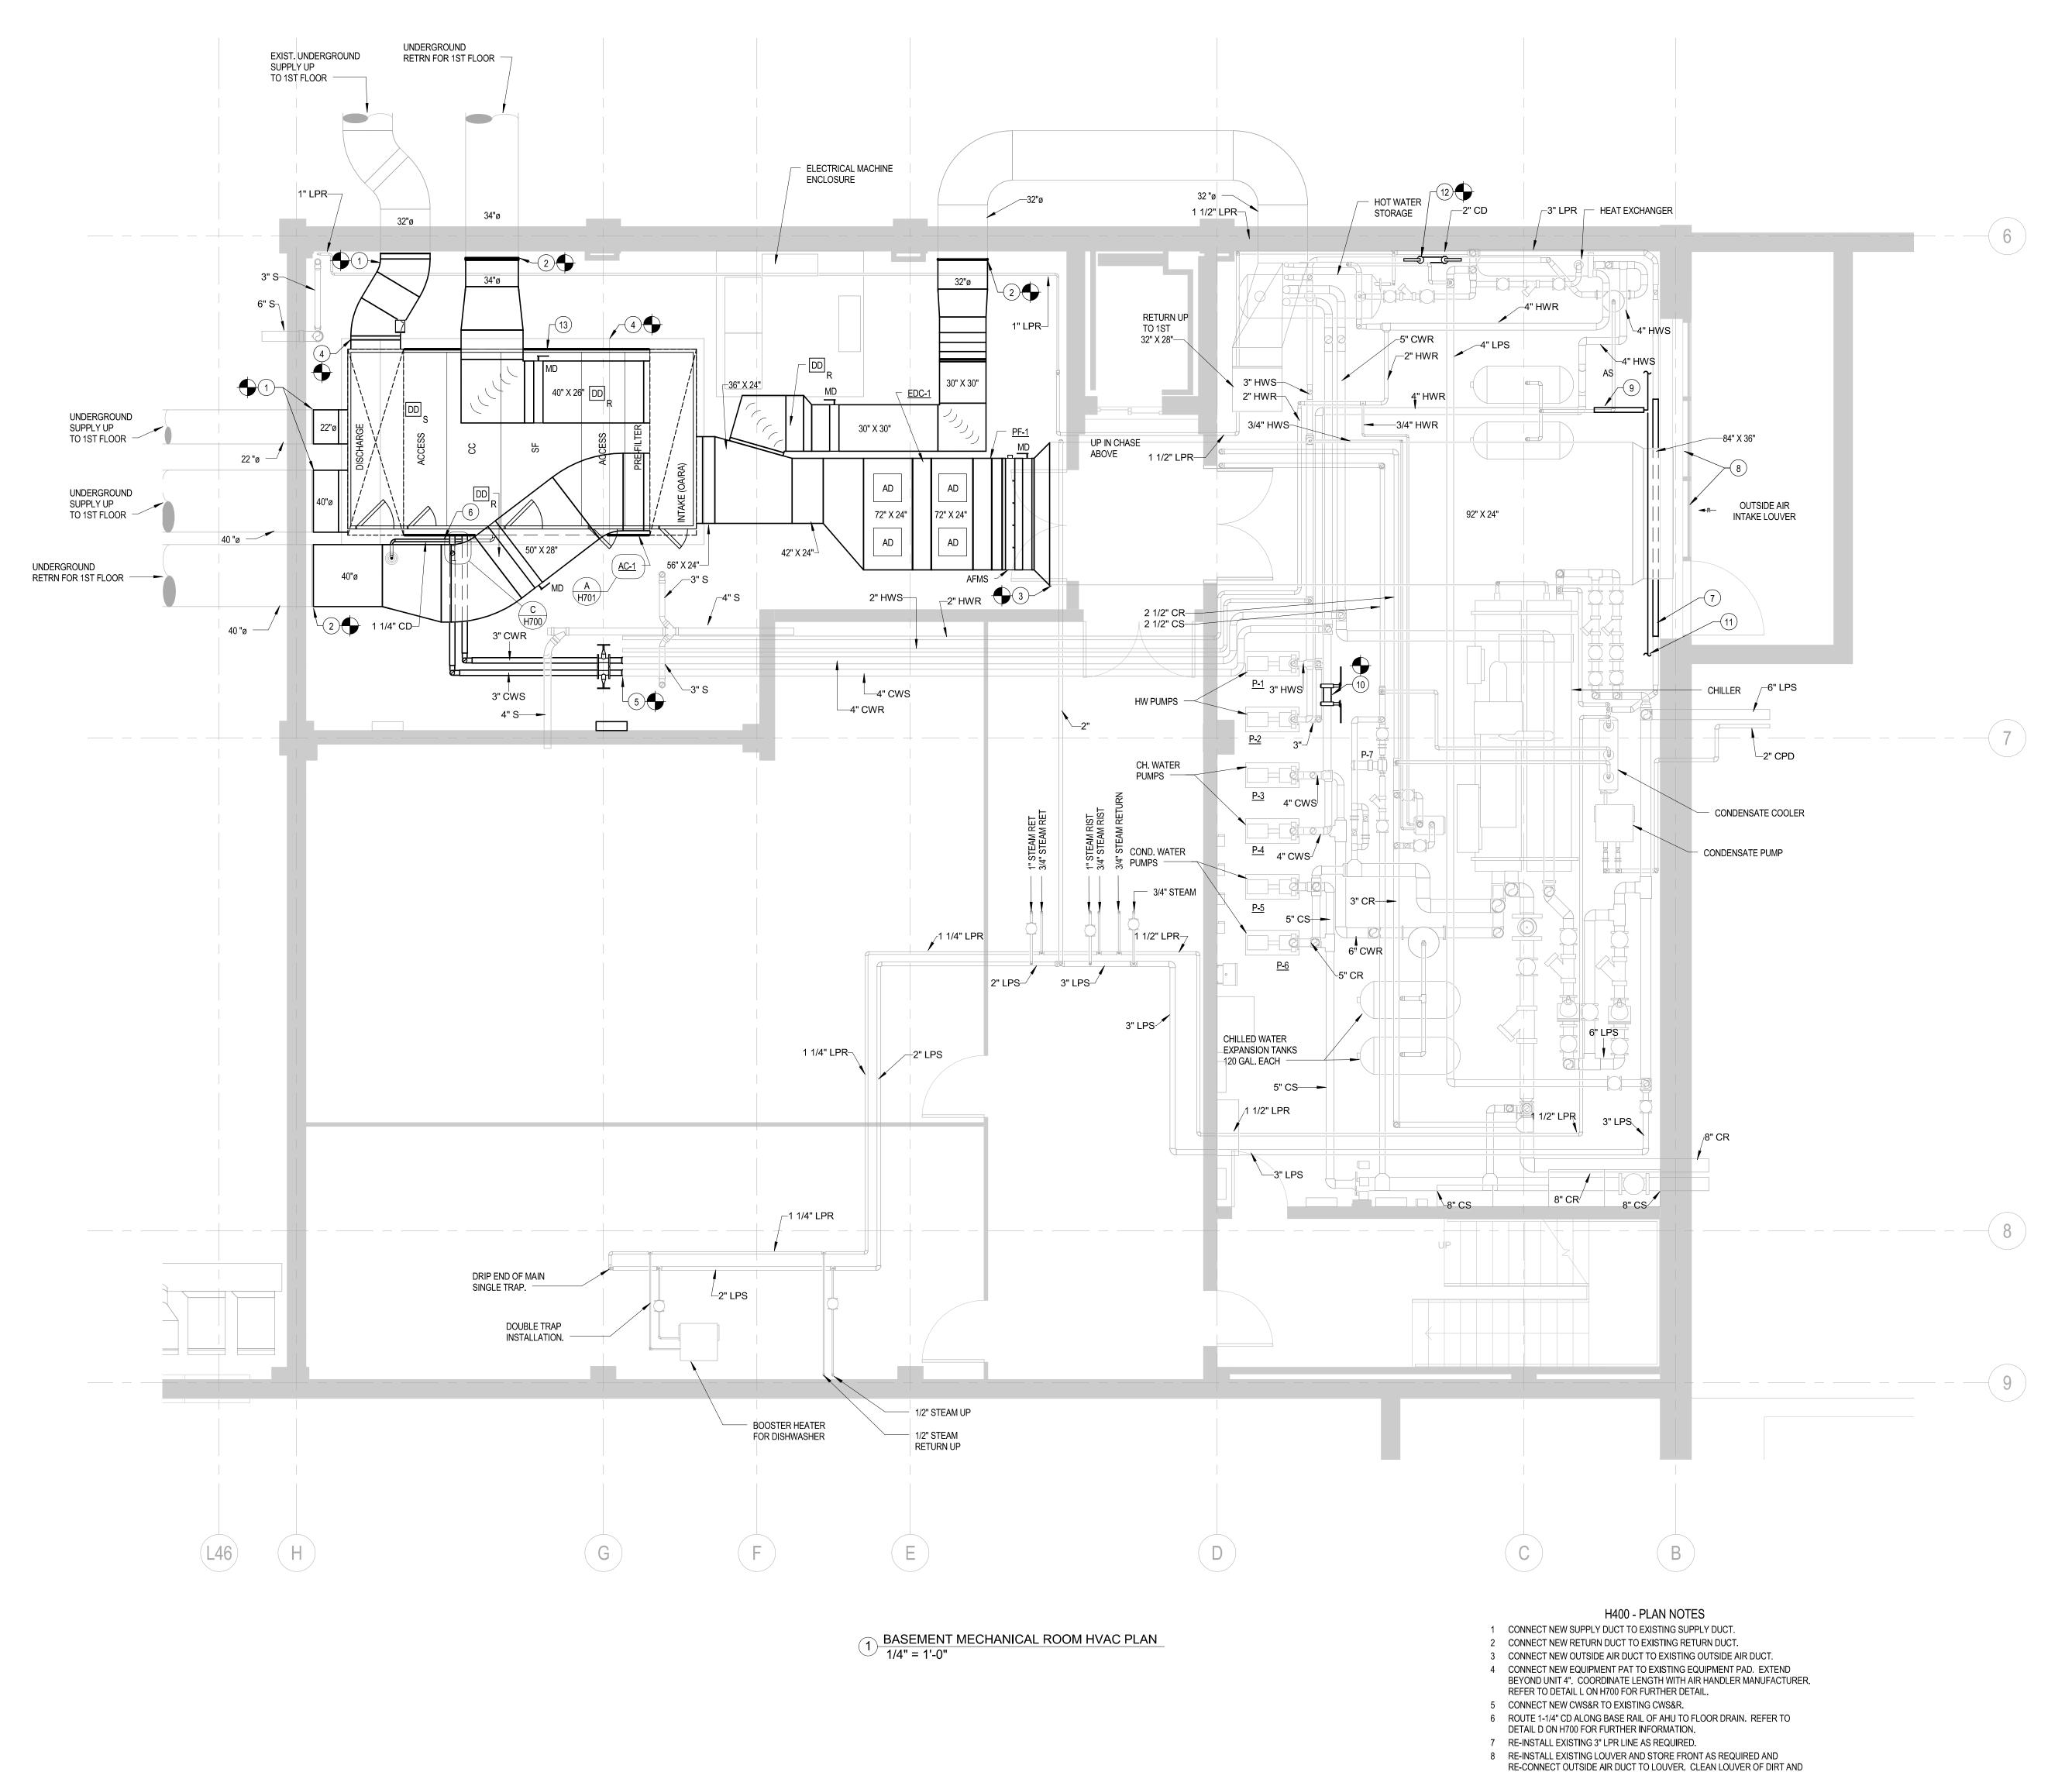
KEYPLAN

MARK DATE DESCRIPTION



## SECOND FLOOR HVAC PLAN

SCALE As indicated	CLIENT NO. 088
DATE 05 JULY 2011	PROJECT NO. 0884000
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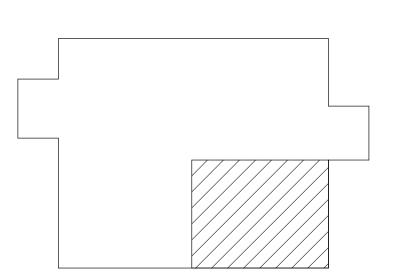
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MARK DATE DESCRIPTION



# BASEMENT MECHANICAL ROOM HVAC PLAN

9 RE-INSTALL EXISTING HEAT EXCHANGER AND PIPING AS REQUIRED.
 10 CONNECT NEW CHILLED WATER FLOW METER TO EXISTING CWS. PROVIDE

12 CONNECT NEW HOT WATER FLOW METER TO EXISTING HWS. PROVIDE NEW SHUT OFF VALVES TO ISOLATE FLOW METER. FILED VERIFY LOCATION.


NEW SHUTOFF VALVES TO ISOLATE FLOW METER.

13 AC-1 EQUIPMENT AND INSTALLATION UNDER ALTERNATE BID.

11 RE-CONNECT EXISTING 1-1/2" MPR.

0884	CLIENT NO.	CALE 1/4" = 1'-0"
08840003	PROJECT NO.	ATE 05 JULY 2011
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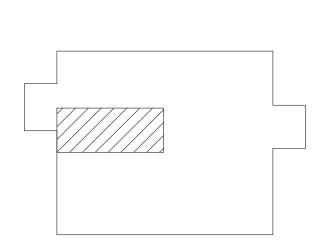


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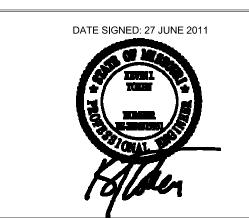
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PROJECT # 111744

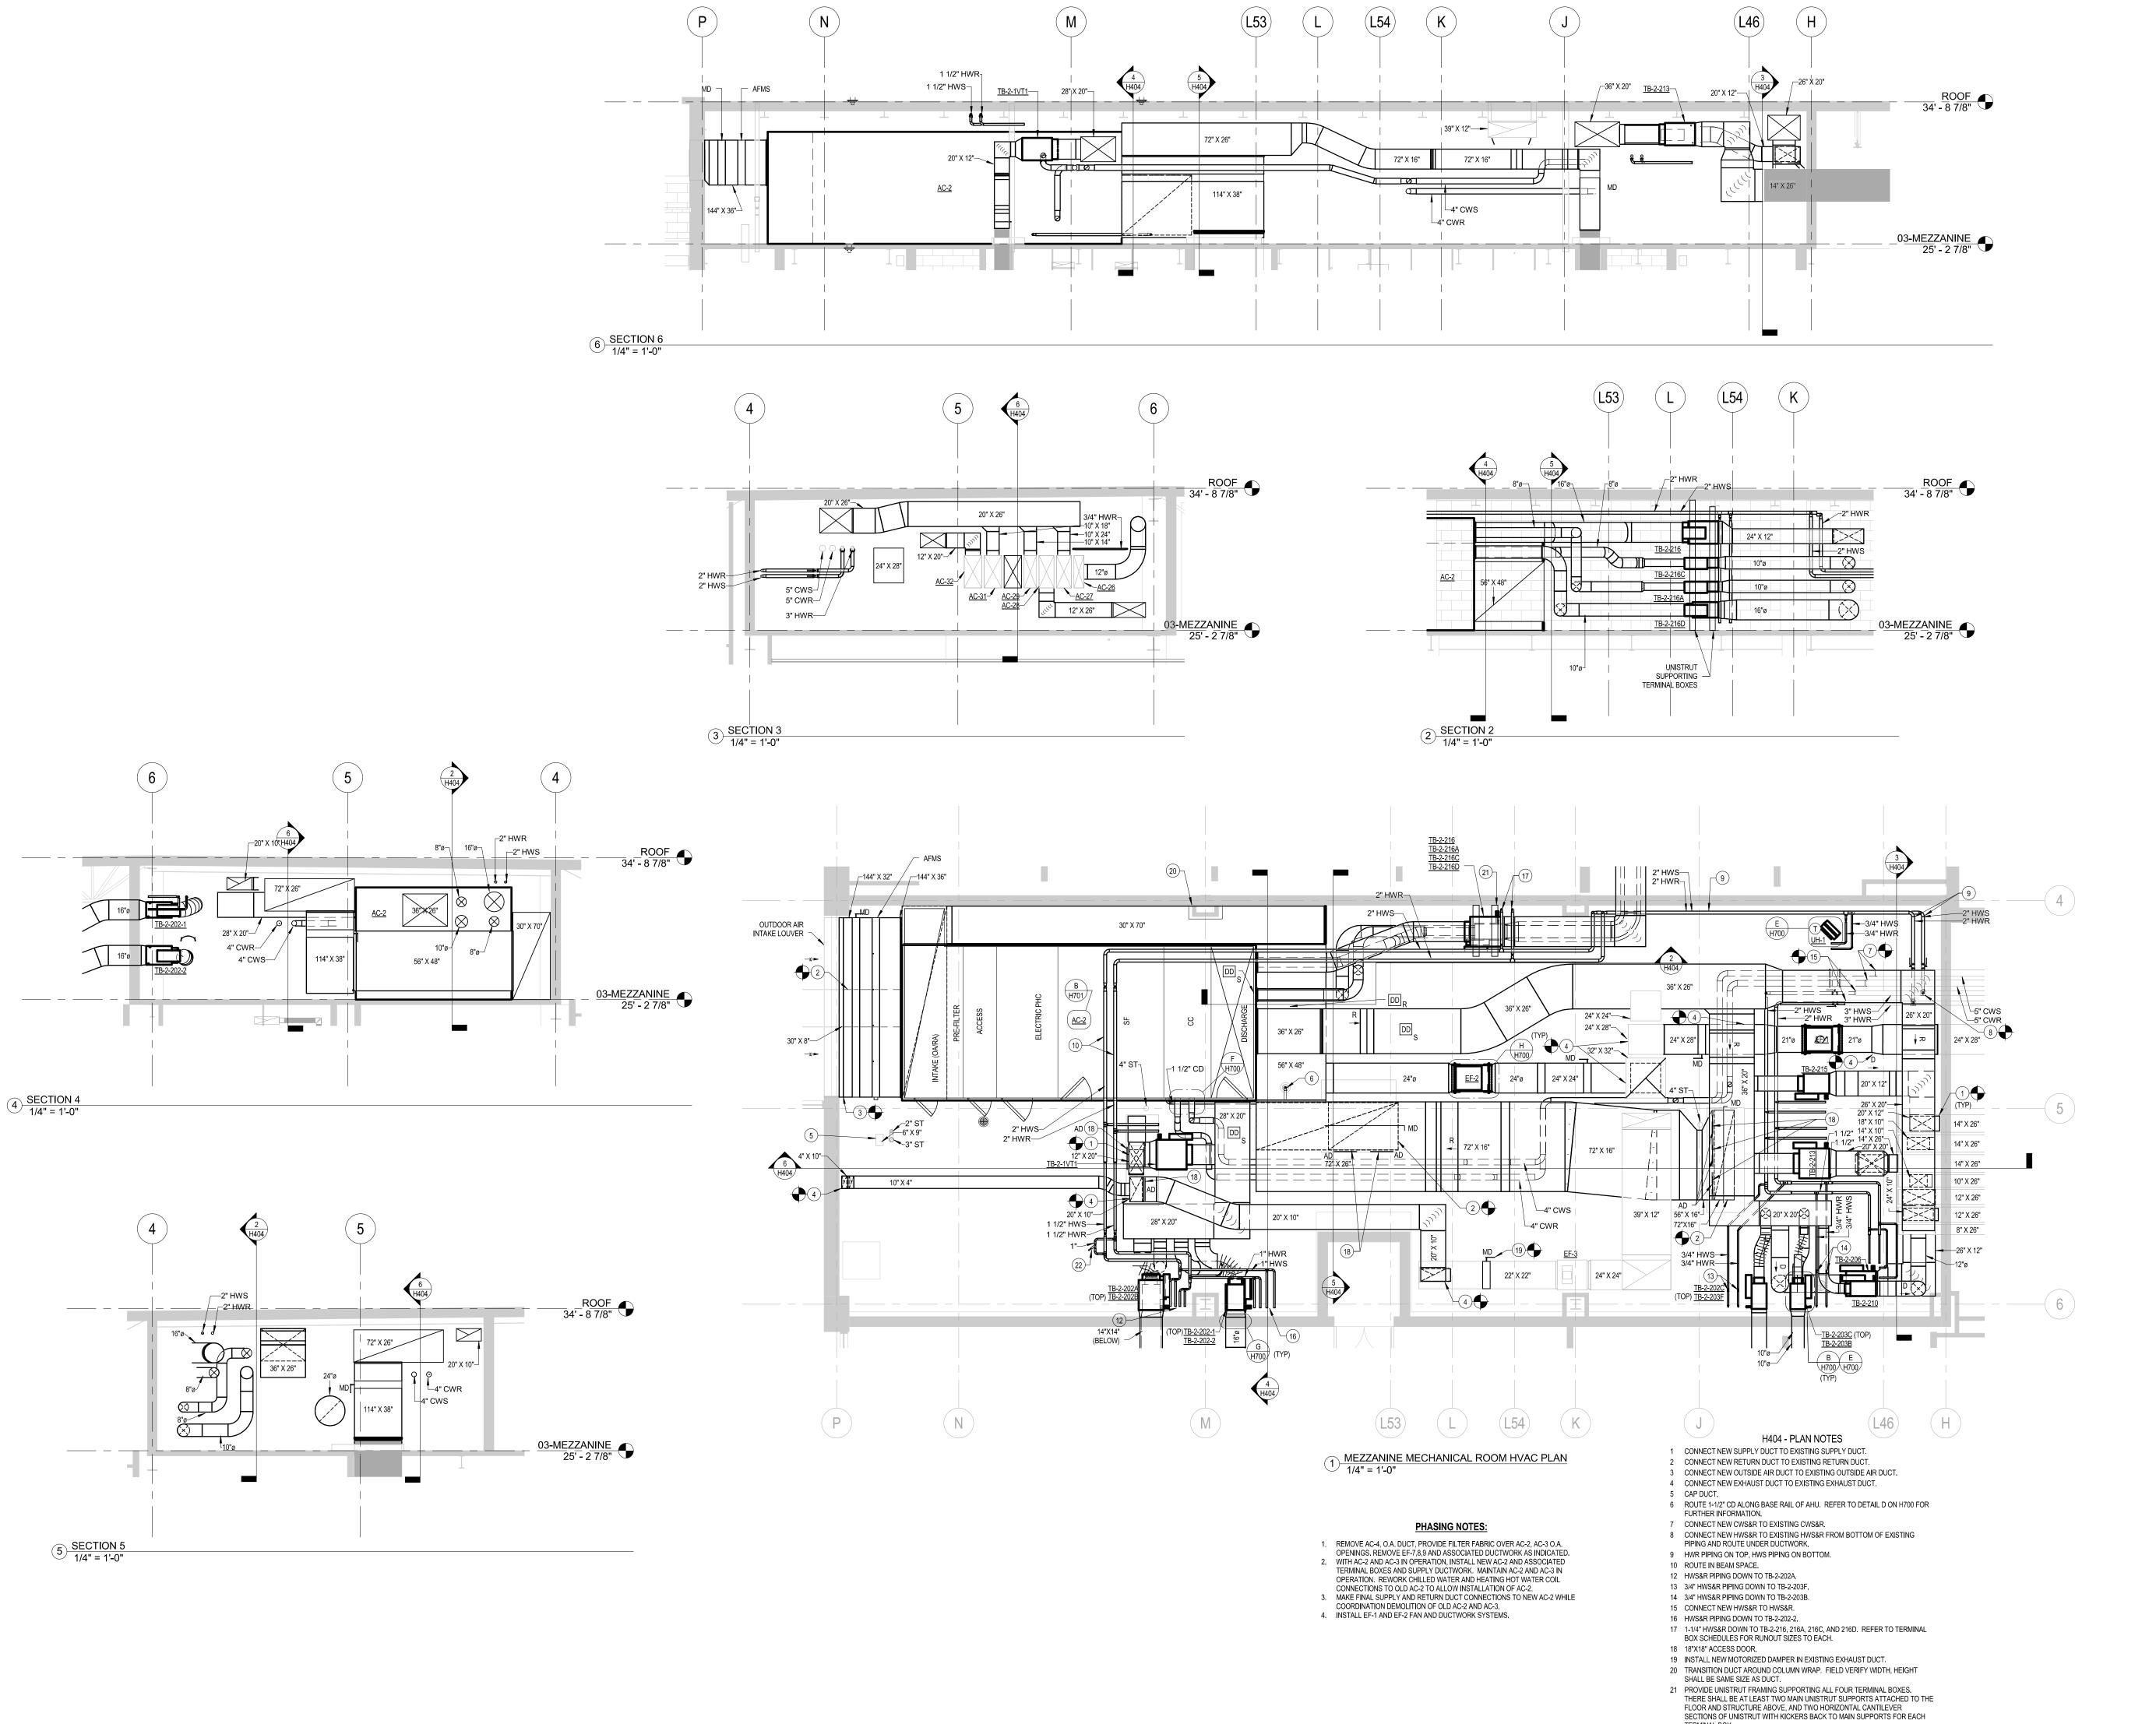

KEYPLAN

MARK DATE DESCRIPTION



### MEZZANINE MECHANICAL ROOM HVAC PLAN

SCALE As indicated	CLIENT NO.	0884
DATE 05 JULY 2011	PROJECT NO.	08840003
COORD TAW	_	
DRAWN TAW	H404	
APPROVED <b>KJT</b>		
FILE NAME		

22 MINIMUM FLOW BYPASS CALIBRATED BALANCE VALVE FOR 5 GPM.