REPLACE 5 BASIC SITES WITH 5 PREMIUM YURTS TABLE ROCK STATE PARK BRANSON, MISSOURI

OWNERS: STATE OF MISSOURI

MICHAEL L. PARSON, GOVERNOR

MISSOURI DEPARTMENT OF NATURAL RESOURCES MISSOURI STATE PARKS

PROJECT OFFICE OF ADMINISTRATION

DIVISION OF FACILITIES MANAGEMENT, MANAGEMENT:

DESIGN AND CONSTRUCTION

X2215-01 PROJECT #:


SITE #:

ASSET #: 7815603018

LEGEND

0	IRON PIN SET (TYPICAL) GREAT RIVER 2001011476	w∨ ⊠	WATER VALVE
•	IRON PIN FOUND, AS NOTED		FIRE HYDRANT
×	CUT CROSS	WH SP	WATER HYDRANT
A	RIGHT OF WAY MARKER		IRRIGATION SPRINKLER HEAD
	STONE	icv O	IRRIGATION CONTROL VALVE
CP <u> </u>	CONTROL POINT	МВ	MAIL BOX
•	PERMANENT BENCHMARK	- 0 -	SIGN
	— CONTOUR MAJOR	⊗	POST
	— CONTOUR MINOR	OFP	FLAG POLE
£ 7 7 7 7 7 7 7 7 7 7 7 7 7 7 7 7 7 7 7	DECIDUOUS TREE, SIZE AS NOTED	AC	AIR CONDITIONING UNIT
	CONIFER TREE, SIZE AS NOTED		CABLE TV RISER
	BUSH, SIZE AS NOTED	•	BORE HOLE, AS NOTED
ф Ф	LIGHT POLE	s	— SANITARY SEWER LINE
<u></u>	POWER POLE	O	— FENCE CHAIN-LINK
X	ELECTRIC RISER	X	— FENCE CHAIN-LINK — WIRE
EB	ELECTRIC BOX		— WOOD
EM	ELECTRIC METER	xx	— WOVEN WIRE
\circ	GUT WIRE ANCHOR	——В ——	— POLY VINYL
\Leftrightarrow	PEDESTAL, AS NOTED	——— OHE ———	— ELECTRIC LINE
8	SANITARY SEWER CLEAN OUT	——— UE ———	— UNDERGROUND ELECTRIC LINE
O ^{GP}	GRINDER PUMP	тт	— TELEPHONE LINE
ST	SEPTIC TANK	UT	— UNDERGROUND TELEPHONE LINE
<u> </u>	SANITARY SEWER MANHOLE	CTV	— CABLE TV LINE
(STORM SEWER MANHOLE	G	— GAS LINE
\bigcirc	TELEPHONE MANHOLE		— WATER LINE
	TELEPHONE RISER	GW	— GAS & WATER LINE
GV ⋈	GAS VALVE	FO	— FIBER OPTIC LINE
GM	GAS METER		— IRRIGATION LINE
	WELL -	FM	— FORCE MAIN LINE
wm O	WATER METER	~~~	TREE LINE
-			FLOWLINE

CONSTRUCTION **DOCUMENTS**

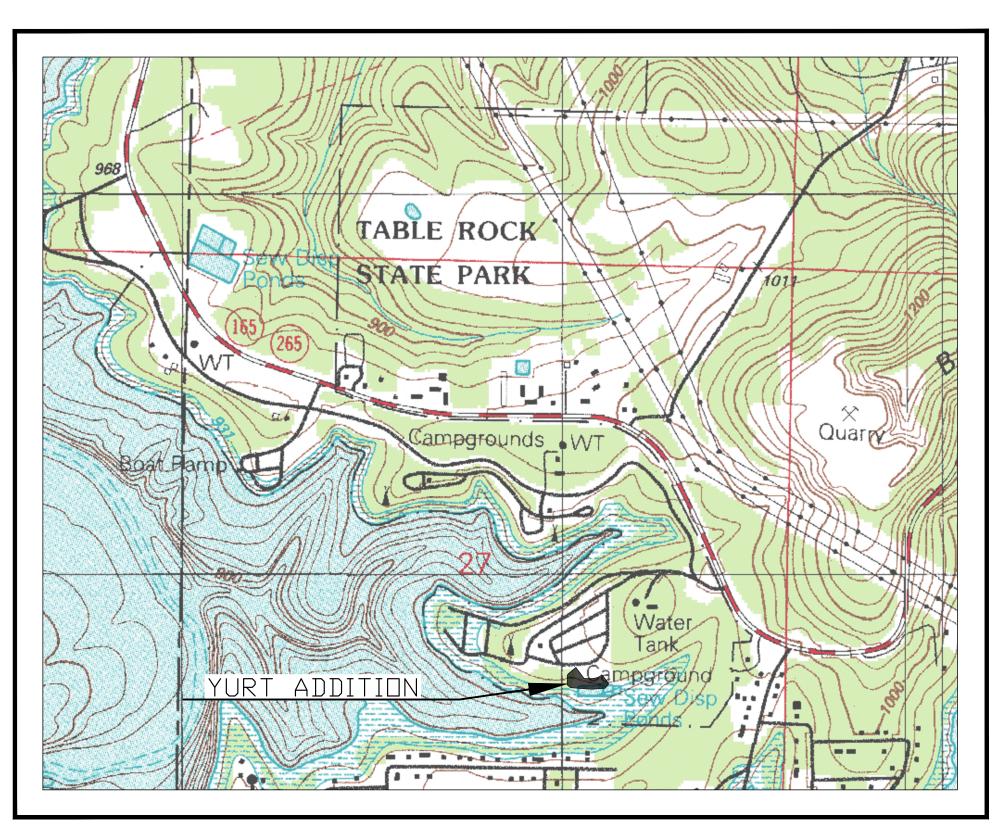

SECTION 27, TOWNSHIP 22N, RANGE 22W TANEY COUNTY, MISSOURI

ID	NORTHING	EASTING	ELEV.	DESCRIPTION
1	272219.3386	1405291.7581	965.17	CP1 60D
2	272098.8723	1405097.0978	957.31	CP2 60D
3	271457.1901	1405287.2088	940.53	CP3 60D
4	271437.3401	1405108.5624	939.23	CP4 60D

HORIZONTAL COORDINATES ARE BASED ON THE MISSOURI COORDINATE SYSTEM OF 1983, CENTRAL ZONE

BM1 - X IN SQUARE CUT OF SOUTHWEST CORNER OF CONCRETE PAD FOR TRASH BIN. BIN LOCATED IMMEDIATELY EAST OF PAD ELEVATION = 970.38'

BM2 - X IN SQUARE CUT OF NORTHWEST CORNER OF CONCRETE SIDEWALK ON NORTH SIDE AND WEST END OF SHOWER BUILDING ELEVATION = 962.19'

BM3 - X IN SQUARE CUT OF NORTHWEST CORNER OF CONCRETE PAD FOR WATER HYDRANT LOCATED EAST OF PAD SITE 286 AND IMMEDIATELY SOUTH OF SANITARY SEWER LIFT STATION. ELEVATION = 942.04'


VERTICAL DATUM: NAVD88

MISSOURI STATE PARKS SIGNATURES DIVISION OF FACILITIES MANAGEMENT DESIGN AND CONSTRUCTION TABLE ROCK STATE PARK:

DESIGNER:

GREAT RIVER ENGINEERING

2826 S. INGRAM MILL ROAD SPRINGFIELD, MO 65804 PHONE: (417) 886-7171 www.greatriv.com

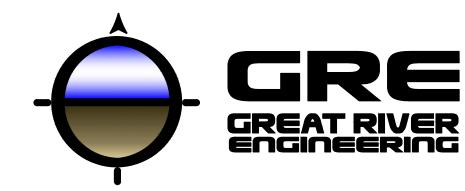

Great River Engineering - Missouri State Certificate of Authority Numbers: Engineering: 2000156885, Land Surveying: 2001011476, Landscape Architecture: 2007013673

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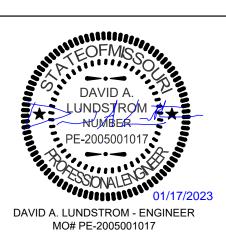
UTILITY CONTACTS

ELECTRIC WHITE RIVER VALLEY ELECTRIC COOPERATIVE JOE DONOVAN PHONE: (417) 335-9335

WATER & SANITARY SEWER TABLE ROCK STATE PARK WATER SYSTEM CAYLEN CANTRELL PHONE: (417) 334-4704

UTILITY DISCLAIMER


THE UNDERGROUND UTILITIES DEPICTED ON THIS SURVEY ARE THOSE DISCOVERED BY FIELD INSPECTION, OR LOCATED BY UTILITY COMPANY REPRESENTATIVES; AND MAY NOT BE ALL THE UTILITIES ON OR NEAR THE PROPERTY. AFTER USING SHOWN, WE REFRAIN FROM WARRANTING EITHER THE LOCATION OF, OR COMPLETENESS OF, THOSE UTILITIES SHOWN, AS BEING ALL UTILITIES POSSIBLY AFFECTING THE SUBJECT PROPERTY.





SHEET NUMBER:

G-0011 OF 32 SHEETS JANUARY 17, 2023

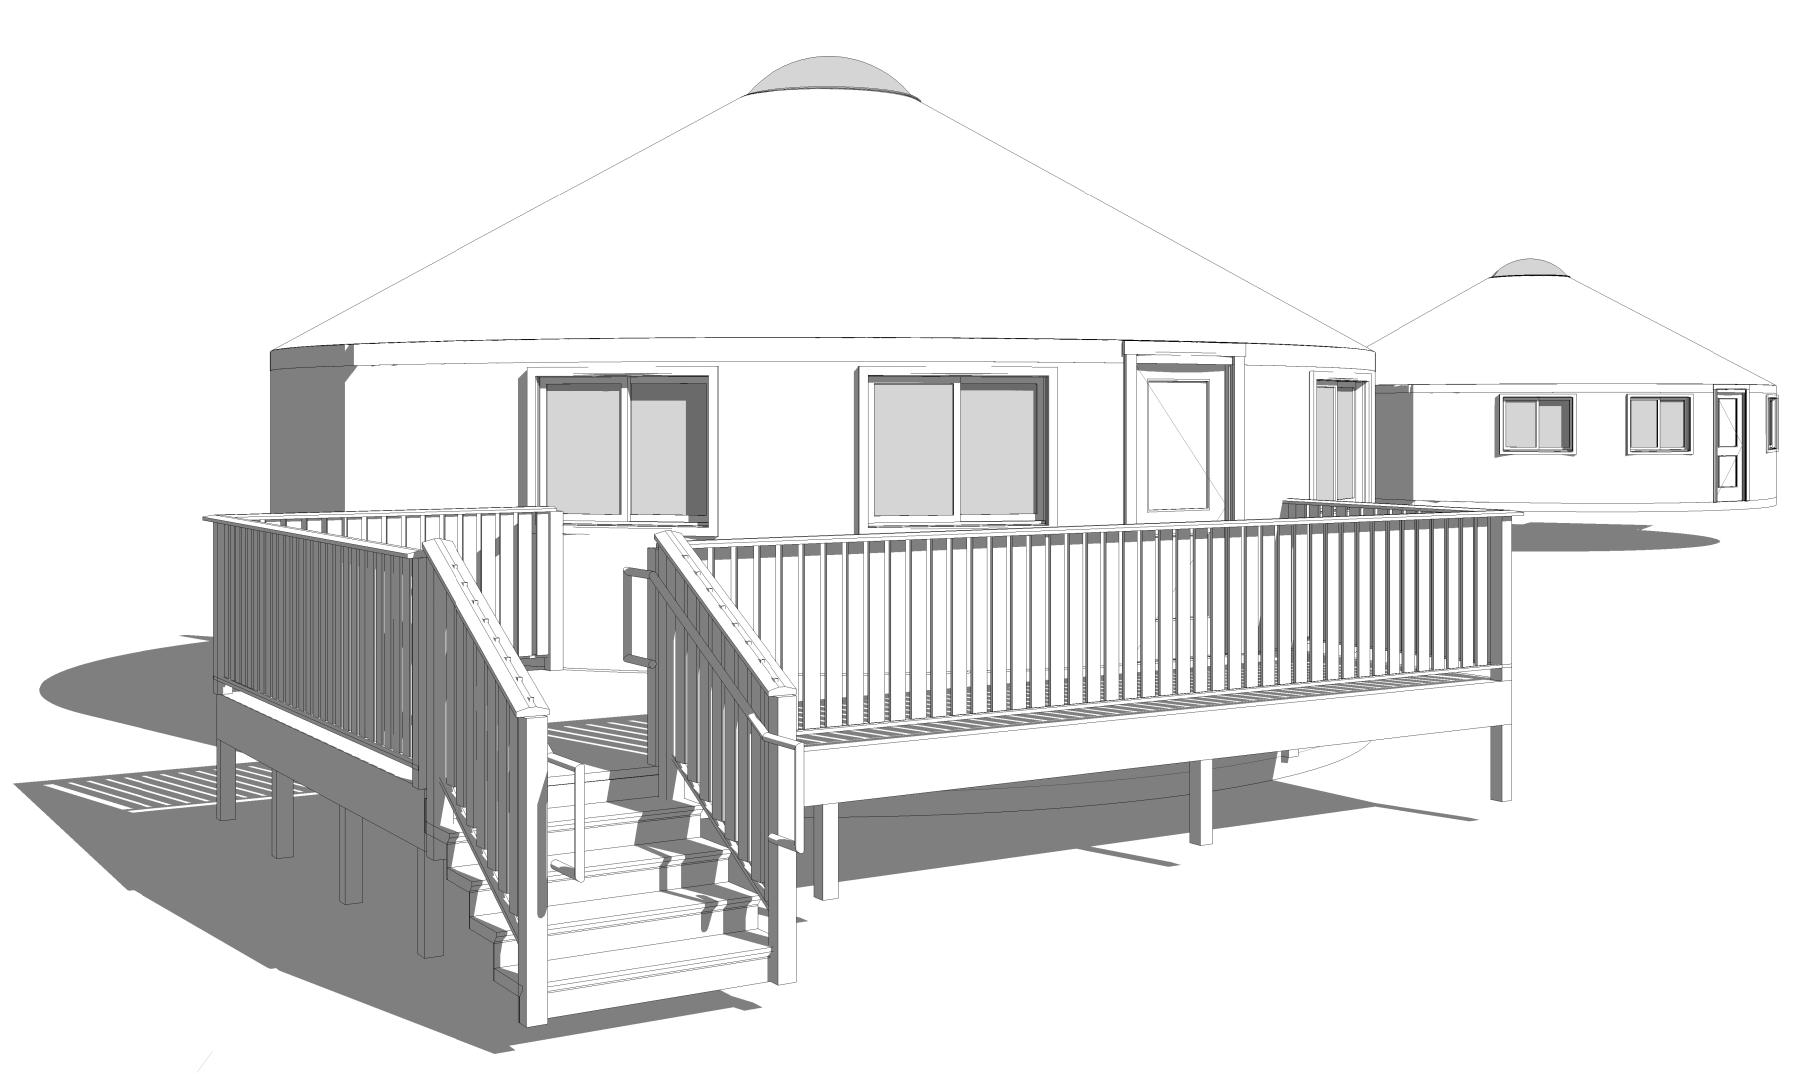

*ARTIST'S DEPICTION/RENDERING OF PROJECT FOR GRAPHICAL PURPOSES ONLY - DO NOT CONSTRUCT FROM THIS DEPICTION

GENERAL

OF THESE CONSTRUCTION DOCUMENTS.

CONDITIONS DRAWINGS AND GENERAL PROVISIONS OF THE CONTRACT NCLUDING "AIA DOCUMENT A201-2017 - GENERAL CONDITIONS OF THE CONTRACT FOR CONSTRUCTION" APPLY TO ALL AREAS

ALL APPLICABLE INDUSTRY STANDARDS, ASTM CLASSIFICATIONS, MANUFACTURER'S SPECIFICATIONS. PUBLISHED MANUFACTURER OR INSTITUTE INSTALLATION NSTRUCTIONS AND SPECIFICATIONS SHALL BE APPLICABLE T MATERIALS SPECIFIED IN THE FOLLOWING HEADINGS. THE GENERAL CONTRACTOR AND SUBCONTRACTORS SHALL BE RESPONSIBLE FOR CHECKING CONTRACT DOCUMENTS,

FIELD CONDITIONS AND DIMENSIONS FOR ACCURACY AND ONFIRMING THAT ALL WORK IS BUILDABLE AS SHOWN ELECTRICAL, PLUMBING AND STRUCTURAL DRAWINGS FOR OVERALL SCOPE OF WORK. BEFORE PROCEEDING WITH CONSTRUCTION. IF THERE ARE ANY DISCREPANCIES OR OMISSIONS WHICH WOULD INTERFERE WITH SATISFACTORY COMPLETION OF THE WORK. HE GENERAL CONTRACTOR SHALL OBTAIN A CLARIFICATION FROM THE ARCHITECT BEFORE PROCEEDING WITH THE WORK

THE GENERAL CONTRACTOR AND SUBCONTRACTORS SHALL VISIT THE SITE THOROUGHLY REVIEW THE DRAWINGS AND SPECIFICATIONS, SO AS TO BE SURE ALL ANCILLARY COSTS HAVE BEEN COVERED IN THE BID. THE OWNER WILL NOT ENTERTAIN REQUESTS FOR EXTRA COMPENSATION FOR WORK SUBCONTRACTORS SHALL BE RESPONSIBLE FOR ALL THAT SHOULD HAVE REASONABLY BEEN ANTICIPATED OR

THE GENERAL CONTRACTOR IS RESPONSIBLE FOR THE MEANS, METHODS, AND TECHNIQUES, OF CONSTRUCTION, SAFETY PRECAUTIONS IN CONNECTION WITH THE WORK, AND FOR THE ACTS AND OMISSIONS OF THE SUBCONTRACTORS. THE GENERAL CONTRACTOR AND SUBCONTRACTORS SHALL NOT SCALE THE DRAWINGS TO DETERMINE ANY DIMENSION. SHOULD THERE BE A CRITICAL DIMENSION OMITTED OR AN UNCERTAINTY WITH THE DIMENSIONS SHOWN, VERIFY WITH

THE ARCHITECT BEFORE PROCEEDING. DRAWINGS ARE NOT SET UP SPECIFICALLY ACCORDING TO THE TRADE AND EACH CONTRACTOR AND SUB-CONTRACTOR OR TRADE IS REQUIRED TO REVIEW THE DRAWINGS AS A WHOLE AND PROVIDE ANY MISCELLANEOUS ITEMS, MATERIALS, WORK, ETC. REQUIRED TO COMPLETE THE WORK AS SHOWN ON ALL DOCUMENTS. ALL TRADES SHALL ADHERE TO THIS REQUIREMENT. STRUCTURAL, MECHANICAL, ELECTRICAL AND PLUMBING REQUIREMENTS AND RELATED WORK ARE INDICATED THROUGHOUT THE SET OF DRAWINGS AND SHOULD BE REVIEWED WITH THE SPECIFIC MECHANICAL,

THE GENERAL CONTRACTOR SHALL BE RESPONSIBLE FOR ALL PERMITS, FEE INSPECTIONS AND APPROVALS REQUIRED FOR CONSTRUCTION BY ALL APPLICABLE LOCAL, STATE, AND FEDERAL CODES. THE CONTRACTOR SHALL COORDINATE ALL WORK WITH THE OWNER. EACH SUBCONTRACTOR SHALL BE RESPONSIBLE FOR PERMITS, FEES, ETC. AS RELATED TO THEIR

SPECIFIC PORTION OF THE WORK. THE VARIOUS MECHANICAL, ELECTRICAL, AND PLUMBING MECHANICAL, PLUMBING, AND ELECTRICAL REQUIRED BY

LOCAL, STATE AND FEDERAL CODES.

THE GENERAL CONTRACTOR AND SUBCONTRACTORS SHALL PURCHASE AND MAINTAIN CERTIFICATIONS OF INSURANCE WITH RESPECT TO WORKMEN'S COMPENSATION, PUBLIC REQUIRED BY LAW, OR OWNER, THE CONTRACTOR SHALL BE ALL SAFETY PRECAUTIONS IN CONNECTION WITH THE WORK.

EACH SUBCONTRACTOR SHALL FURNISH ALL LABOR, MATERIALS (UNLESS NOTED OTHERWISE) EQUIPMENT, TOOLS, UTILITIES, INSURANCE, TAXES, TRANSPORTATION AND CONSTRUCTION OF THEIR PORTION OF THE SUBCONTRACT FOR THIS PROJECT AS INDICATED IN THESE DOCUMENTS, WHETHER TEMPORARY OR PERMANENT.

ALL SUBCONTRACTORS MUST COMPLY WITH RULES AND SAFETY AND SANITARY LAWS, CODES, STATUTES AND ORDINANCES.

ALL INSTALLED PLUMBING, MECHANICAL AND ELECTRICAL EQUIPMENT SHALL OPERATE QUIETLY AND FREE FROM EXCESS VIBRATION.

ALL ROOF PENETRATIONS, EQUIPMENT SUPPORTS, PITCH PANS, FLASHING, CURBING AND ROOFING REPAIRS SHALL BE ENGINEERED AND INSTALLED IN ACCORDANCE WITH STANDARD PROJECT ROOFING DETAILS, FACTORY MUTUAL INSURANCE ASSOCIATION'S SPECIFICATIONS, AND GUIDELINES SHALL BE MADE BY THE ARCHITECT. PUBLISHED BY THE NATIONAL ROOFING CONTRACTORS

THE GENERAL CONTRACTOR SHALL NOTIFY SUBCONTRACTORS WHEN TELEPHONE SERVICE IS REQUIRED

AT JOB SITE FOR WIRE OF PHONE EQUIPMENT.

SHOULD A DISCREPANCY BETWEEN CONTRACT DOCUMENTS IMMEDIATELY NOTIFY ARCHITECT FOR RESOLUTION BEFORE

> TO BE USED FOR FORMS AND/OR TEMPORARY STRUCTURES. ALL SURFACES SHALL BE PROPERLY PREPARED BEFORE THE APPLICATION OF FINISH MATERIALS. TO BEGIN THE APPLICATION OF A FINISH MATERIAL MEANS THAT THE SUBCONTRACTOR ACCEPTS THE SURFACE AND

SUBSEQUENT RESPONSIBILITY FOR THE APPEARANCE OF THE REGULATIONS OF AGENCIES HAVING JURISDICTION AND SHALL ALL MATERIALS, FINISHES AND EQUIPMENT REQUIRED FOR THE ALL WORK BY ALL TRADES SHALL CONFORM TO AND BE CONFORM TO ALL CITY, STATE, AND FEDERAL CONSTRUCTION COMPLETION OF THIS PROJECT SHALL BE INSTALLED IN ACCORDANCE WITH THE MANUFACTURER'S INSTRUCTIONS

IT SHALL BE THE SUBCONTRACTORS RESPONSIBILITY TO OBTAIN AND SUBMIT TO THE GENERAL CONTRACTOR TO FORWARD TO THE ARCHITECT FOR REVIEW ANY SHOP DRAWINGS, MATERIAL SAMPLES AND MANUFACTURER'S PRINTED MATERIAL NECESSARY FOR AN ACCURATE COMPARISON TO BE MADE ON ANY ITEM SUBMITTED FOR INSTALLATION AND/OR SUBSTITUTION. ALL FINAL SELECTIONS

MILLWORK CONSTRUCTION SHALL CONFORM WITH AWI

STANDARDS FOR PREMIUM MILLWORK. DRAWINGS SHALL

INDICATE MILLWORK DESIGN INTENT ONLY. FABRICATOR IS

RESPONSIBLE FOR PROPER EXECUTION AND SHALL SUBMIT

SHOP DRAWINGS FOR DESIGN REVIEW.

AGAINST DEFECT STARTING FROM THE DATE OF SUBSTANTIAL ALL MATERIALS SHALL BE NEW, UNUSED AND OF THE HIGHEST QUALITY IN EVERY RESPECT, UNLESS OTHERWISE NOTED OR SUPPLYING THE ARCHITECT AND THE OWNER WITH ALI SUPPLYING THE ARCHITECT AND THE OWNER WITH ALL MAINTENANCE AND OPERATION MANUALS, WARRANTIES, AND GUARANTEES ON ALL EQUIPMENT AND MATERIALS. THE CONSTRUCTION SITE SHALL AT ALL TIMES BE KEPT FREE FROM DEBRIS, WASTE AND RUBBISH. THE PREMISES SHALL BE MAINTAINED IN A MANNER TO PROVIDE A SAFE ENVIRONMENT

FOR WORKERS AND THE PUBLIC. CONDUCT CLEANING AND

ALL MATERIALS, EQUIPMENT, AND LABOR SHALL CARRY A

DISPOSAL OPERATIONS TO COMPLY WITH ALL LOCAL DINANCES AND ANTI POLLUTION LAWS. COMPLETED IN ACCORDANCE WITH ALL APPLICABLE CODES, ORDINANCES, STANDARDS OR RESTRICTIONS WHETHER AND RECOMMENDATIONS, AS WELL AS GUIDELINES SET FORTH INDICATED ON DRAWINGS OR NOT. THE MORE STRINGENT TO GOVERN DISCREPANCIES BETWEEN CONTRACT DOCUMENTS AND CODES SHALL BE BROUGHT TO THE ARCHITECTS ATTENTION PROMPTLY AND RESOLUTION OBTAINED BEFORE

> UPON COMPLETION OF THE WORK, REMOVE ALL WASTE MATERIALS, EQUIPMENT, DEBRIS AND CLEAN ALL SIGHT-EXPOSED SURFACES, TOUCH-UP PAINTING OF MARRED SURFACES AND REPAIR OF ALL DAMAGES LEAVING THE PROJECT READY FOR OCCUPANCY, TRASH SHALL BE REMOVED FROM PROJECT SITE AT SUBCONTRACTOR'S EXPENSE. IF THE SUBCONTRACTOR FAILS TO HAVE THE SITE READY FOR OCCUPANCY, THE GENERAL CONTRACTOR MAY HIRE AN OUTSIDE AGENCY FOR THIS SERVICE AND THE COST MAY BE CHARGED TO THE CONTRACTOR.

UPON COMPLETION OF THE PROJECT, A "PUNCH LIST" WILL BE **SPECIAL NOTICE** COMPILED BY THE ARCHITECT, WHICH WILL CONSIST OF ITEMS IN NEED OF CORRECTION AND UNSATISFACTORY AND/OR UPON THE CORRECTION AND SUBSEQUENT APPROVAL OF

THE GENERAL CONTRACTOR SHALL OBTAIN CERTIFICATE FOR

OCCUPANCY FROM THE APPROPRIATE REGULATORY AGENCY

LL CHANGES, OMISSIONS OR ADDITIONS TO THE SCOPE OF

UNLESS NOTED OTHERWISE, ALL WORK SHALL INCLUDE NECESSARY APPURTENANCES AND ACCESSORIES TO PROVIDE

BUILDING DEPARTMENT. ONE (1) COPY OF THE CERTIFICATE WILL BE SUBMITTED TO THE ARCHITECT WITH FINAL

WORK DESCRIBED IN THESE CONTRACT DRAWINGS AND SPECIFICATIONS MUST BE APPROVED IN WRITING BY THE

COMPLETE OPERATING ASSEMBLIES, WHETHER OR NOT

IN THE EVENT THE CLIENT CONSENTS TO, ALLOWS, AUTHORIZES OR APPROVES CHANGES TO ANY PLANS, SPECIFICATIONS, OR OTHER CONSTRUCTION DOCUMENTS AND THESE CHANGES ARE NOT APPROVED IN WRITING BY THE DESIGN PROFESSIONAL, THE CLIENT RECOGNIZES THAT SUCH CHANGES AND THE RESULT THEREOF ARE NOT THE RESPONSIBILITY OF THE DESIGN PROFESSIONAL. THEREFORE, THE CLIENT AGREES TO RELEASE THE DESIGN PROFESSIONAL FROM ANY LIABILITY ARISING FROM THE CONSTRUCTION, USE OR RESULT OF SUCH CHANGES. IN ADDITION, THE CLIENT AGREES TO THE FULLEST EXTENT PERMITTED BY LAW, TO INDEMNIFY AND HOLD THE DESIGN PROFESSIONAL HARMLESS FROM ANY DAMAGE, LIABILITY, OR COST (INCLUDING RESONABLE ATTORNEY'S FEES AND

GENERAL NOTES

NOTE: YURT PACKAGE BASIS OF DESIGN TO BE PACIFIC YURTS INC. 30' YURT. YURT PACKAGE SHALL INCLUDE STANDARD AND OPTIONAL FEATURES LISTED BELOW.

- LATTICE WALL - RAFTERS
- CENTER RING
- TINTED ACRYLIC DOME - TENSION CABLE
- SIDE COVER - WALL INSULATION

- EXTERIOR ENTRY DOOR & FRAME

- VINYL DOUBLE PANE SLIDING WINDOWS - TOP COVER
- ROOF INSULATION - RAIN DIVERTER
- HARDWARE - SNOW AND WIND KIT WITH STANDARD HARDWARE - PERIMETER BLOCKING - 2X6 RAFTER/RING/HARDWARE UPGRADE
- FAN SUPPORT - INSTRUCTIONS

STATE OF MISSOURI MICHAEL L. PARSON, **GOVERNOR**





DIVISION OF FACILITIES MANAGEMENT, **DESIGN AND CONSTRUCTION**

DEPARTMENT OF NATURAL RESOURCES MISSOURI STATE PARKS

TABLE ROCK STATE PARK REPLACE 5 BASIC SITES WITH 5 PREMIUM YURTS

TABLE ROCK STATE PARK CAMPGROUND #2 5272 STATE HWY 165 BRANSON, MISSOURI 65616

PROJECT # X2215-01 7815603018

REVISION:	
DATE:	
REVISION:	
DATE:	
REVISION:	
DATE.	

DATE: ISSUE DATE: JANUARY 17, 2023

CAD DWG FILE: X221601 G-101 DRAWN BY: HDG CHECKED BY: HDG DESIGNED BY: HDG

SHEET TITLE: COVER SHEET

BASE BID & ALTERNATES NOTES

ALTERNATE #2: Yurt packages, raised platform structure, interior framing

ALTERNATE #1: Yurts foundations, piers and site concrete slabs.

ALTERNATE #3: Interior finishes, fixtures, millwork and equipment.

BASE BID: Site work & Site Utilities

Refer to specifications for more information.

SHEET NUMBER:

BATHROOM REQUIREMENTS

FLOOR CLEARANCES: REFRENCE ICC A117.1-2009 603.2 DOORS MAY SWING INTO THE REQUIRED FLOOR CLEARANCES FOR FIXTURES IF 30" X 48" AREA IS PROVIDED BEYOND THE ARC OF THE DOOR SWING. (EXCEPTION: WHERE A CLEAR FLOOR SPACE COMPLING WITH SECTION 304 IS PROVIDED WITHIN THE ROOM BEYOND THE ARC OF THE DOOR SWING.) CLEAR FLOOR SPACES, CLEARANCES, AND WHEELCHAIR TURNING SPACES ARE PERMITTED TO OVERLAP. (ICC A117.1-2009

GRAB BARS: GRAB BAR HEIGHTS SHALL BE BETWEEN 33 INCHES AND 36 INCHES ABOVE FLOOR, BACK WALL OF BATHTUB SHALL BE PROVIDED WITH TWO GRAB BARS: THE SECOND BAR LOCATED 9 INCHES ABOVE THE RIM OF THE BATHTUB. (ICC A117.1-2009 604.5)

LAVATORY: HEIGHT OF SINK SHALL BE 34 INCHES MAX ABOVE FLOOR. BOWL DEPTH SHALL BE 6 1/2" DEEP MAXUMUM. (ICC A117.1-2009 606.3) ALL EXPOSED PIPES UNDER LAVATORY SHALL BE INSULATED (ICC A117.1-2009 606.6) THERE SHALL BE NO SHARP OR ABRASIVE SURFÁCES UNDER LAVATORIES.

MIRRORS: MIRRORS ABOVE LAVATORIES SHALL HAVE THE BOTTOM EDGE OF THE REFLECTING SURFACE 40 INCHES MAXIMUM ABOVE THE FLOOR. (ICC A117.1-2009

WATER CLOSET: (PARALLEL APPROACH) CENTERLINE OF TOILET SHALL BE BETWEEN 16 INCHÉS AND 18 INCHES FROM SIDEWALL. (ANSI A117.1 -2003 1003.11.7.1) TOP OF THE TOILET SEAT SHALL BE BETWEEN 15 INCHES AND 19 INCHES ABOVE FLOOR. (ICC A117.1-2009

DWELLING UNIT (ACCESSIBLE) - DWELLING UNIT (ACCESSIBLE) -**KITCHEN REQUIREMENTS**

FLOOR CLEARANCES: FOR GALLEY STYLE KITCHENS CLEARANCES BETWEEN ALL OPPOSING BASE CABINETS, COUNTER TOPS, APPLIANCES, OR WALLS WITHIN KITCHEN WORK AREAS SHALL BE 48 INCHES MINIMUM. CLEAR FLOOR SPACE AT APPLIANCES SHALL BE POSITIONED FOR PARALLEL APPROACH. U-SHAPED KITCHENS REQUIRED 60 INCHES MINUMUM.

KITCHEN STORAGE: CABINETS SHALL HAVE A CLEAR FLOOR SPACE OF 30 INCHES BY 48 INCHES POSITIONED FOR PARALLEL OR FORWARD APPROACH.

APPLIANCES: REFRIGRATOR - COMBINATION REFRIGERATORS AND FREEZERS SHALL HAVE AT LEAST 50% OF THE FREEZER SPACE 54 INCHES MAXIMUM ABOVE THE FLOOR.

SINK: CABINETRY SHALL BE PERMITTED TO BE ADDED UNDER THE SINK, PROVIDED SUCH CABINETRY CAN BE REMOVED WITHOUT REMOVAL OR REPLACEMENT OF THE SINK, AND PROVIDED THE FINISH FLOOR EXTENDS UNDER SUCH CABINETRY. HEIGHT OF SINK SHALL BE 34 INCHES MAX ABOVE FLOOR OR BE ADJUSTABLE AT VARIABLE HEIGHTS BETWEEN 29 INCHES AND 36 INCHES. BOWL DEPTH SHALL BE 6 1/2" DEEP MAXIMUM IN AT THE LEAST ONE COMPARTMENT. ALL EXPOSED PIPES UNDER SINK SHALL BE INSULATED. THERE SHALL BE NO SHARP OR ABRASIVE SURFACES UNDER SINK.

OPERATIONAL PARTS: SINK FAUCET CONTROLS SHALL BE OPERABLE WITH ONE HAND AND SHALL NOT REQUIRE TIGHT GRASPING, PINCHING, OR TWISTING OF THE WRIST. THE FORCE REQUIRED TO ACTIVATE OPRABLE PARTS SHALL BE 5 POUND MAXIMUM.

NOTE: ALL REQUIRED VERTICAL HEIGHTS CAN BE OBTAINED BY SETTING THE COUNTER TOP HEIGHTS AT 34 INCHES ABOVE FLOOR AND THE BOTTOM EDGE OF UPPER CABINETS AT 48 INCHES ABOVE THE FLOOR IN ACCESSIBLE UNITS.

DWELLING UNIT (ACCESSIBLE) - MISC. REQUIREMENTS

ACCESSIBLE ROUTE: AT LEAST ONE ACCESSIBLE ROUTE SHALL CONNECT ALL SPACES AND ELEMENTS WHICH ARE PART OF THE DWELLING UNIT AND SHALL NOT PASS THROUGH RESTROOMS, CLOSETS, OR SIMILAR SPACES.


WALKING SURFACE: OF ACCESSIBLE ROUTE SHALL NOT BE STEEPER THAN 1:20 WITH A CROSS SLOPE NOT STEEPER THAN 1:48. CLEAR WIDTH SHALL BE 36" MINIMUM AND 32" MINIMUM FOR A DISTANCE NOT GREATER THAN 24" MAX.


DOORS & DOORWAYS: THE PRIMARY ENTRANCE DOOR TO THE DWELLING UNIT, AND ALL OTHER DOORS INTENDED FOR USER PASSAGE, SHALL COMPLY WITH SECTION 404. HANDLES, PULLS, LATCHES, LOCKS, AND OTHER OPERABLE PARTS ON ACCESSIBLE DOORS SHALL HAVE A SHAPE THAT IS EASY TO GRASP WITH ONE HAND AND DOES NOT REQUIRE TIGHT GRASPING, PINCHING, OR TWISTING THE WRIST TO OPERATE. SUCH HARDWARE SHALL BE 34 INCHES MIN AND 48 INCHES MAX ABOVE THE FLOOR OR GROUND.

OPERABLE PARTS: LIGHTING CONTROLS, ELECTRICAL SWITCHES AND RECEPTACLES, ENVIRONMENTAL CONTROLS, APPLIANCE CONTROLS, OPERATING HARDWARE FOR OPERABLE WINDOWS, PLUMBING FIXTURE CONTROLS, AND USER CONTROLS FOR SECURITY OR INTERCOM SYSTEMS SHALL BE PROVIDED WITH A CLEAR FLOOR SPACE OF 30" X 48" PARALLEL APPROACH. REACH RANGES FOR UNOBSTRUCTED REACH SHALL BE BETWEEN 15" TO 48" ABOVE FLOOR. OBSTRUCTED REACH RANGE IS 44"MAX

REACH RANGES DO NOT APPLY TO THE FOLLOWING:

- ELECTRICAL RECEPTACLES SERVING A DEDICATED USE. FLOOR ELECTRICAL RECEPTACLES.
- HVAC DIFFUSERS.
- CONTROLS MOUNTED ON CEILING FANS.
- CONTROLS MOUNTED ON RANGE HOODS IF ACCESSIBLE REDUNDANT CONTROLS ARE PROVIDED.

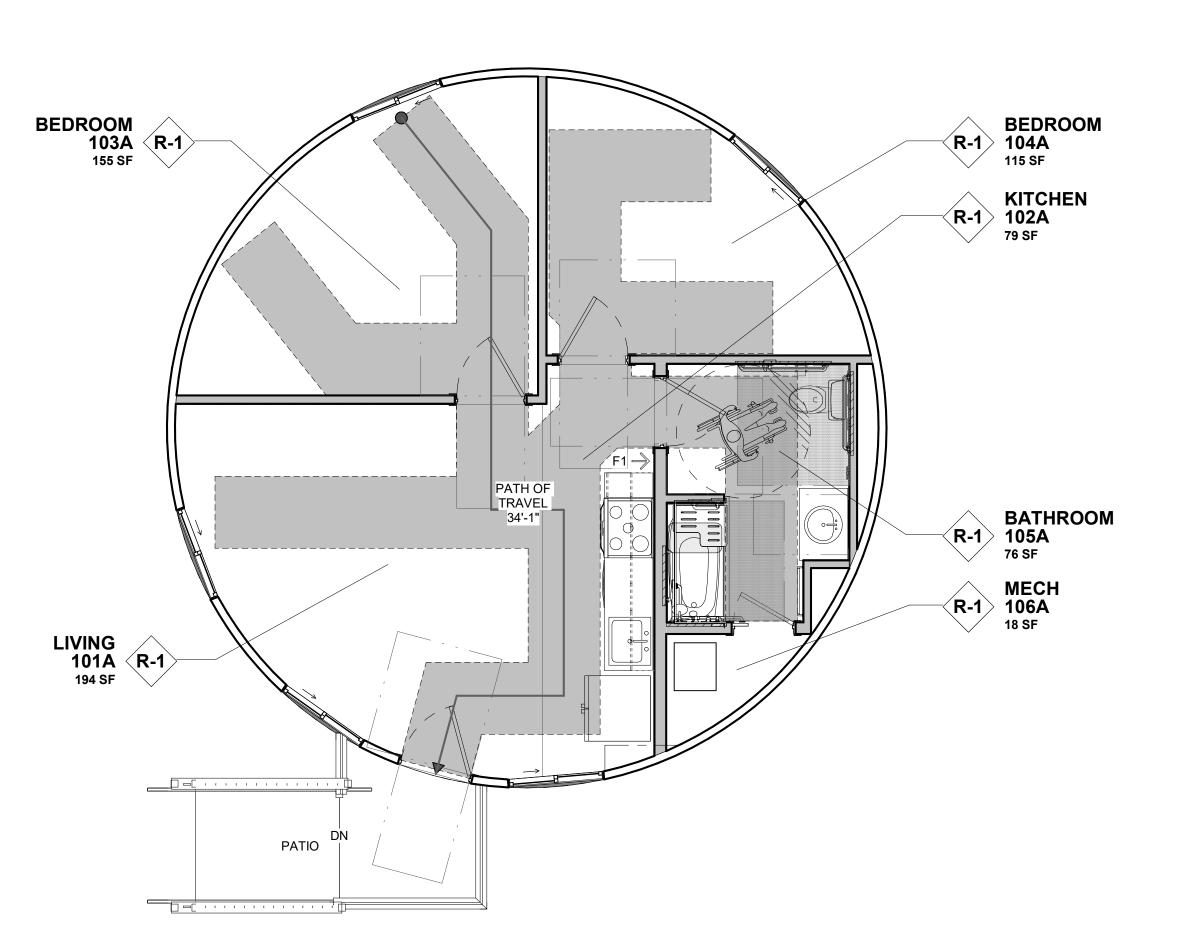

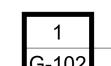

ADA UNIT FLOOR PLAN

scale: 1/4" = 1'-0"

BUILDING CODES

BUILDING CODE 2021 IBC MECHANICAL CODE 2021 IMC PLUMBING CODE 2021 IPC ELECTRICAL CODE 2020 NEC FIRE CODE 2021 IFC **FUEL GAS CODE** 2021 IFGC 2017 ICC/ANSI A117.1 ACCESSIBILITY CODE

CODE DATA

PRIMARY USE GROUPS (CHAP. #3) ACCESSORY USE GROUPS CONSTRUCTION TYPE

TOTAL AREA (FOOTPRINT)

SPRINKLED BUILDING YES (STATE EXEMPTION) FIRE ALARMS YES, SEE MEP SHEETS **EMERGENCY LIGHTING** YES, SEE MEP SHEETS

ALLOWABLE BUILDING HEIGHT + AREA ALLOWABLE AREA OF NONSEPARATED OCCUPANCY IS CALCULATED FROM THE MOST

3,535 S.F. (5 BUILDINGS, EACH 707 S.F.)

RESTRICTIVE OF PROVIDED USES:

ALLOWABLE AREA BY TABLE 503 (A-3) 7,000 S.F. PER STORY (SEE BELOW)

PROVIDED AREAS (R-1) 707 S.F. (EACH BUILDING)

ALLOWABLE HEIGHT/AREA (TABLE 503) 2 STORIES + 40 FEET

PROVIDED HEIGHT 1 STORY + 11'-3" S.O.G. ~14'-3" FOR RAISED PLATFORM ALTERNATE (ABOVE GRADE)

FLOOR AREA PER OCCUPANT (1004)

R-1, RESIDENTIAL: 1 OCCUPANT PER 200 GROSS S.F.

PLUMBING FIXTURES (2902.1)

1 SERVICE SINK

R-1, HOTELS, MOTELS, BOARDING HOUSES (TRANSIENT) SPACE REQUIRES THE FOLLOWING:

> TOTAL WATER CLOSETS 1 PER SLEEPING UNIT 1 TOTAL LAVATORY PER SLEEPING UNIT 1 TOTAL BATHTUB/SHOWER PER SLEEPING UNIT **0 DRINKING FOUNTAINS**

PROVIDED:

R-1 SPACES HAVE BEEN PROVIDED WITH:

TOTAL WATER CLOSETS 1 PER SLEEPING UNIT 1 TOTAL LAVATORY PER SLEEPING UNIT 1 TOTAL BATHTUB/SHOWER PER SLEEPING UNIT 0 DRINKING FOUNTAINS 0 SERVICE SINK (PROVIDED ON SITE)

MEANS OF EGRESS

EGRESS WIDTH (1005)

R-1 - EGRESS: 0.2 PER OCCUPANT DOOR OPERATIONS (1008) YES

STAIRWAYS (1009) N/A EXIT SIGNS (1006 & 1011) YES

TRAVEL DISTANCE (1017)

OCCUPANCY R-1 = MAX. 200'-0" WITHOUT SPRINKLER SYSTEM. MAX. AS DESIGNED 34'-1" (SEE PLANS).

EXIT QUANTITY (1006)

ONE EXIT REQUIRED.

TABLE 1006.3.4(2) STORIES WITH ONE EXIT OR ACCESS TO ONE EXIT FOR OTHER OCCUPANCIES

R-1 MAXIMUM OCCUPANT LOAD PER STORY 10.

FIRE RESISTANCE RATED **CONSTRUCTION (TABLES 601,602 &602.4)**

BUILDING ELEMENTS:

STRUCTURAL FRAME 0 HOUR EXT. BEARING WALL 0 HOUR EXT. NON-BEARING WALL 0 HOUR INT. BEARING WALL 0 HOUR INT. NON-BEARING WALL 0 HOUR FLOOR CONSTRUCTION 0 HOUR ROOF CONSTRUCTION 0 HOUR

FIRE EXTINGUISHER LEGEND

(ARROW INDICATES PLACEMENT ON WALL; BOX INDICATES CABINET)

TYPICAL DESIGNATIONS: MULTI-PURPOSE DRY CHEMICAL

DC = DRY CHEMICAL

WC = WET CHEMICAL

WET CHEMICAL CLASS K (TYPICALLY USED IN KITCHENS) HALON TYPE

FIRE EXTINGUISHER: MP5

LARSEN'S EXTINGUISHER AND BRACKET

MOUNTING HEIGHT: T.O. EXTINGUISHER @ 60" A.F.F.

STATE OF MISSOURI MICHAEL L. PARSON, **GOVERNOR**



OFFICE OF ADMINISTRATION DIVISION OF FACILITIES MANAGEMENT, **DESIGN AND CONSTRUCTION**

DEPARTMENT OF NATURAL RESOURCES MISSOURI STATE PARKS

TABLE ROCK STATE PARK REPLACE 5 BASIC SITES WITH 5 PREMIUM YURTS

TABLE ROCK STATE PARK CAMPGROUND #2 5272 STATE HWY 165 BRANSON, MISSOURI 65616

7815603018

PROJECT # X2215-01

ASSET#

REVISION: DATE: **REVISION:** DATE: **REVISION:** DATE:


ISSUE DATE: JANUARY 17, 2023

CAD DWG FILE: X221601 G-102 DRAWN BY: HDG CHECKED BY: HDG DESIGNED BY: HDG

SHEET TITLE: CODE INFO

SHEET NUMBER:

SHEET <u>3</u> OF <u>32</u> 1/17/2023 1:35:49 PM

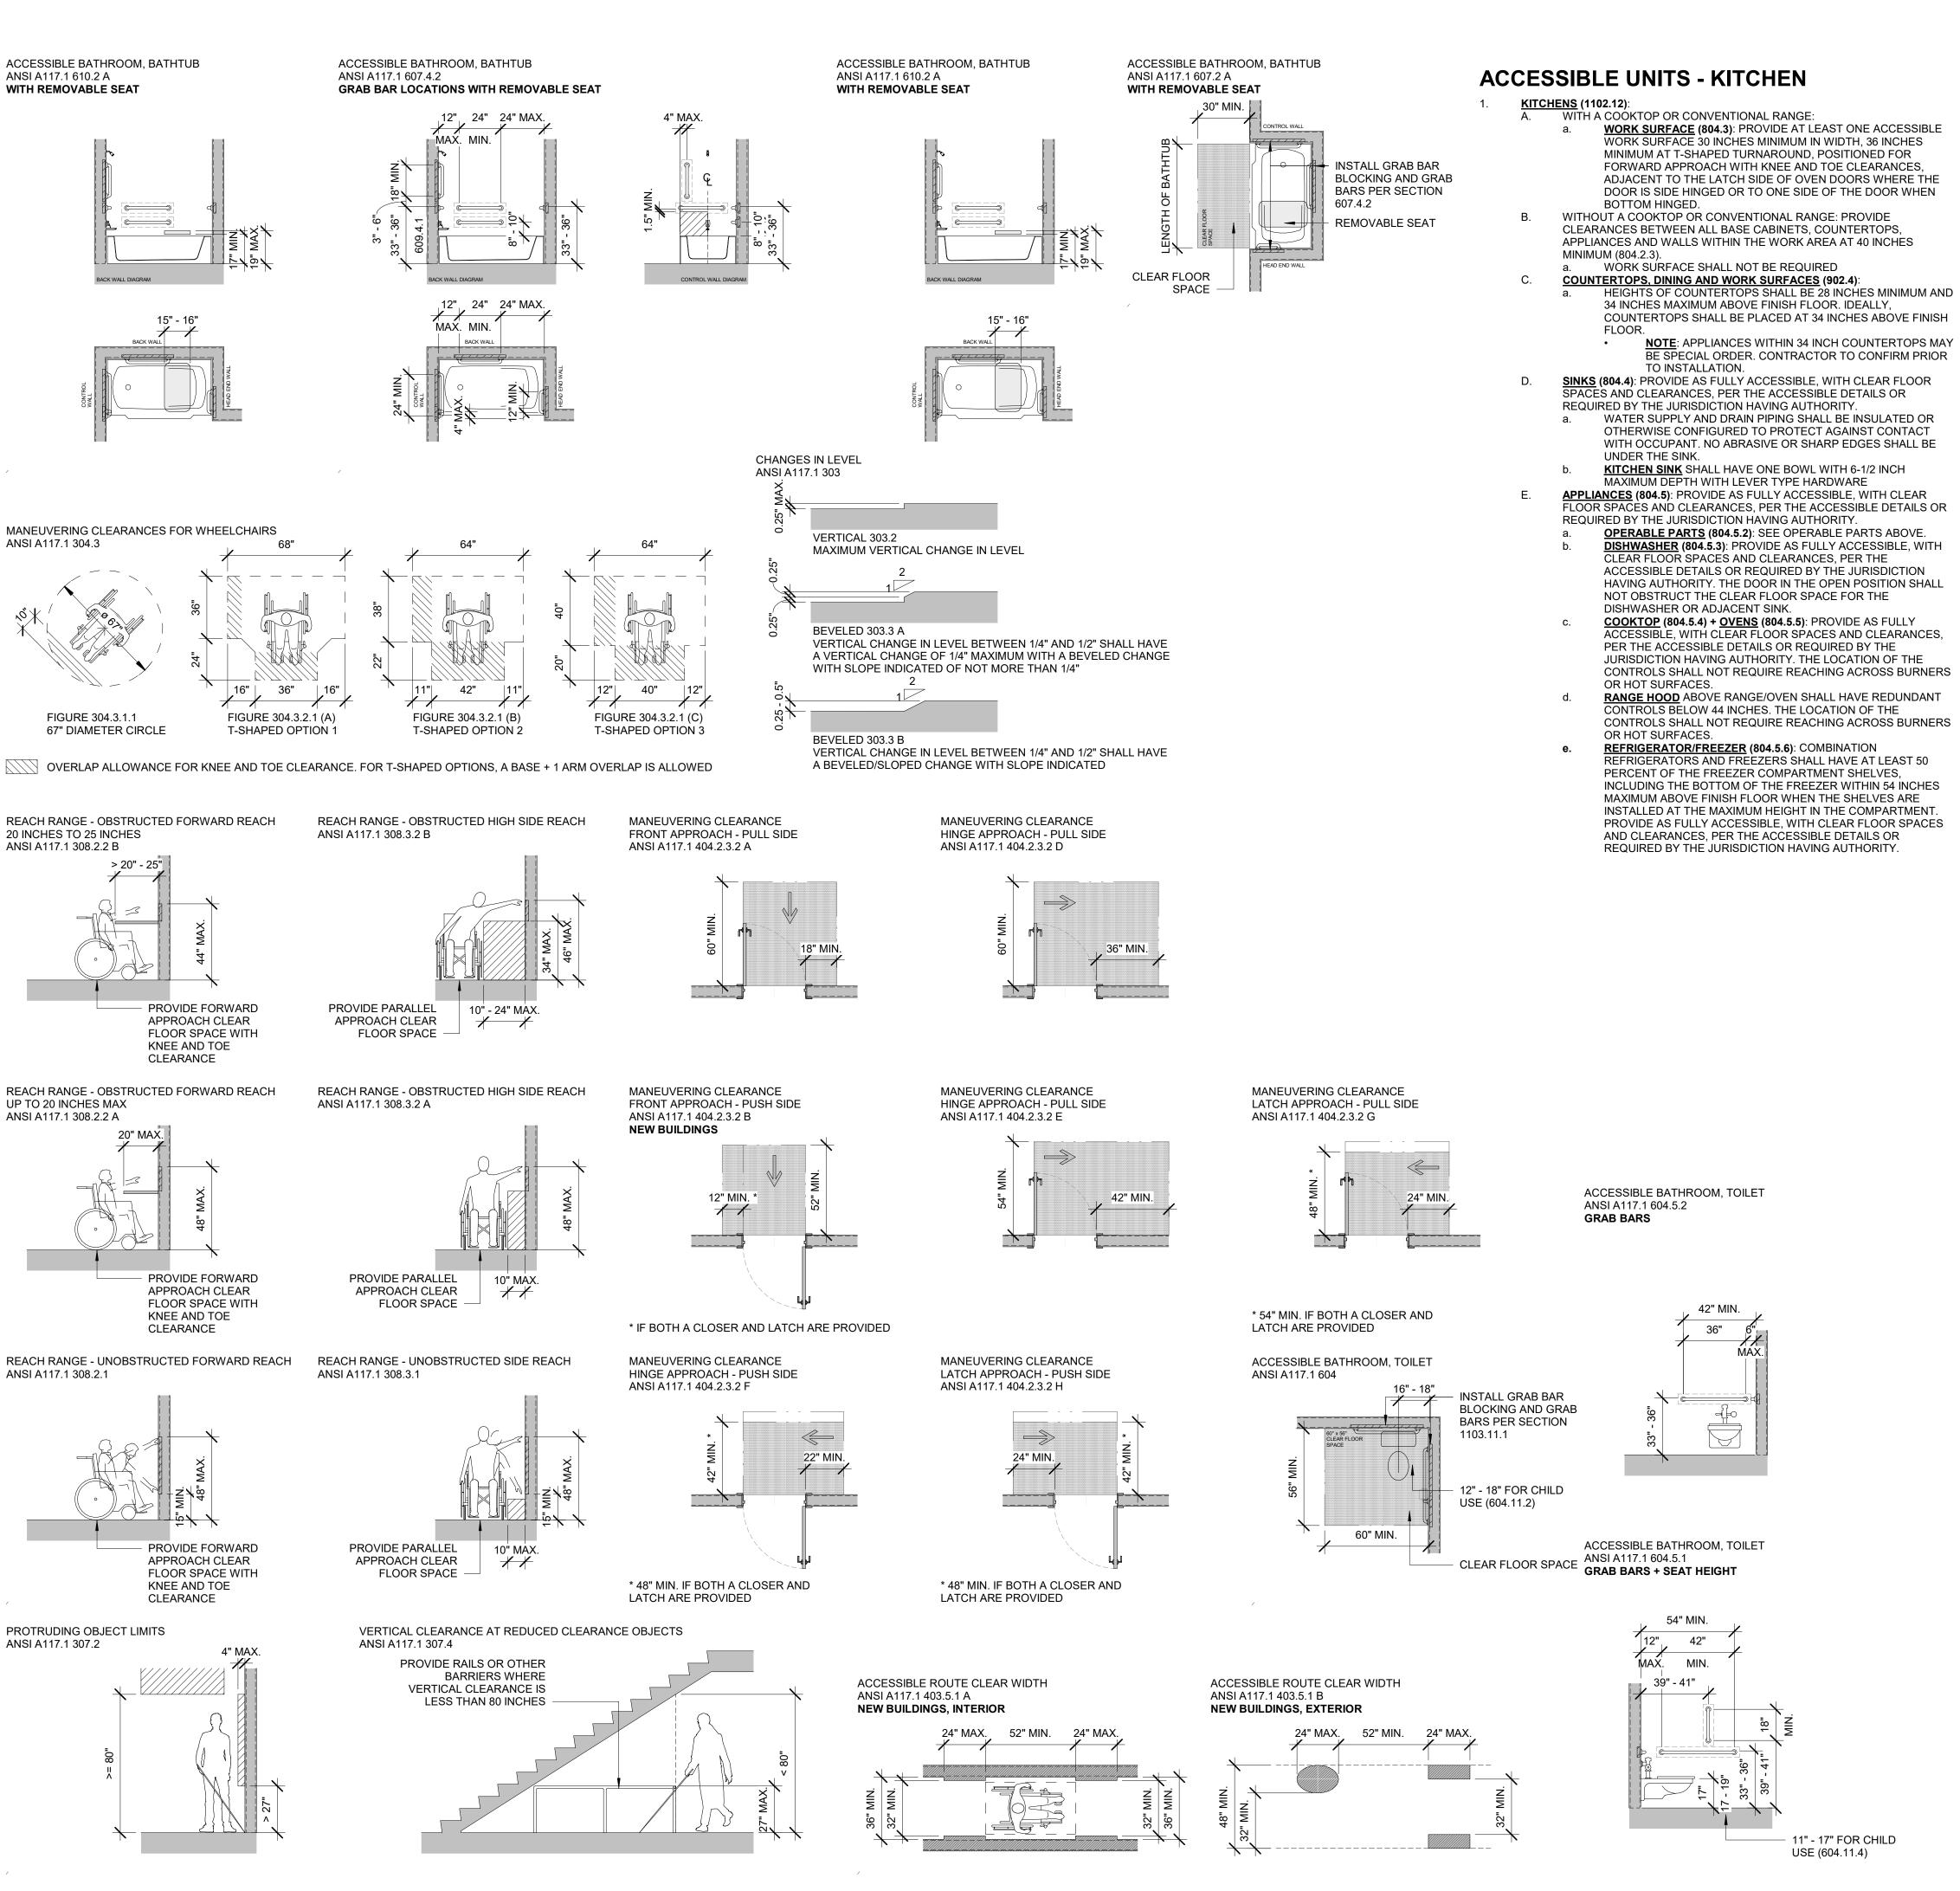

ACCESSIBLE UNITS - GENERAL

- PRIMARY ENTRANCE (1102.2) PROVIDE ON AN ACCESSIBLE ROUTE FROM PUBLIC AND COMMON SPACES. THE PRIMARY ENTRANCE SHALL NOT BE TO A BEDROOM UNLESS THE BEDROOM IS THE ONLY ENTRY POINT.
 ACCESSIBLE ROUTE + LOCATION (1102.3.1) PROVIDE AT LEAST ONE ACCESSIBLE ROUTE CONNECTING ALL SPACES AND ELEMENTS THAT ARE PART OF THE UNIT. THE ROUTE SHALL COINCIDE OR BE THE SAME AS THE
- GENERAL CIRCULATION PATH.

 3. TURNING SPACE (1102.3.2) PROVIDE A TURNING SPACE IN ALL ROOMS ALONG
- THE ACCESSIBLE ROUTE

 MALKING SURFACE (1102.4):

 A. FLOOR SURFACE (403.2): FLOOR SURFACES SHALL BE STABLE, FIRM,
- AND SLIP RESISTANT (302.1).

 B. SLOPE (403.3): MAXIMUM SLOPE SHALL BE 1:20; WITH A MAXIMUM SLOPE SHALL BE 1:20; WITH A MAXIMUM
- CROSS SLOPÉ OF 1:48.

 C. CHANGES IN LEVEL (403.4): VERTICAL CHANGES IN LEVEL OF 1/4 INCH MAXIMUM ARE PERMITTED (303.2); BEVELED CHANGES IN LEVEL OF 1/2 INCH MAXIMUM ARE PERMITTED IF THE INITIAL VERTICAL CHANGE IS 1/4

INCH PLUS A SLOPED AREA NOT MORE THAN 1:2 MAXIMUM IS

1:2 MAXIMUM. CHANGES IN LEVEL GREATER THAN 1/2 INCH ARE

PROVIDED, OR IF THE ENTIRE 1/2 INCH RISE IS SLOPED NOT MORE THAN

- CONSIDERED A RAMP.

 D. CLEAR WIDTH (403.5.1): INTERIOR MINIMUM CLEAR WIDTH SHALL BE 36 INCHES; EXTERIOR MINIMUM CLEAR WIDTH SHALL BE 48 INCHES.
- a. EXCEPTIONS COULD APPLY

 E. <u>CLEAR WIDTH AT 180 DEGREE TURNS</u> (403.5.2): SEE G032 FOR

 ACCESSIBLE ROUTES INFORMATION WHERE AN ACCESSIBLE ROUTE
- MAKES A 180-DEGREE TURN

 F. CLEAR WIDTH AT 90 DEGREE TURNS (403.5.3): SEE G032 FOR ACCESSIBLE ROUTES INFORMATION WHERE AN ACCESSIBLE ROUTE
- MAKES A 90-DEGREE TURN
 G. PASSING SPACE (403.5.4): SEE G032 FOR ACCESSIBLE ROUTES
- INFORMATION

 5. DOORS + DOORWAYS + OPENINGS (1102.5) PROVIDE THE PRIMARY ENTRANCE DOOR AND ALL OTHER DOORWAYS INTENDED FOR PASSAGE WITH
- CLEARANCES INDICATED IN DOOR DIAGRAMS (404)

 A. HARDWARE FOR DOORS SHALL BE MOUNTED 34 INCHES MINIMUM TO

 48 MAXIMUM ABOVE FINISH FLOOR OR GROUND SURFACE AND SHALL

 MEET THE OPERABLE PARTS REQUIREMENTS.
- 6. OPERABLE PARTS (1102.9) LIGHTING CONTROLS, ELECTRICAL PANELBOARDS, ELECTRICAL SWITCHES AND RECEPTACLE OUTLETS, ENVIRONMENTAL CONTROLS, APPLIANCE CONTROLS, PLUMBING FIXTURES CONTROLS AND USER CONTROLS FOR SECURITY OR INTERCOM SHALL BE PLACED WITHIN ONE OF THE CLEAR FLOOR SPACE DIAGRAMS INDICATED (305), WITH KNEE AND TOE CLEARANCE AS INDICATED (306), AND OUT OF THE AREA OF PROTRUDING OBJECTS (307), AND WITHIN ONE OF THE REACH RANGE DIAGRAMS (308). OPERABLE PARTS SHALL BE OPERABLE WITH ONE HAND AND SHALL NOT REQUIRE TIGHT GRASPING, PINCHING, OR TWISTING OF THE WRIST WITH A
- MAXIMUM FORCE TO ACTIVATE OF 5.0 POUNDS.

 7. WINDOWS (1102.13): WHERE OPERABLE WINDOWS ARE PROVIDED WITHIN A SPACE, AT LEAST ONE WINDOW SHALL BE PROVIDED AS ACCESSIBLE, WITH CLEAR FLOOR SPACE AND OPERABLE PARTS WITHIN REACH RANGES.

 A. SEE OPERABLE PARTS INFORMATION ABOVE.
 - a. EXCEPTIONS: 8.5 POUNDS MAXIMUM FORCE SHALL BE ALLOWED FOR VERTICAL OR HORIZONTAL SLIDING WINDOWS.

 B. EXCEPTIONS:
 - a. WINDOWS IN KITCHENS AND BATHROOMS SHALL NOT BE REQUIRED TO COMPLY.

 WINDOWS THAT ARE OPERATED ONLY BY EMPLOYEES
 - REQUIRED TO COMPLY.

 b. WINDOWS THAT ARE OPERATED ONLY BY EMPLOYEES.

 c. SKYLIGHTS.
- 8. STORAGE (1102.14): PROVIDE AS FULLY ACCESSIBLE, WITH CLEAR FLOOR SPACES AND CLEARANCES, REACH RANGES, AND OPERABLE PARTS PER THE ACCESSIBLE DETAILS OR REQUIRED BY THE JURISDICTION HAVING AUTHORITY.

 A. EXCEPTION: KITCHEN CABINETS ARE NOT REQUIRED TO COMPLY.

 B. CLOSET SHELVES SHALL BE WITHIN A REACH RANGE OF 15 TO 48
- INCHES FROM THE FINISH FLOOR TO THE TOP OF EACH SHELF (308).

 C. CLOSET CLOTHES RODS SHALL BE WITHIN THE REACH RANGE OF 44 INCHES TO THE TOP OF THE ROD (308).

 BEDS (1102.15.3): IF BEDS ARE PROVIDED, PROVIDE AT LEAST ONE BED AT 17
- TO 23 INCHES ABOVE FINISH FLOOR TO THE TOP OF THE UNCOMPRESSED MATTRESS.

REACH RANGES DO NOT APPLY TO THE FOLLOWING:

- ELECTRICAL RECEPTACLES SERVING A DEDICATED USE.
 FLOOR ELECTRICAL RECEPTACLES.
- 3. HVAC DIFFUSERS.
- 4. CONTROLS MOUNTED ON RANGE HOODS IF ACCESSIBLE REDUNDANT CONTROLS ARE PROVIDED.
- 5. CONTROLS MOUNTED ON CEILING FANS.

ACCESSIBLE UNITS - BATHROOMS

- 1. **TOILET AND BATHING FACILITIES, CLEAR FLOOR SPACE:** PROVIDE CLEAR FLOOR SPACE OR CLEARANCES PER THE ACCESSIBLE DETAILS OR REQUIRED BY THE JURISDICTION HAVING AUTHORITY.
- 2. TOILET AND BATHING FACILITIES (1102.11.2):

 A. AT LEAST ONE TOILET AND BATHING FACILITY INCLUDING AT LEAST ONE LAVATORY, ONE WATER CLOSET, AND EITHER A BATHTUB OR SHOWER SHALL BE LOCATED WITHIN THE SAME ROOM AND SHALL BE FULLY ACCESSIBLE, WITH CLEAR FLOOR SPACES AND CLEARANCES, PER THE ACCESSIBLE DETAILS OR REQUIRED BY THE JURISDICTION HAVING
- B. GRAB BARS AND SHOWER SEAT REINFORCEMENT (1102.11): ALL TOILET AND BATHING FACILITIES WITHIN THE UNIT NOT REQUIRED TO BE ACCESSIBLE SHALL HAVE GRAB BAR AND SHOWER SEAT REINFORCEMENT INSTALLED TO ALLOW FOR FUTURE INSTALLATION OF GRAB BARS OR SHOWER SEATS AT WATER CLOSETS, BATHTUBS, AND SHOWER COMPARTMENTS, OR AS INDICATED WITHIN THE INDICATED DETAILS (1104.11.1).
- a. EXCEPTIONS MAY APPLY (1104.11.1)

 C. LAVATORY: PROVIDE CLEAR FLOOR SPACE OR CLEARANCES PER THE ACCESSIBLE DETAILS OR REQUIRED BY THE JURISDICTION HAVING AUTHORITY.
 - a. ACCESSIBLE UNITS SHALL HAVE EQUIVALENT COUNTERTOP SPACE, IN TERMS OF SIZE AND PROXIMITY TO THE LAVATORY, AS NON-ACCESSIBLE UNITS (1102.11.2.1).
- b. WATER SUPPLY AND DRAIN PIPING SHALL BE INSULATED OR OTHERWISE CONFIGURED TO PROTECT AGAINST CONTACT WITH OCCUPANT. NO ABRASIVE OR SHARP EDGES SHALL BE UNDER THE LAVATORY.
- D. MIRRORS (1102.11.2.2): MIRRORS SHALL BE MOUNTED SUCH THAT THE BOTTOM EDGE OF THE REFLECTING SURFACE IS 40 INCHES MAXIMUM ABOVE FINISHED FLOOR.
- E. WATER CLOSET: PROVIDE AS FULLY ACCESSIBLE, WITH CLEAR FLOOR SPACES AND CLEARANCES, PER THE ACCESSIBLE DETAILS OR REQUIRED BY THE JURISDICTION HAVING AUTHORITY
- REQUIRED BY THE JURISDICTION HAVING AUTHORITY.

 F. BATHING FIXTURES, BATHTUB: PROVIDE AS FULLY ACCESSIBLE, WITH CLEAR FLOOR SPACES AND CLEARANCES, PER THE ACCESSIBLE

DETAILS OR REQUIRED BY THE JURISDICTION HAVING AUTHORITY.

- G. BATHING FIXTURES, SHOWER: PROVIDE AS FULLY ACCESSIBLE, WITH CLEAR FLOOR SPACES AND CLEARANCES, PER THE ACCESSIBLE DETAILS OR REQUIRED BY THE JURISDICTION HAVING AUTHORITY.

 a. SHOWER SPRAY UNIT SHALL HAVE MINIMUM 59 INCH HOSE (607).
- H. TOILET PAPER DISPENSER (604.7): MOUNT 7 TO 9 INCHES MAXIMUM IN FRONT OF THE TOILET

STATE OF MISSOURI MICHAEL L. PARSON, GOVERNOR



hdesigngroup

OFFICE OF ADMINISTRATION DIVISION OF FACILITIES MANAGEMENT, DESIGN AND CONSTRUCTION

DEPARTMENT OF NATURAL RESOURCES MISSOURI STATE PARKS

TABLE ROCK STATE PARK REPLACE 5 BASIC SITES WITH 5 PREMIUM YURTS

TABLE ROCK STATE PARK CAMPGROUND #2 5272 STATE HWY 165

5272 STATE HWY 165 BRANSON, MISSOURI 65616

PROJECT # X2215-01 SITE # 5603 ASSET # 7815603018

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ISSUE DATE: JANUARY 17, 2023


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CHECKED BY: HDG
DESIGNED BY: HDG

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SHEET NUMBER:

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SHEET <u>4</u> OF <u>32</u> 1/17/2023 9:09:27 AM



NOTE

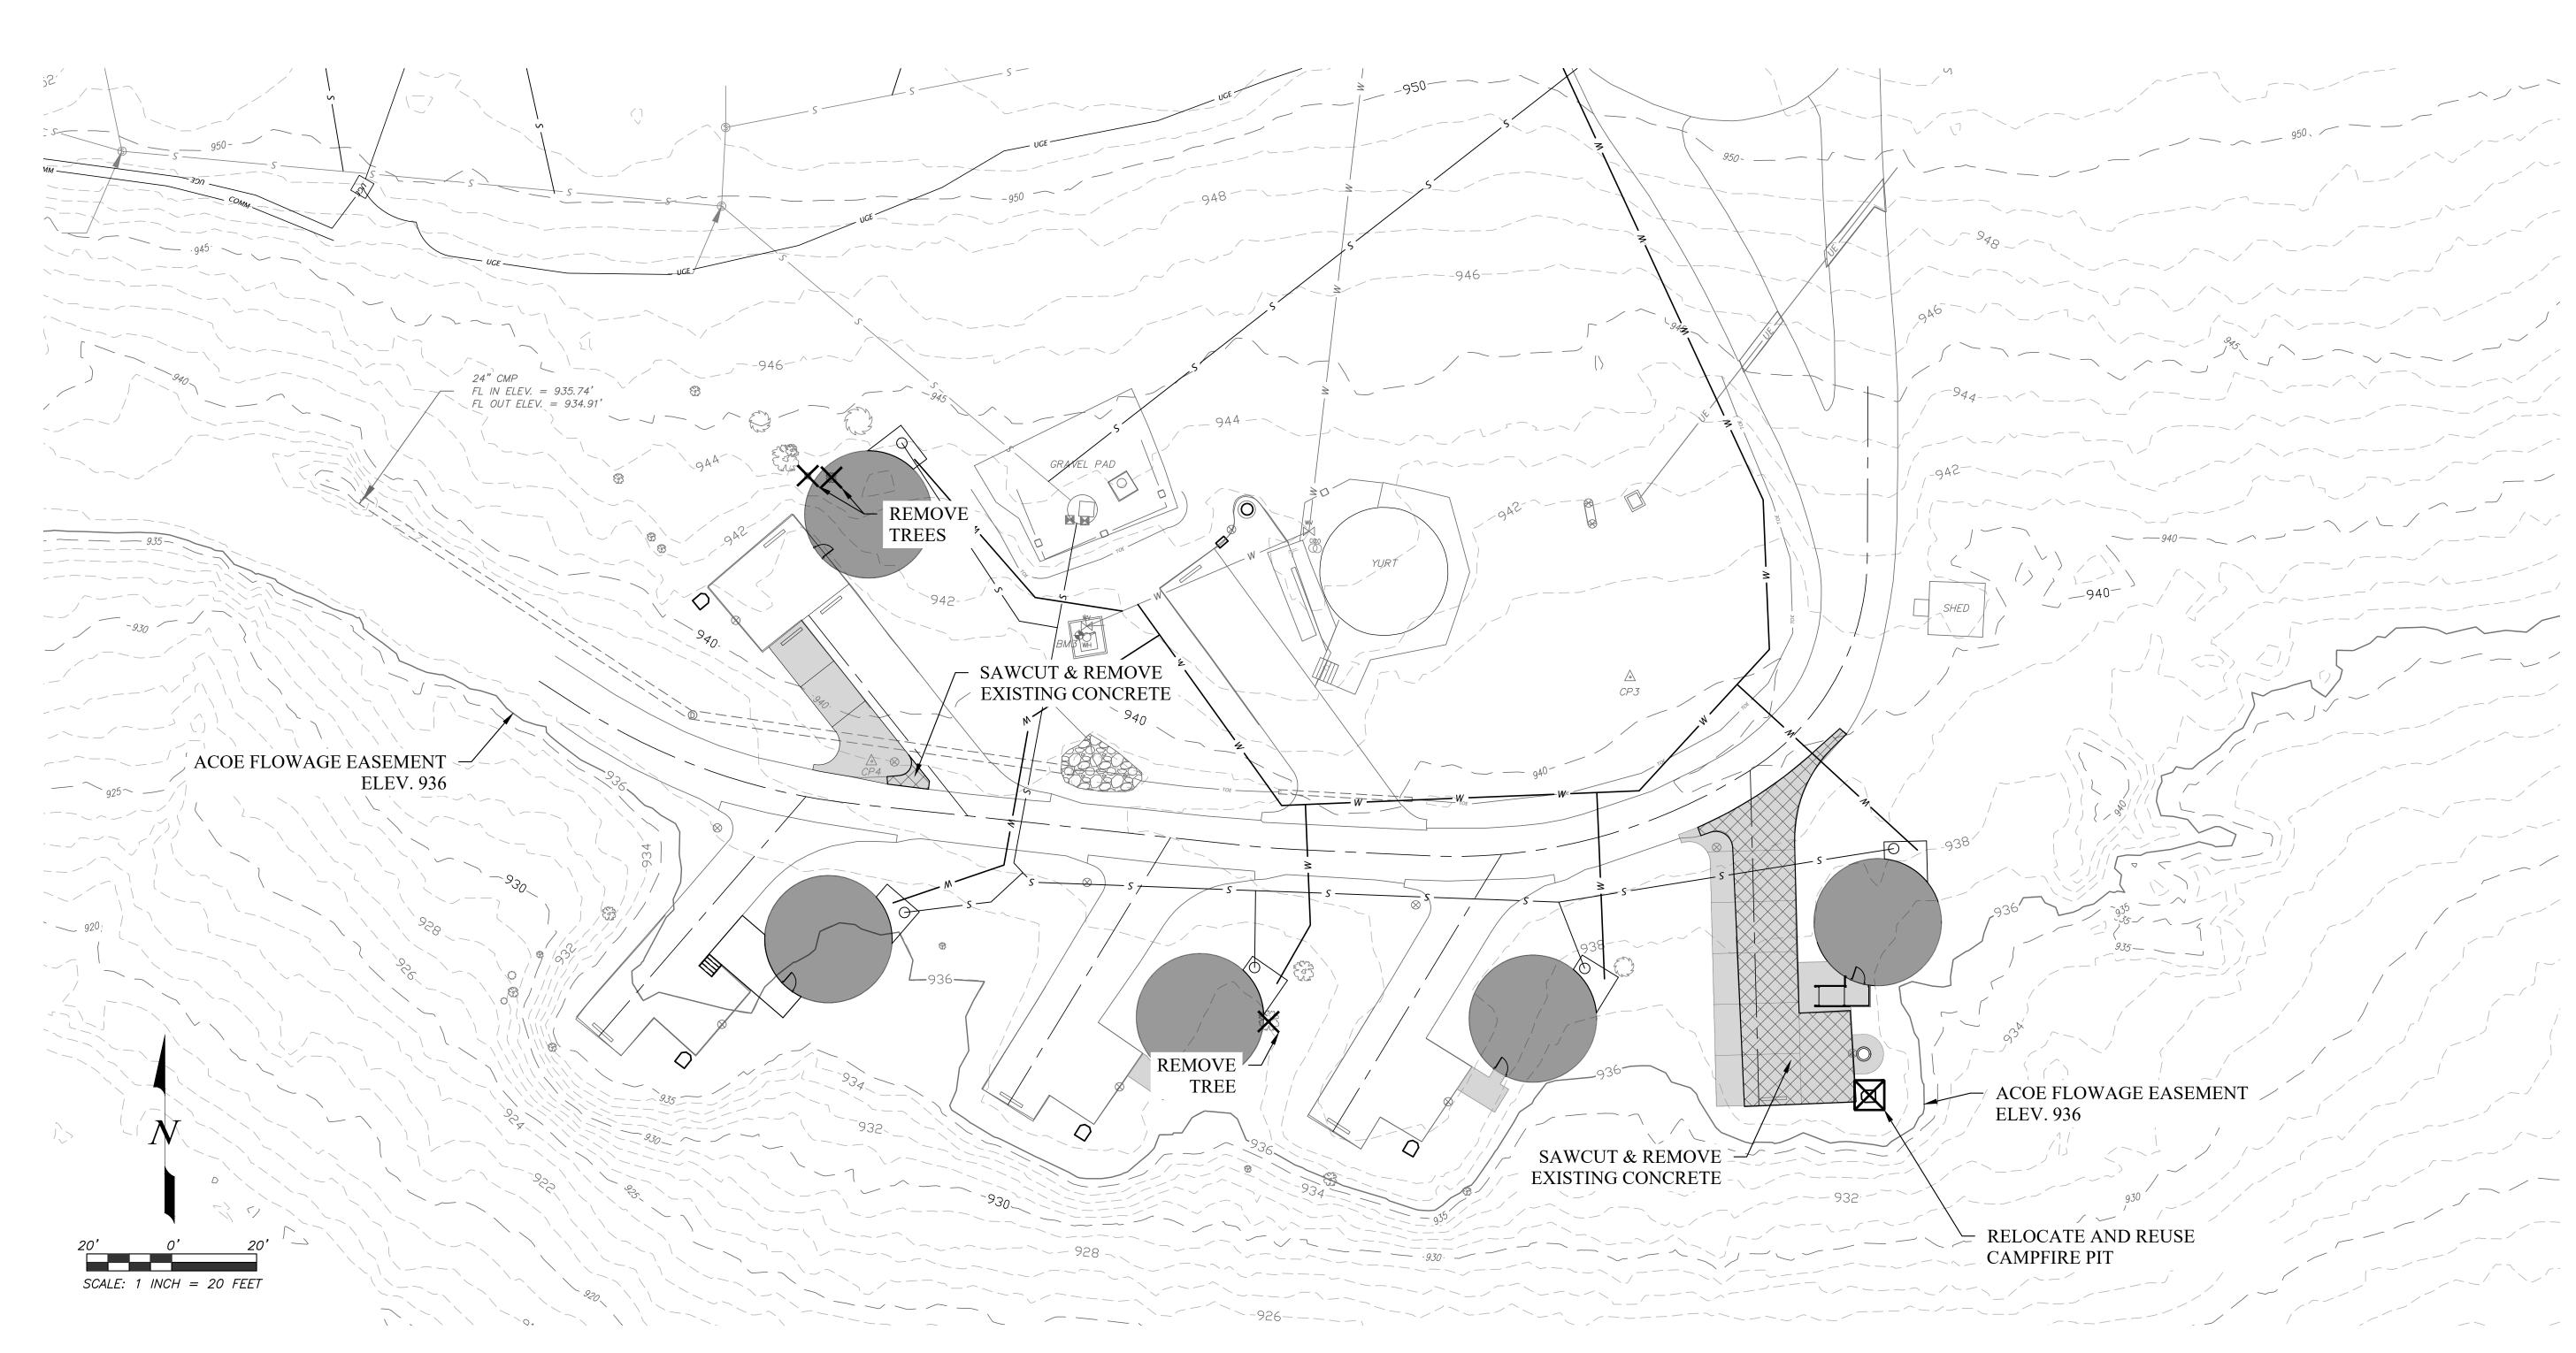- 1. CONTRACTOR SHALL REMOVE ALL DEMOLITION MATERIAL FROM THE SITE AND DISPOSE OF IT IN ACCORDANCE WITH APPLICABLE FEDERAL, STATE AND LOCAL REGULATIONS. NO SEPARATE PAYMENT WILL BE MADE FOR DISPOSAL
- 2.LIGHT POLE, PULL BOXES AND BASES WITHIN THE LIMITS OF THE NEW WORK SHALL BE REMOVED AND DISPOSED OF IN ACCORDANCE WITH THE ABOVE UNLESS OTHERWISE NOTED. REMOVE WIRE TO A MINIMUM OF 12" BELOW GRADE AND ABANDON UNDERGROUND WIRE IN PLACE. BACKFILL AND COMPACT ALL VOIDS.
- 3. RELOCATE HYDRANTS, METERS AND OTHER UTILITY STRUCTURES AND ELEMENTS OUT OF THE NEW PAVEMENT AS INDICATED. ADJUST UTILITY ELEMENTS TO REMAIN TO FINISH GRADE.
- 4. CONTRACTOR IS RESPONSIBLE FOR ALL DEMOLITION, DISPOSAL, DNR AND ALL OTHER PERMITS NECESSARY TO COMPLETE THE WORK.
- 5. BLASTING AND BURNING ARE PROHIBITED.
- 6. CONTRACTOR SHALL REMOVE OTHER SITE ELEMENTS WHICH ARE NOT INTENDED FOR DEMOLITION, BUT ARE OBSTACLES TO CONSTRUCTION AND STORE THEM SAFELY DURING THE PROGRESS OF THE WORK. REINSTALL THE TEMPORARILY REMOVED ITEMS TO ORIGINAL LOCATION AND CONDITION. REPLACE ANY DAMAGED ELEMENTS. THERE WILL BE NO ADDITIONAL PAYMENT FOR REPLACEMENT.
- 7. ALL PAVEMENT AND SIDEWALK REMOVALS SHALL BE MADE TO A CLEAN AND UNIFORM SAWCUT FACE. REMOVE TO AN EXISTING CONSTRUCTION OR EXPANSION JOINT IF WITHIN 3' OF THE PROPOSED SAWCUT.
- 8. ABANDON EXISTING PIPES, VAULTS AND OTHER UNDERGROUND STRUCTURES BY COMPLETELY REMOVING THEM OR BY COMPLETELY FILLING THE BURIED STRUCTURE WITH SAND AND OR LOW STRENGTH CONCRETE SLURRY.
- 9. ALL DEMOLITION IS PART OF THE BASE BID.
- 10. NO OPEN CUTTING OF ASPHALT ROADWAY IS ALLOWED. ALL UTILITES BENEATH PRIMARY ASPHALT ROADWAY SHALL BE BORED.

LEGEND:



SAWCUT AND REMOVE PAVEMENT



LINEAR ITEMS TO BE REMOVED (FENCES, CURBING, ETC.)



TREE TO BE REMOVED



UTILITIES TO BE RELOCATED OR **ADJUSTED**




STRUCTURE TO BE RELOCATED OR ADJUSTED



GROUP OF TREES TO BE REMOVED

STATE OF MISSOURI MICHAEL L. PARSON, **GOVERNOR**



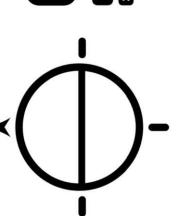

OFFICE OF ADMINISTRATION DIVISION OF FACILITIES MANAGEMENT, **DESIGN AND CONSTRUCTION**

DEPARTMENT OF NATURAL RESOURCES MISSOURI STATE PARKS

TABLE ROCK STATE PARK REPLACE 5 BASIC SITES WITH 5 PREMIUM YURTS

TABLE ROCK STATE PARK CAMPGROUND #2 5272 STATE HWY 165 BRANSON, MISSOURI 65616

03018

PROJECT # X2215-01

REVISION: DATE:

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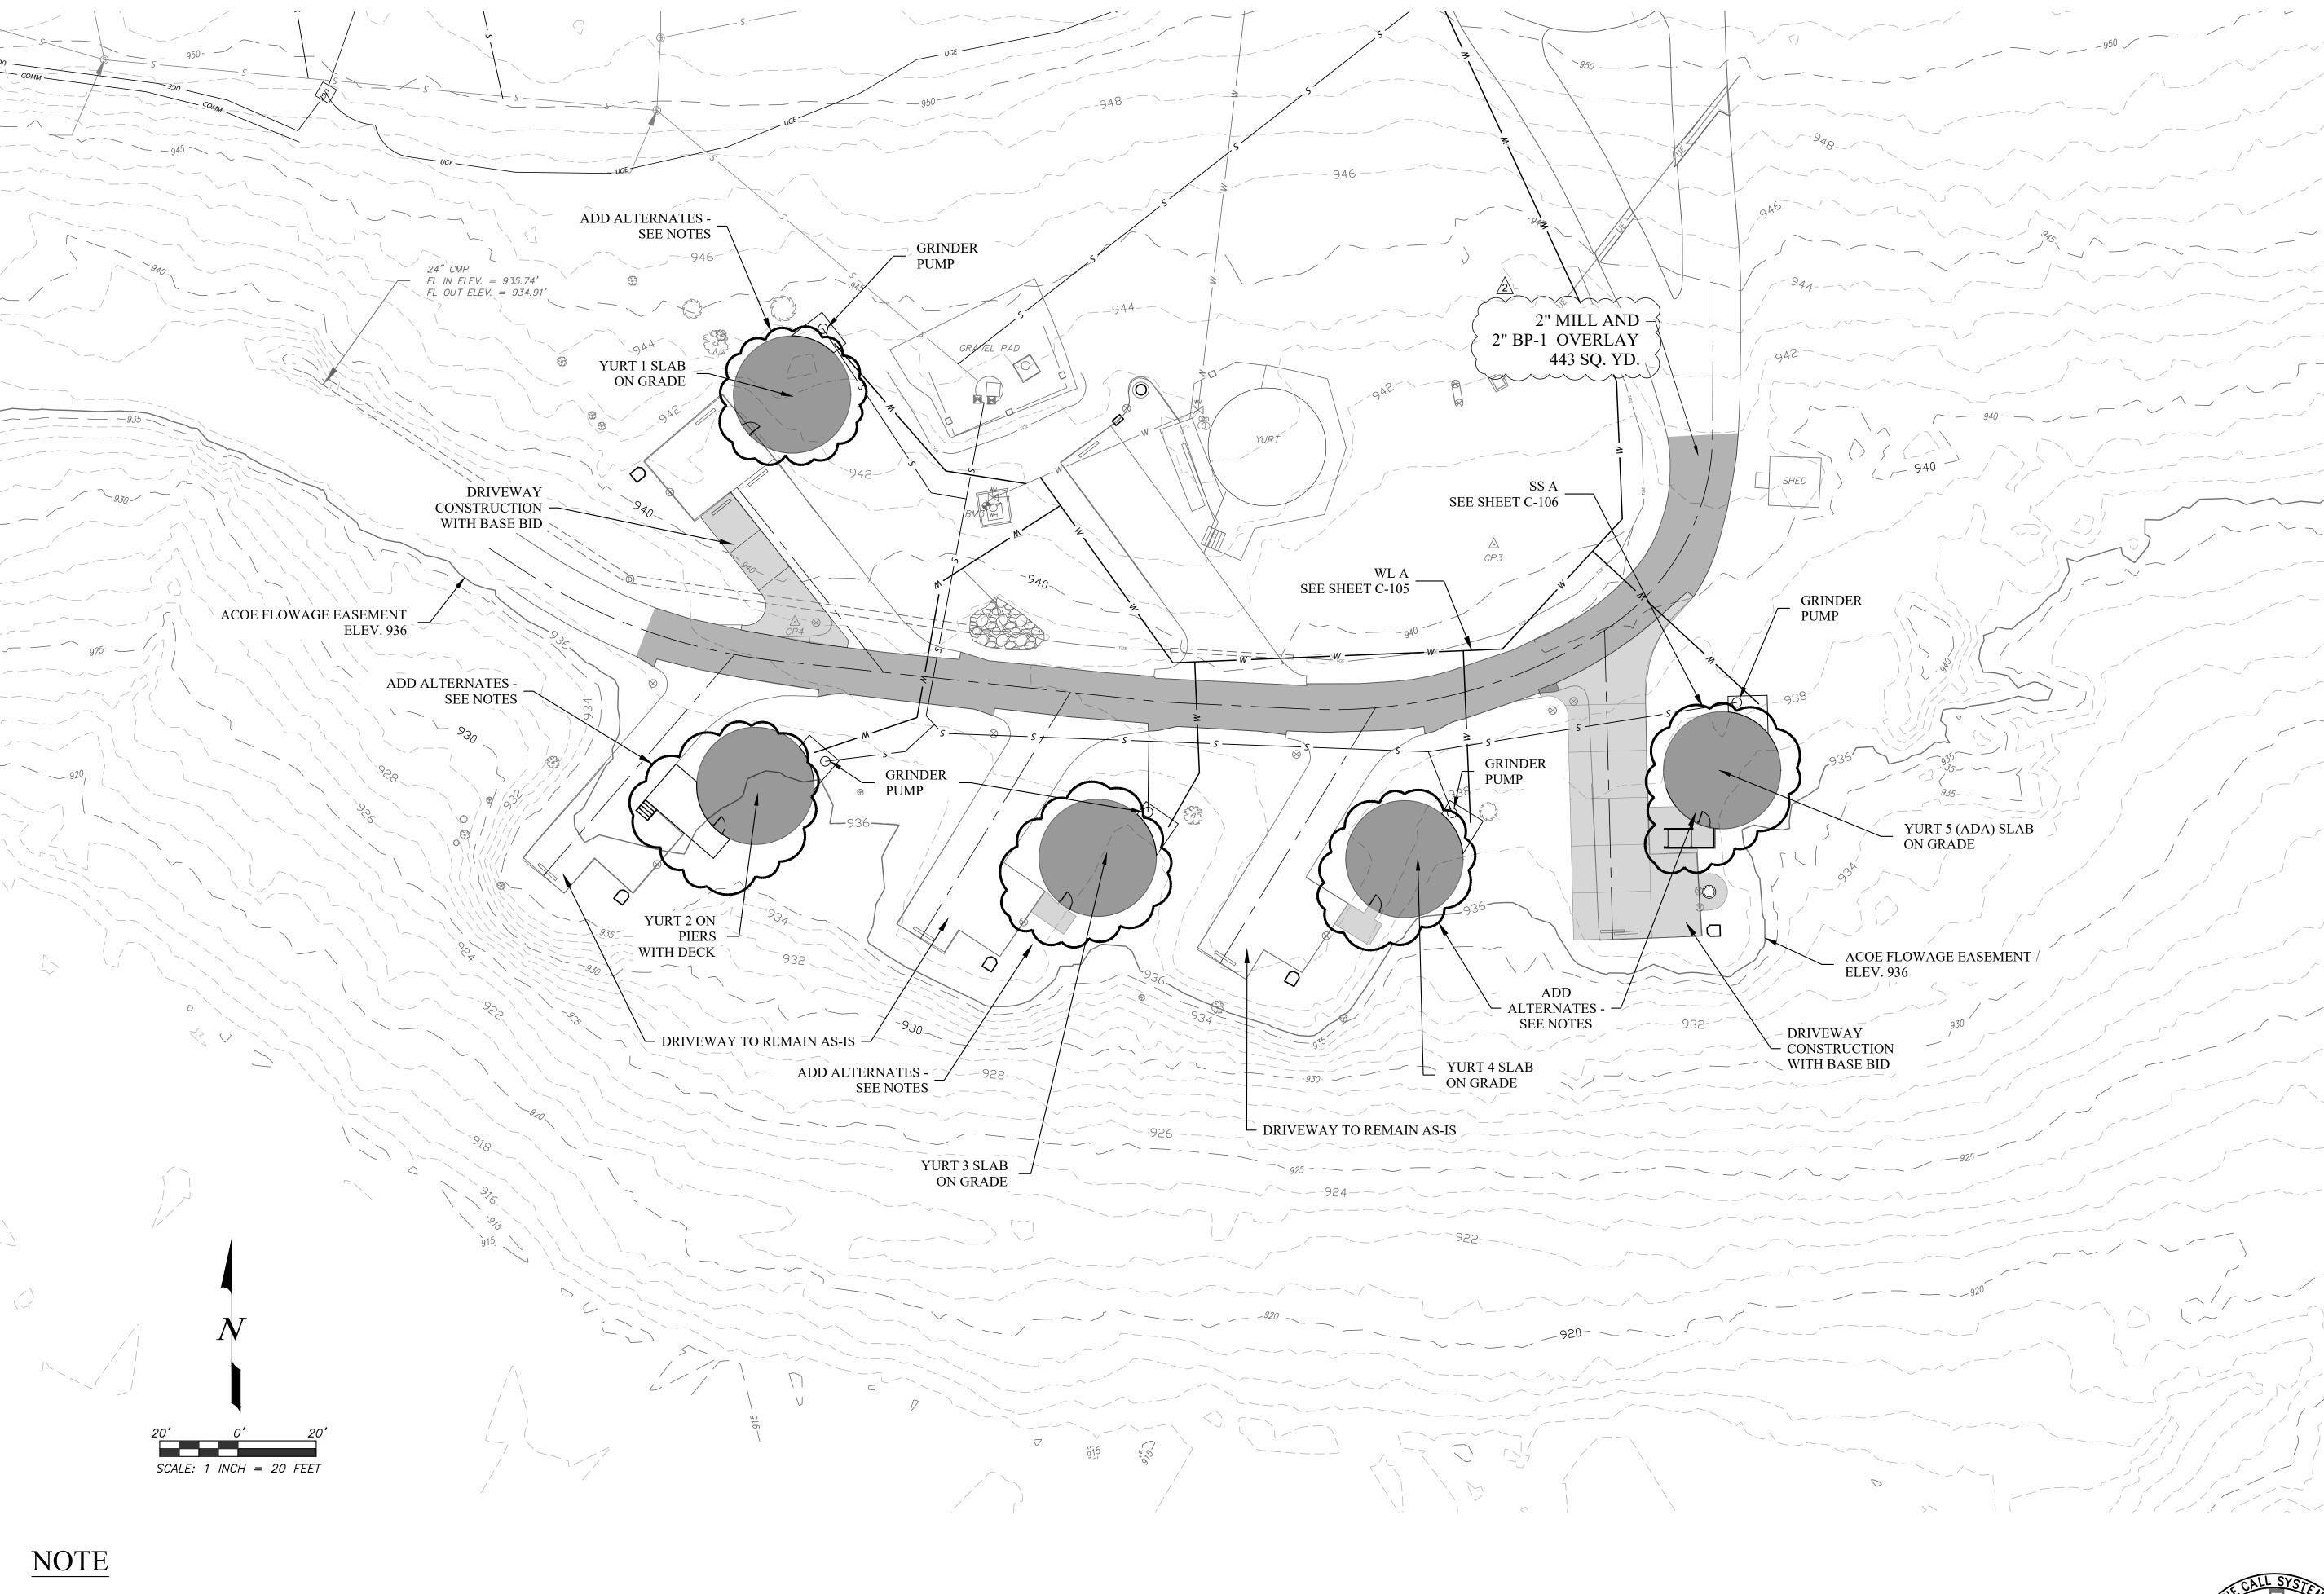
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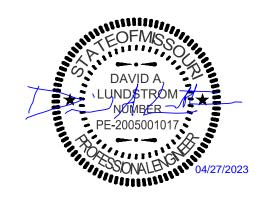
DEMOLITION PLAN AND EXISTING CONDITIONS

SHEET NUMBER:



- 1. BASE BID INCLUDES ALL SITE WORK, DRIVEWAY REPLACEMENT/EXPANSION, AND UTILITIES.
- 2. ADD ALTERNATE #1 INCLUDES DECK MATERIAL AND CONCRETE SLABS FOR YURT FOUNDATIONS AS WELL AS YURT UTILITY SERVICE ROUGH-INS. SEE MEP PLANS FOR DETAILS.
- 3. ADD ALTERNATE #2 INCLUDES THE BASE YURT STRUCTURE AND MATERIAL. SEE ARCHITECTURAL PLANS FOR DETAILS.
- 4. ADD ALTERNATE #3 INCLUDES THE INTERIOR FIXTURES AND FINISHES FOR THE YURTS. SEE ARCHITECTURAL PLANS FOR DETAILS.





GREAT RIVER

OFFICE OF ADMINISTRATION DIVISION OF FACILITIES MANAGEMENT, DESIGN AND CONSTRUCTION

DEPARTMENT OF NATURAL RESOURCES MISSOURI STATE PARKS

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TABLE ROCK STATE PARK CAMPGROUND #2 5272 STATE HWY 165 BRANSON, MISSOURI 65616

PROJECT # X2215-01 SITE # 5603 ASSET # 03018

REVISION: REV. 2 - ADDENDUM 2
DATE: 04/27/2023
REVISION:
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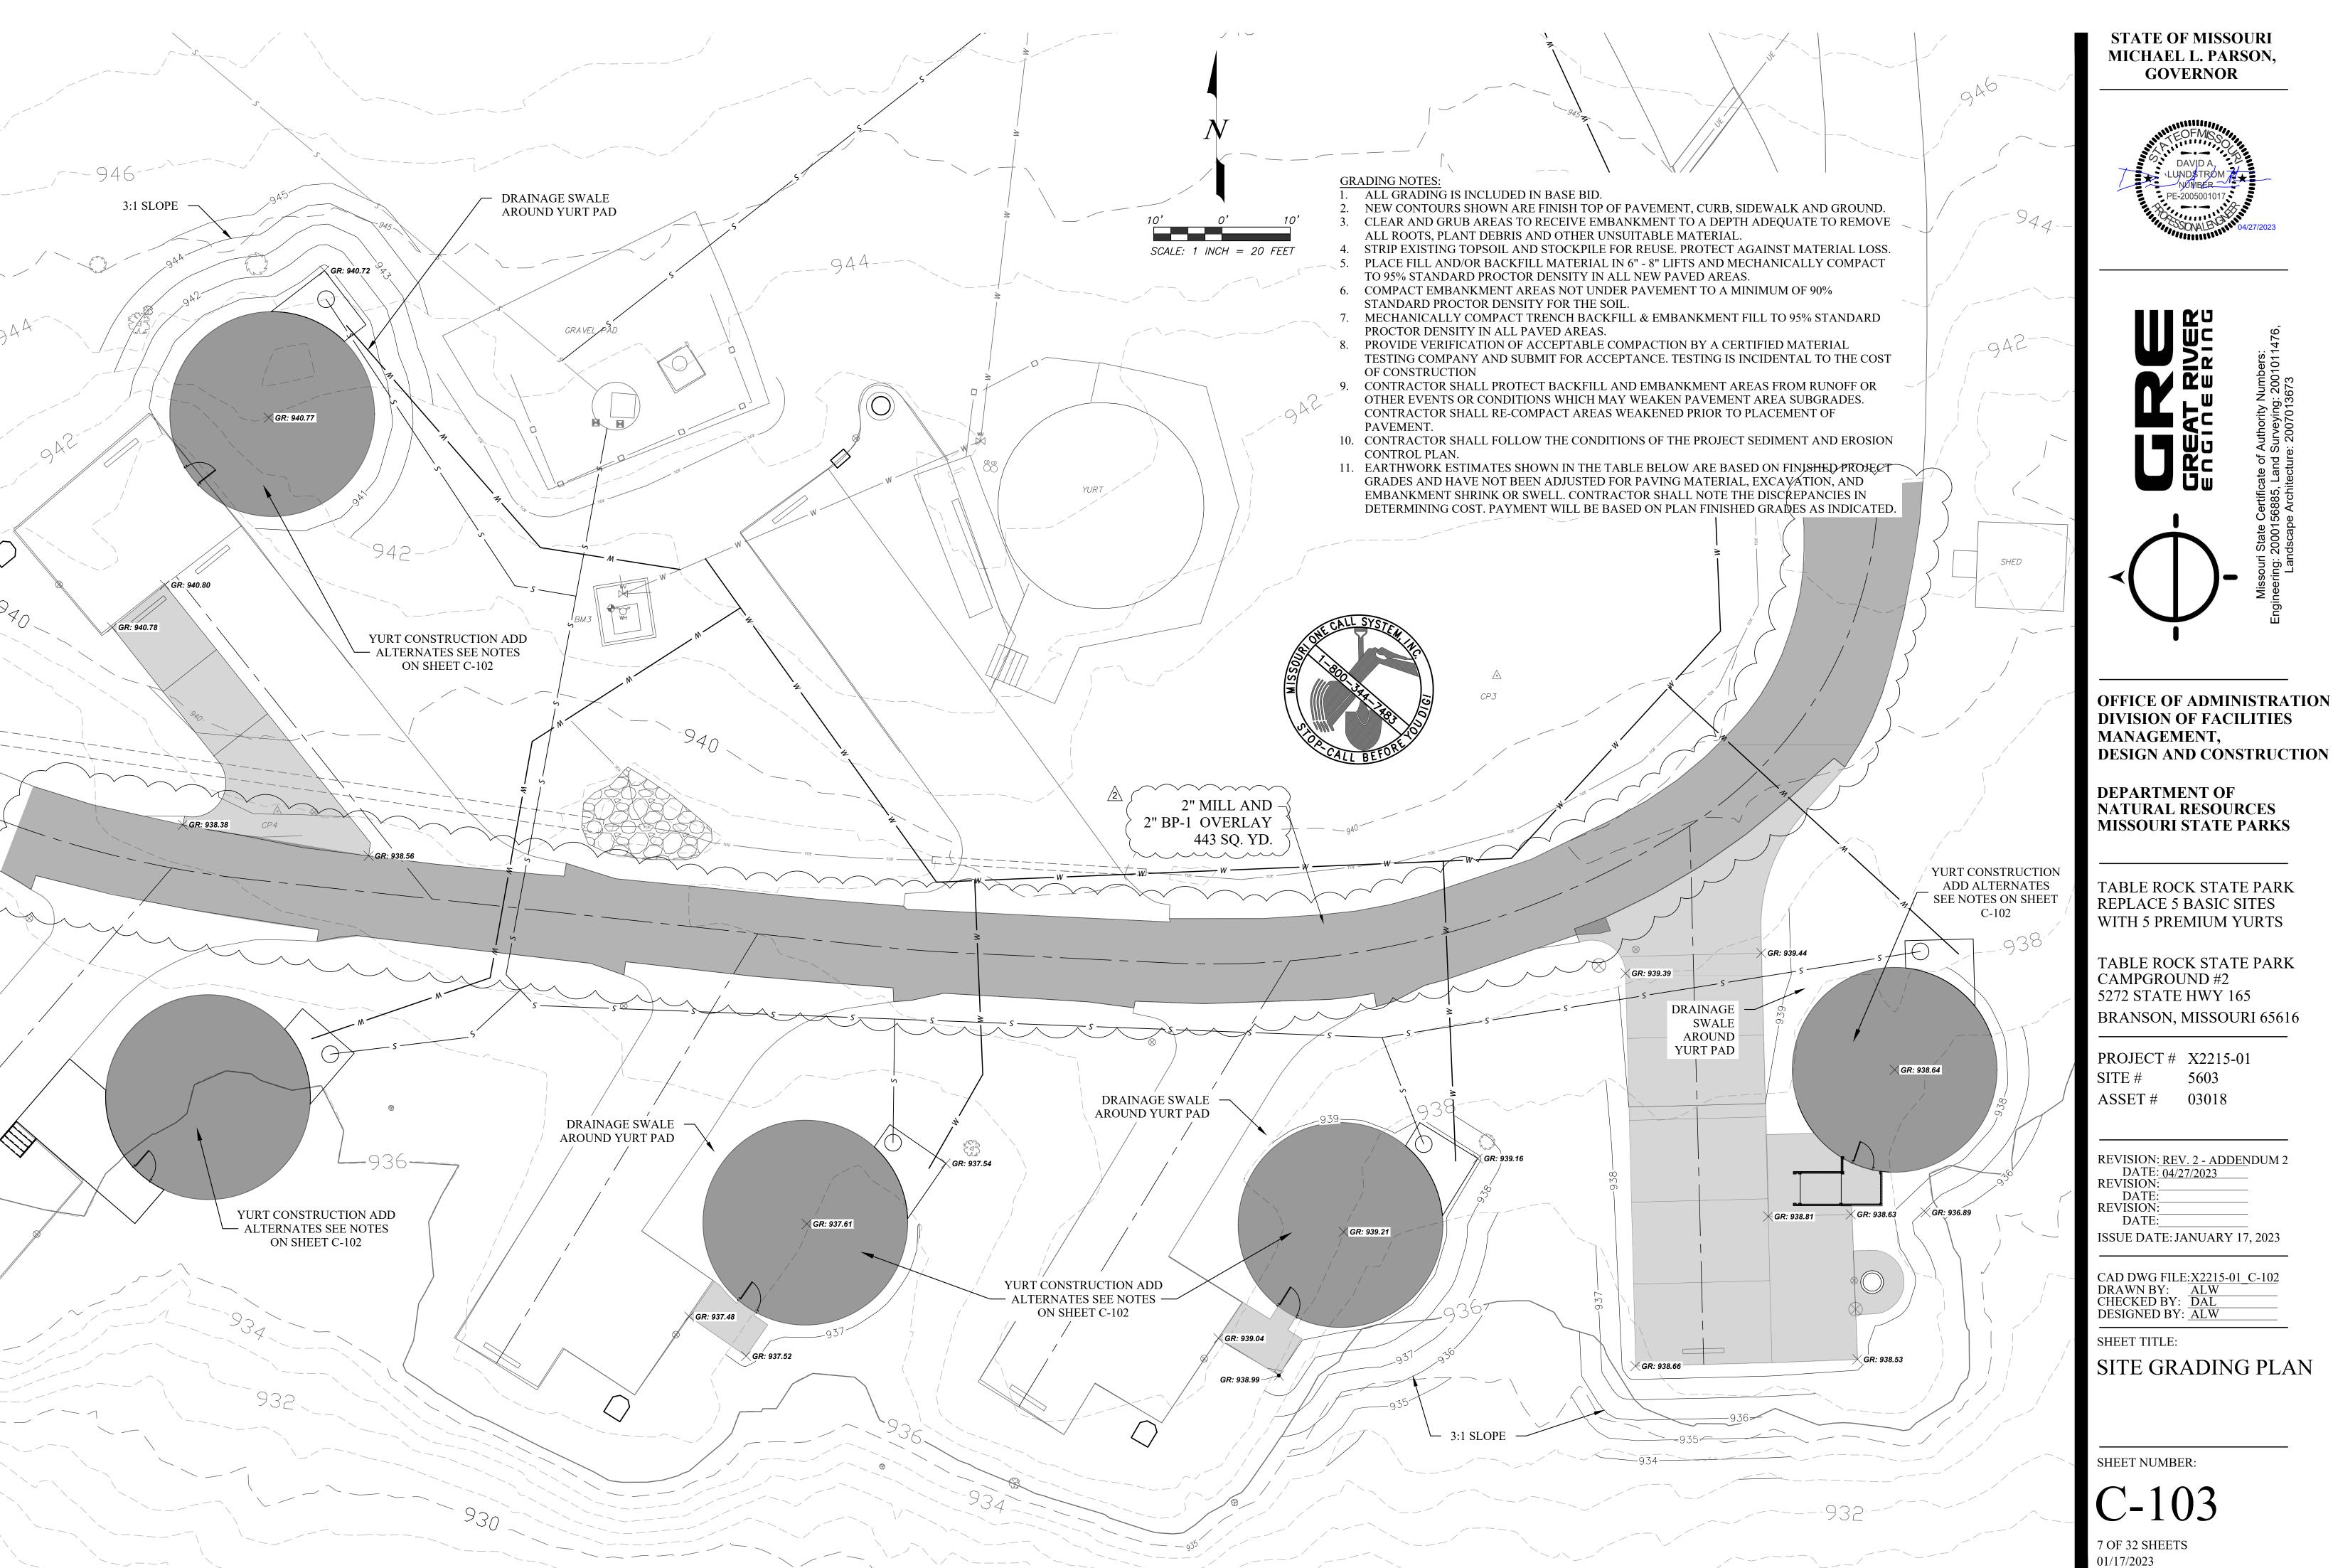
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SITE PLAN

SHEET NUMBER:

C-102

6 OF 32 SHEETS 01/17/2023



MICHAEL L. PARSON,



OFFICE OF ADMINISTRATION DIVISION OF FACILITIES

DEPARTMENT OF NATURAL RESOURCES MISSOURI STATE PARKS

TABLE ROCK STATE PARK REPLACE 5 BASIC SITES WITH 5 PREMIUM YURTS

TABLE ROCK STATE PARK 5272 STATE HWY 165

PROJECT # X2215-01

REVISION: REV. 2 - ADDENDUM 2


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SITE GRADING PLAN







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DEPARTMENT OF NATURAL RESOURCES MISSOURI STATE PARKS
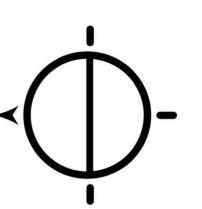
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PROJECT # X2215-01 03018 ASSET#

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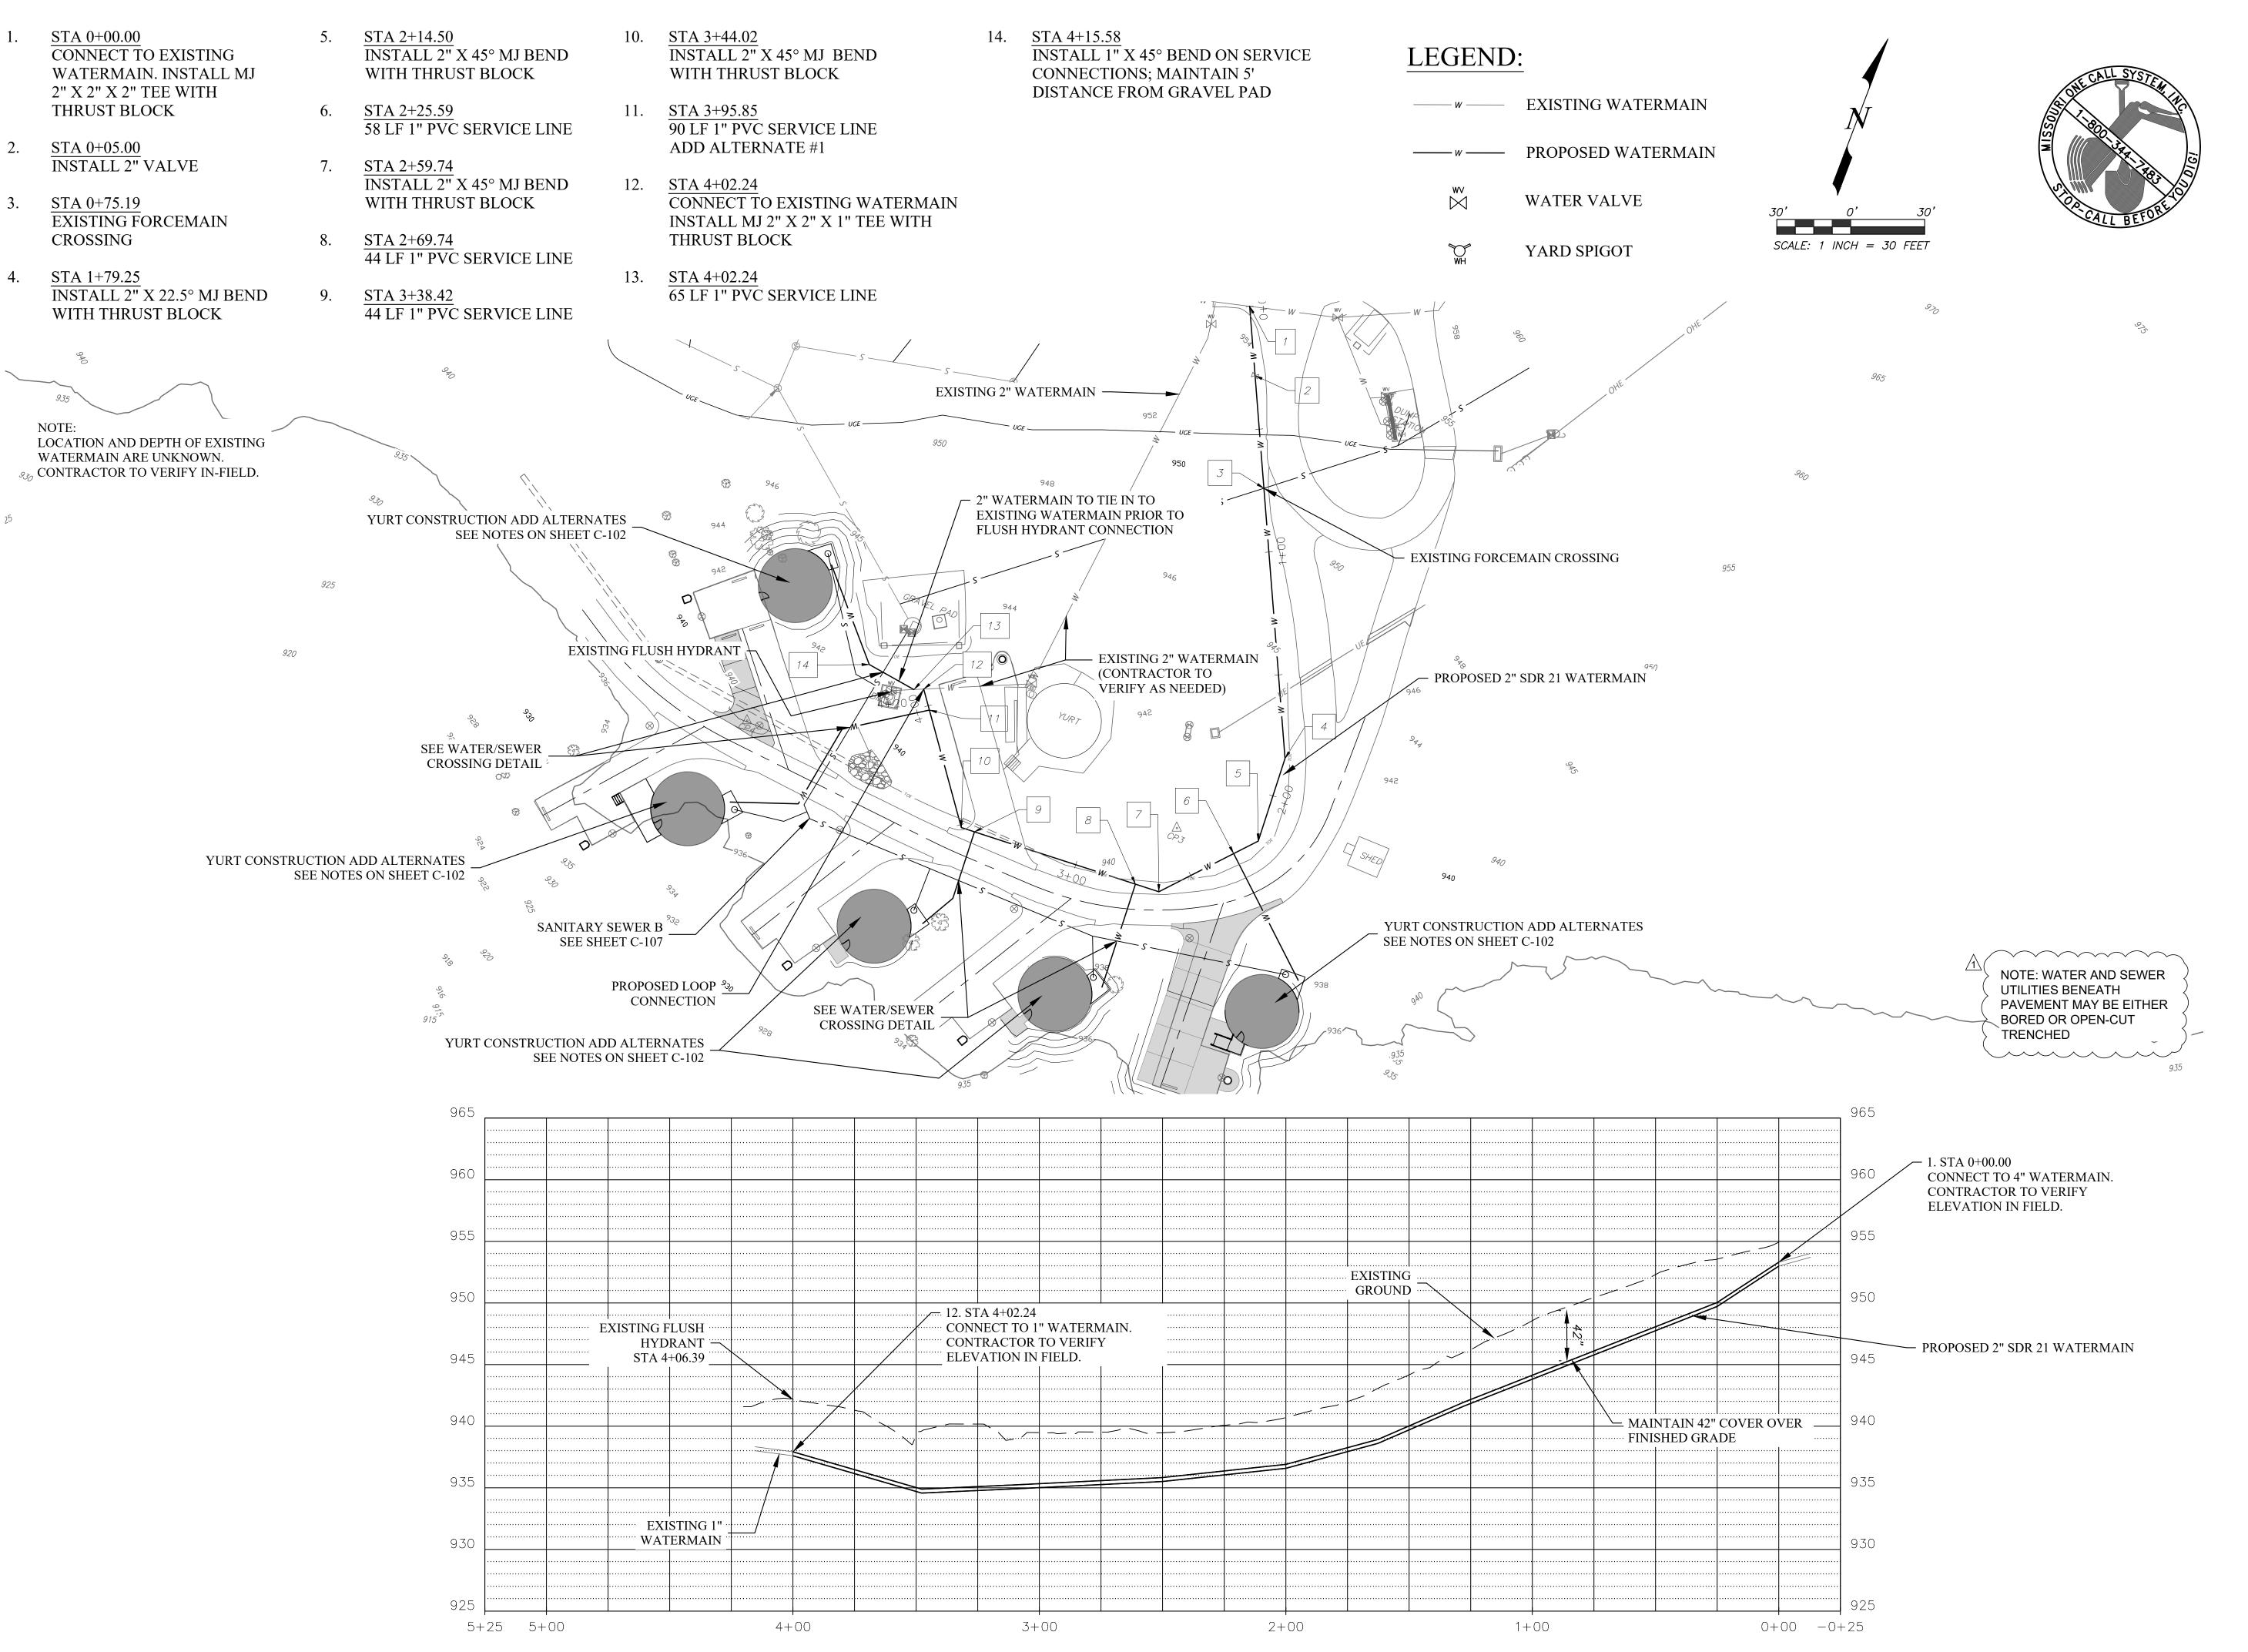
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ADA GRADING PLAN

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OFFICE OF ADMINISTRATION DIVISION OF FACILITIES MANAGEMENT, DESIGN AND CONSTRUCTION

DEPARTMENT OF NATURAL RESOURCES MISSOURI STATE PARKS

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TABLE ROCK STATE PARK CAMPGROUND #2 5272 STATE HWY 165 BRANSON, MISSOURI 65616

03018

PROJECT # X2215-01 SITE # 5603

ASSET#

REVISION: REV. 1 - ADDENDUM 1
DATE: 04/20/2023
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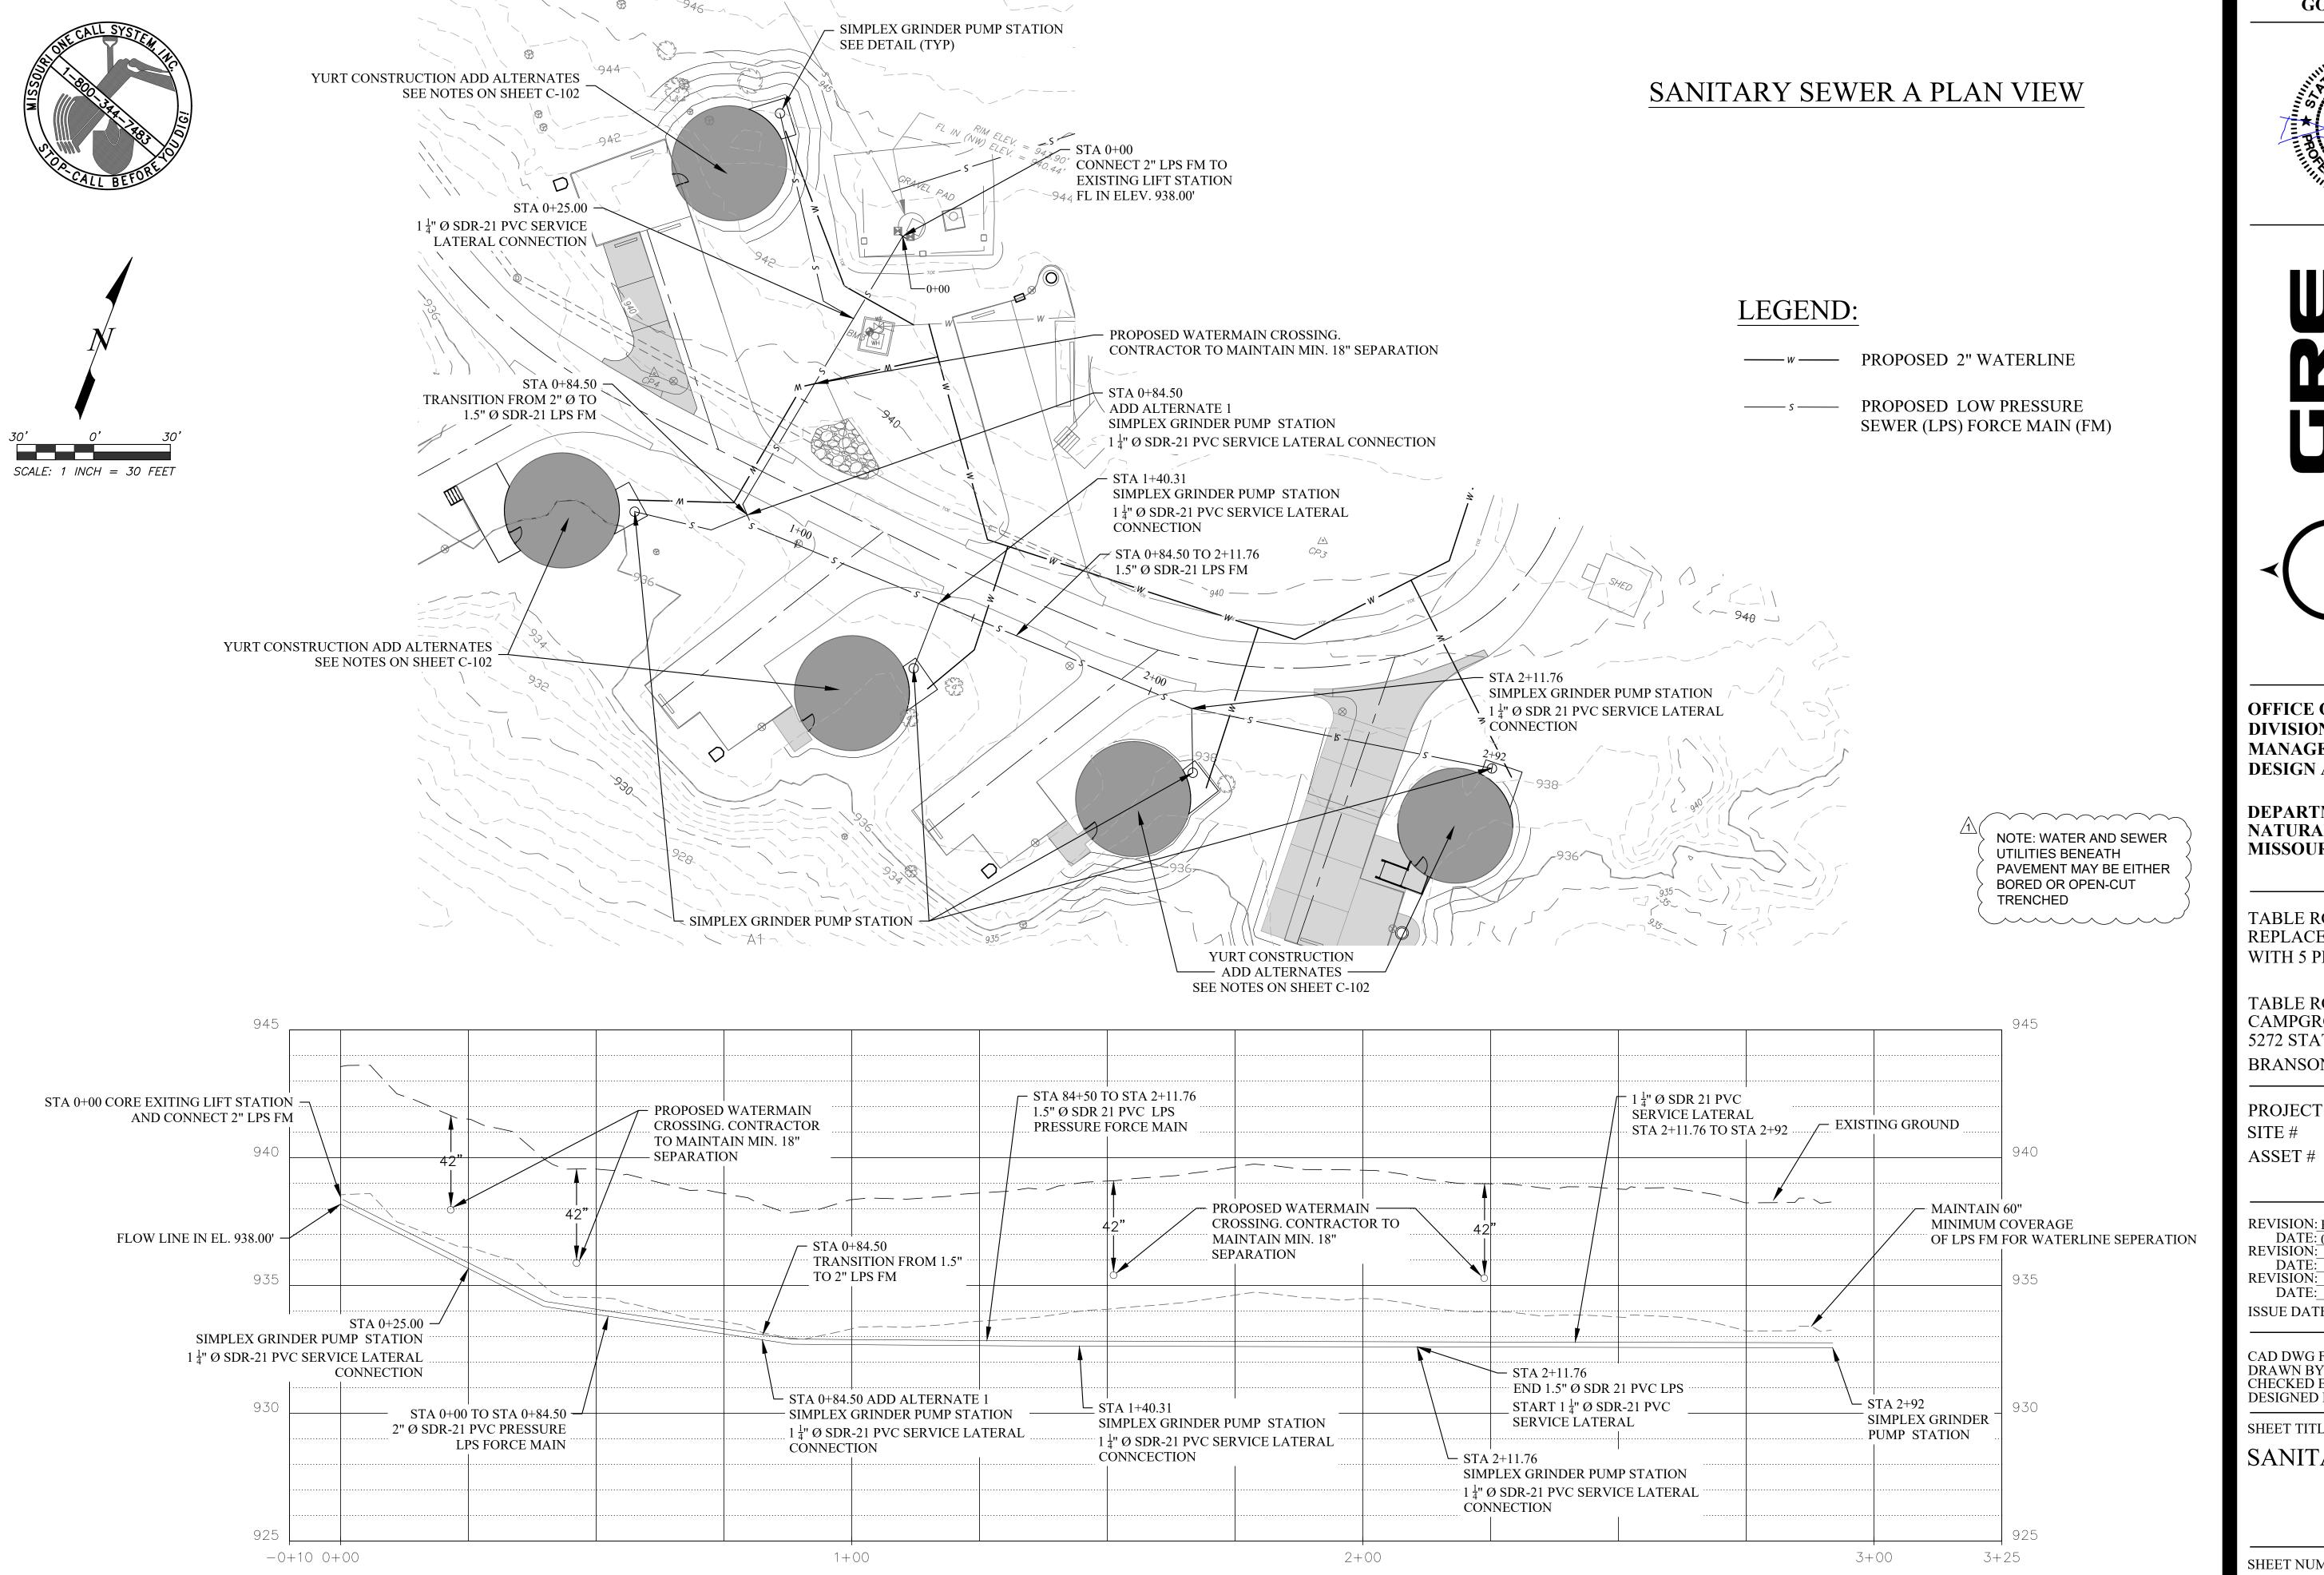
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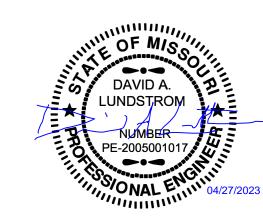
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WATERLINE A

SHEET NUMBER:

C-105





OFFICE OF ADMINISTRATION DIVISION OF FACILITIES MANAGEMENT, **DESIGN AND CONSTRUCTION**

DEPARTMENT OF NATURAL RESOURCES MISSOURI STATE PARKS

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PROJECT # X2215-01 SITE# 5603 03018

REVISION: REV. 1 - ADDENDUM 1 DATE: 04/20/2023 REVISION: DATE: **REVISION:** DATE:


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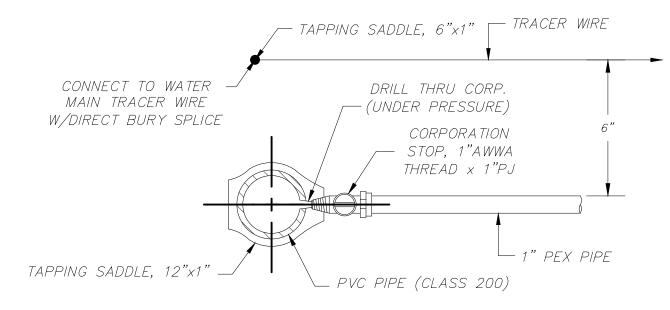
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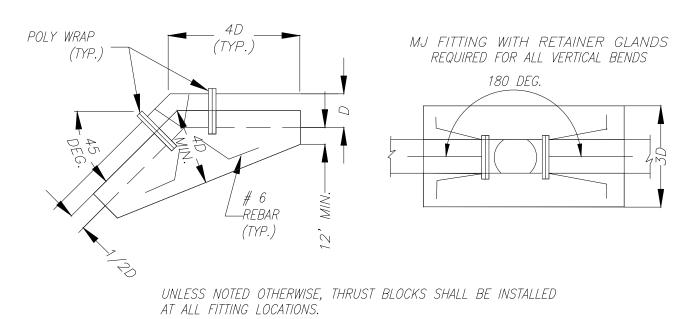


WATER/SEWER CROSSING
NOT TO SCALE




SADDLE W/CORPORATION STOP (CLASS 200 PVC MAINS)

TYPICAL 1" PVC WATER SERVICE
CONNECTION ON CLASS 200 PVC MAIN
NOT TO SCALE

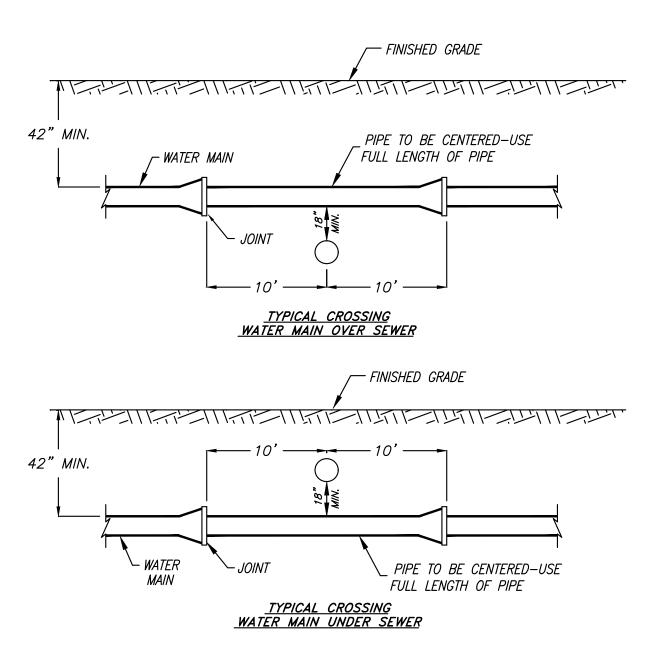

VERTICAL BEND CONCRETE THRUST BLOCK DETAIL
NOT TO SCALE

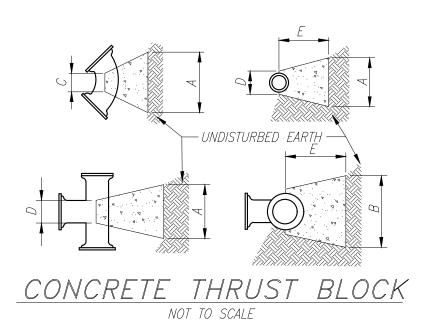

PIPE			DISTANCE IN INCHES				
SIZE	FITTING	Α	В	С	D	Ε	
4"	11.25 & 22.5°	9	9	8	8	6	
AND	45°	18	9	8	8	12	
SMALLER	90°	21	12	8	8	12	
SMALLER	TEE/PLUG	15	12	8	8	12	
6"	11.25 & 22.5°	12	12	8	10	12	
	45°	27	12	8	10	12	
	90°	33	18	8	10	12	
	TEE/PLUG	24	18	8	10	12	
	11.25 & 22.5°	18	15	8	10	12	
8"	45°	33	15	8	10	18	
	90°	42	24	8	10	18	
	TEE/PLUG	30	24	8	10	18	

NOTES:

- 1. THRUST BLOCKS ARE BASED ON A WORKING PRESSURE OF 200 P.S.I. PLUS 0% SURGE, & 2000 P.S.F. ALLOWABLE SOIL BEARING PRESSURE.
- 2. FOR PIPE SIZES NOT SHOWN USE DIMENSIONS FOR NEXT LARGER SIZE.
- 3. USE 3/8" PLYWOOD SEPARATOR BETWEEN BLOCKS AND PLUGS TO PROVIDE FOR FUTURE REMOVAL.
- 4. WRAP ALL FITTINGS W/6 MIL POLY PRIOR TO PLACEMENT OF CONCRETE THRUST BLOCKING.

THRUST BLOCKING DETAIL

NOT TO SCALE



STATE OF MISSOURI MICHAEL L. PARSON, GOVERNOR





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PROJECT # X2215-01 SITE # 5603 ASSET # 03018

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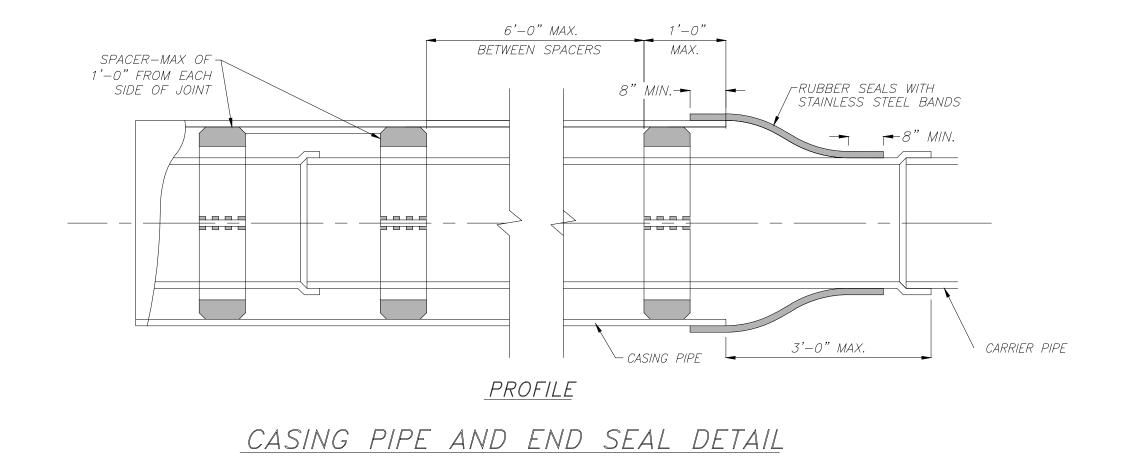
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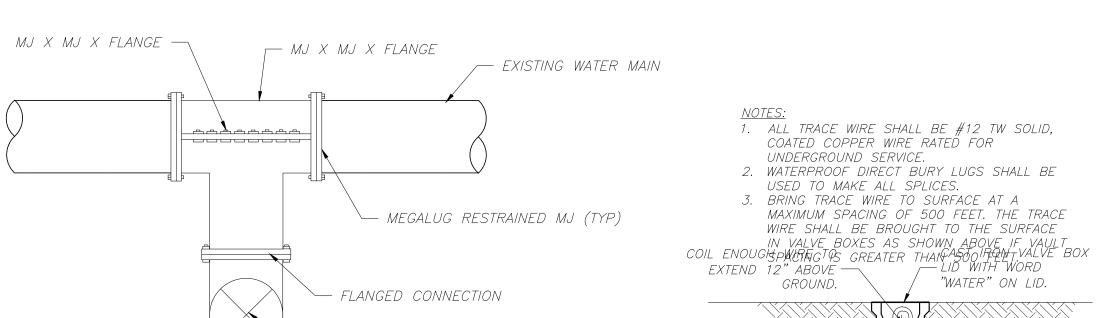
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C-50




NOT TO SCALE



— 6" ISOLATION VALVE (FLANGE X MJ)




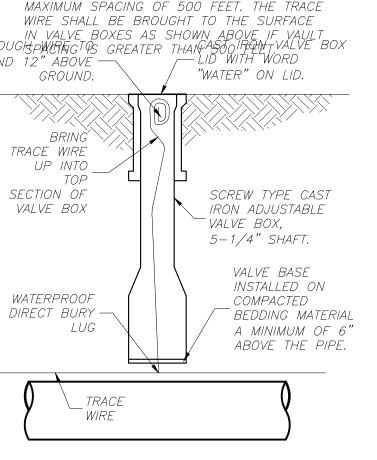

TRACE WIRE IN VALVE BOX

TRACE WIRE INSTALLATION

NOT TO SCALE

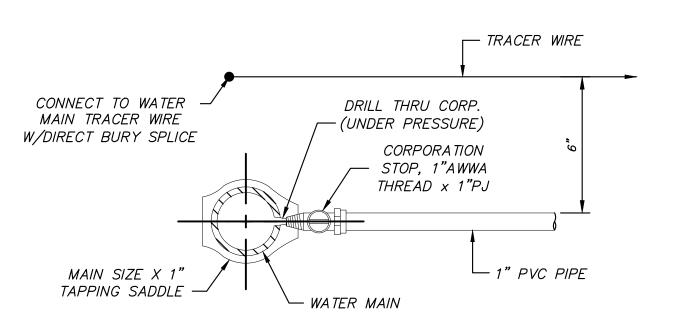


SADDLE W/CORPORATION STOP

TYPICAL 1" PVC WATER SERVICE

CONNECTION ON WATER MAIN

NOT TO SCALE



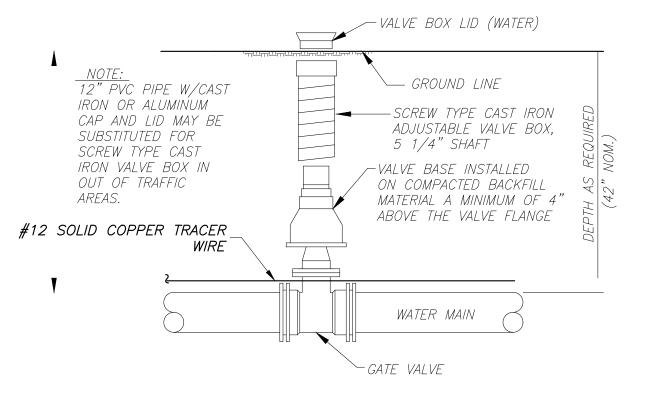

TYPICAL GATE VALVE INSTALLATION

NOT TO SCALE

STATE OF MISSOURI MICHAEL L. PARSON, GOVERNOR





OFFICE OF ADMINISTRATION DIVISION OF FACILITIES MANAGEMENT, DESIGN AND CONSTRUCTION

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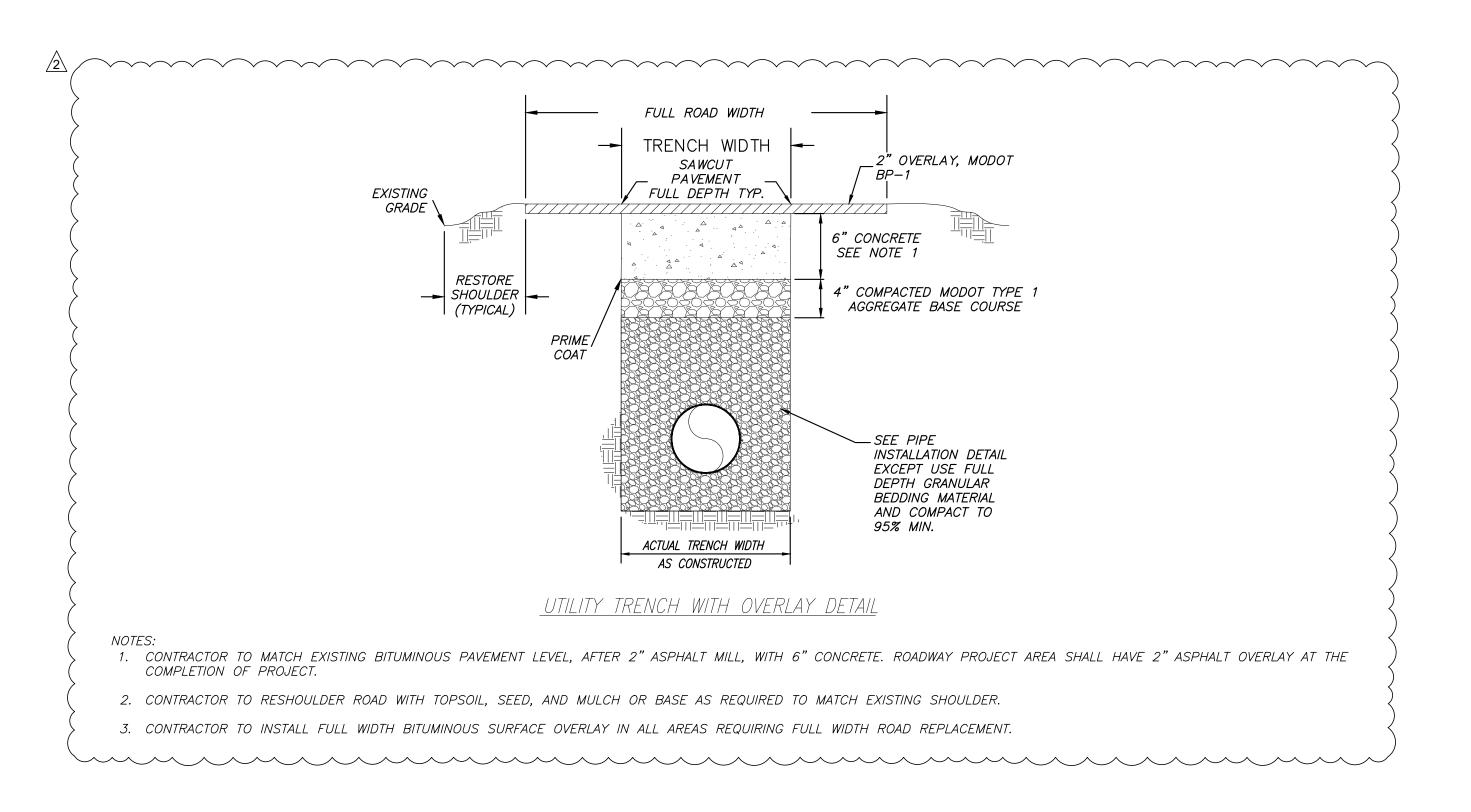
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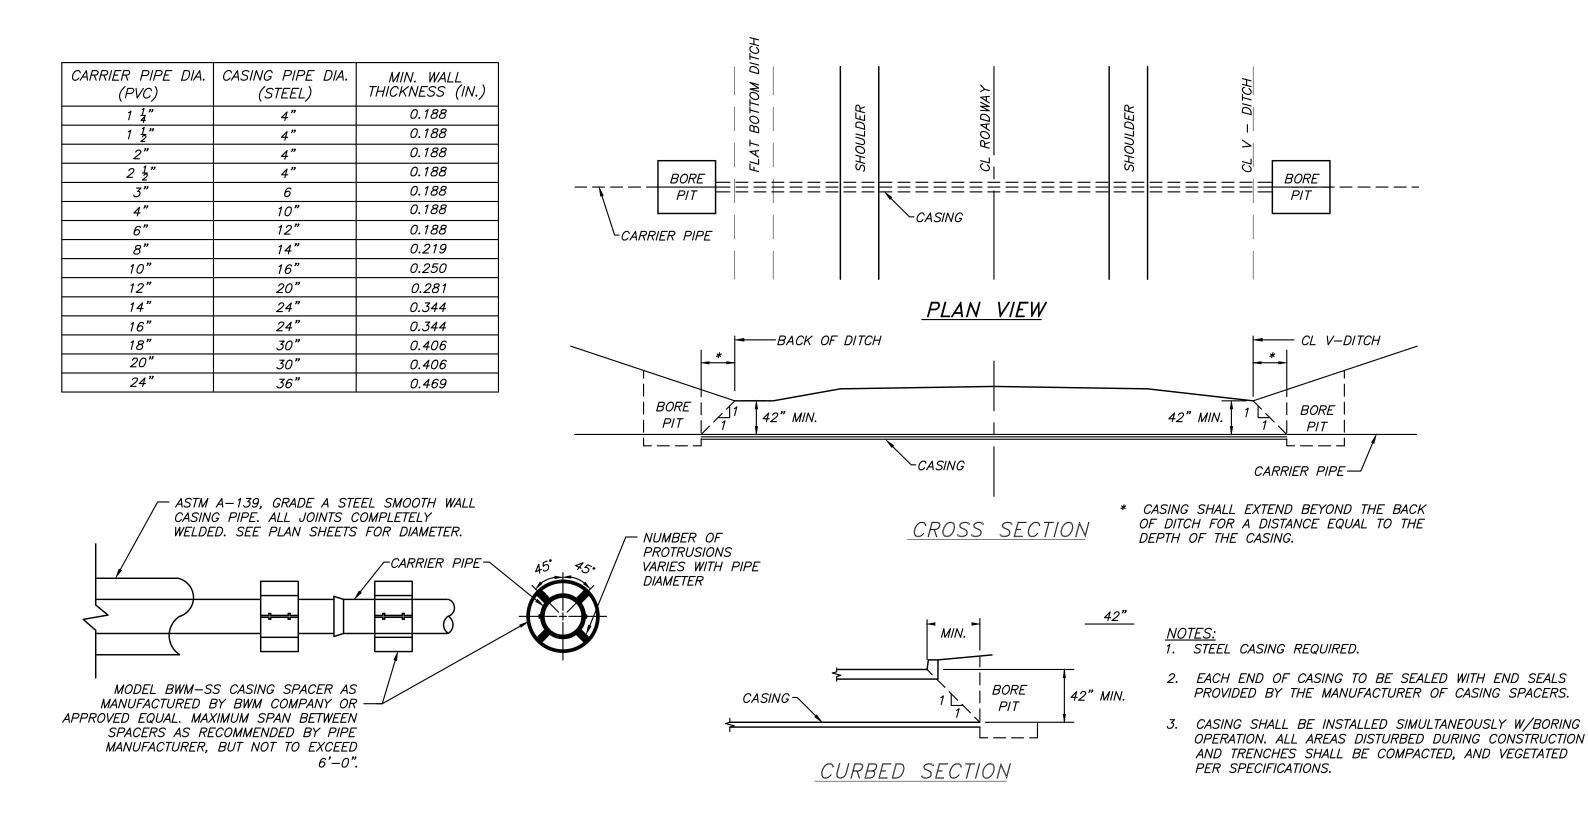
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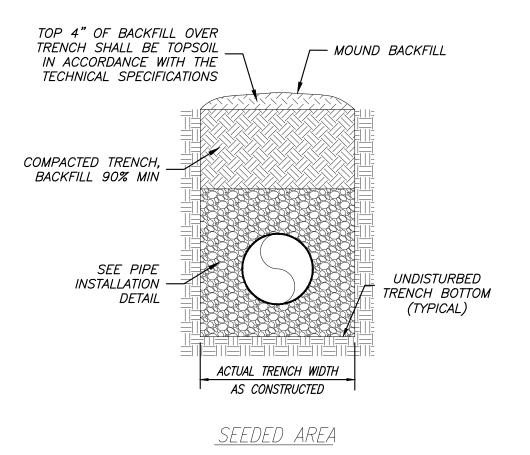
C-502







TYPICAL ROAD BORING DETAIL

NOT TO SCALE



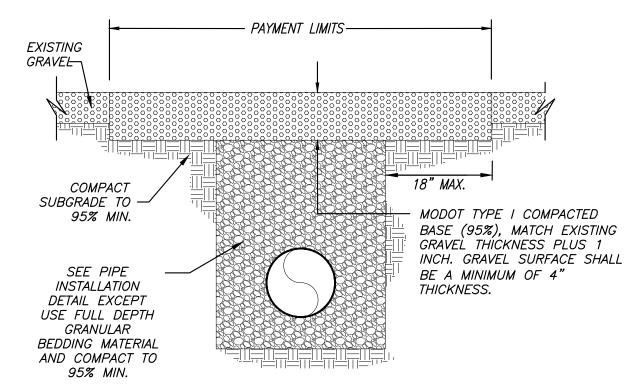


GRAVEL SURFACE AREA CROSSING

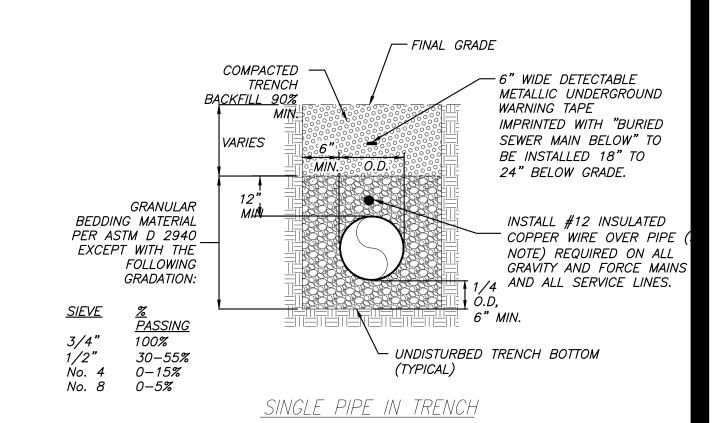

PIPE INSTALLATION DETAIL NOT TO SCALE

NOTE:
ENDS OF LOCATOR WIRE SHALL BE PLACED IN A 6" DIP RISER PIPE
WITH CAST IRON LIDS AT 500' MIN. SPACING AND SHALL BE
GROUNDED TO A 4'x1/2" DIA. COPPER ROD AT RISERS. ALL WIRE
SPLICES SHALL USE BRASS/COPPER SPLIT—BOLT CONNECTORS.
RISERS AND GROUNDING RODS FOR LOCATION WIRE ON SERVICE
LATERALS SHALL BE PLACED, AT A MINIMUM, AT ROW AND FINAL
CLEANOUT LOCATION ON THE PROPERTY.

STATE OF MISSOURI MICHAEL L. PARSON, GOVERNOR

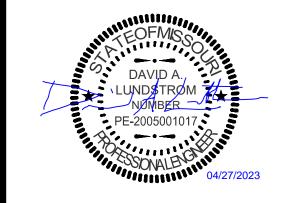



OFFICE OF ADMINISTRATION DIVISION OF FACILITIES MANAGEMENT, DESIGN AND CONSTRUCTION

DEPARTMENT OF NATURAL RESOURCES MISSOURI STATE PARKS

TABLE ROCK STATE PARK REPLACE 5 BASIC SITES WITH 5 PREMIUM YURTS

TABLE ROCK STATE PARK CAMPGROUND #2 5272 STATE HWY 165 BRANSON, MISSOURI 65616

PROJECT # X2215-01 SITE # 5603 ASSET # 03018

REVISION: REV. 2 - ADDENDUM 2
DATE: 04/27/2023
REVISION:
DATE:
REVISION:

DATE: ISSUE DATE: 01/17/2023

CAD DWG FILE:X2215-01 C-004
DRAWN BY: WSH
CHECKED BY: CMW
DESIGNED BY: WSH

SHEET TITLE:


SEWER DETAILS

SHEET NUMBER:

C-503





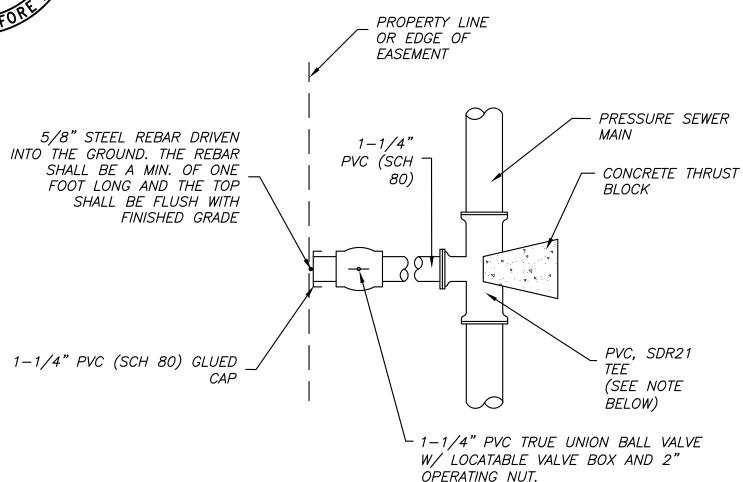


<u>NOTES:</u> 1. DISCHARGE PIPE SHALL BE SCHEDULE 80 PVC.

- 2. TEE SHALL BE AS REQUIRED FOR 2", 2-1/2", 3", AND 4" MAIN LINES. FOR MAIN SIZES GREATER THAN 4", TAPPING SADDLES SHALL BE USED.
- 3. CONTRACTOR SHALL COORDINATE LOCATION OF BALL VALVE WITH ENGINEER.
- 4. CONTRACTOR SHALL PROVIDE "RECORD DRAWINGS SHOWING EXACT STATION OF LATERAL LOCATION OF AND BALL VALVE.
- 5. DEPTH OF COVER FOR SERVICE LINES SHALL BE 24 INCHES MINIMUM, UNLESS OTHERWISE NOTED.
- 6. BEDDING AS PER "PIPE INSTALLATION DETAIL."

NOT TO SCALE


TYPICAL LOW PRESSURE LATERAL INSTALLATION DETAIL NOT TO SCALE

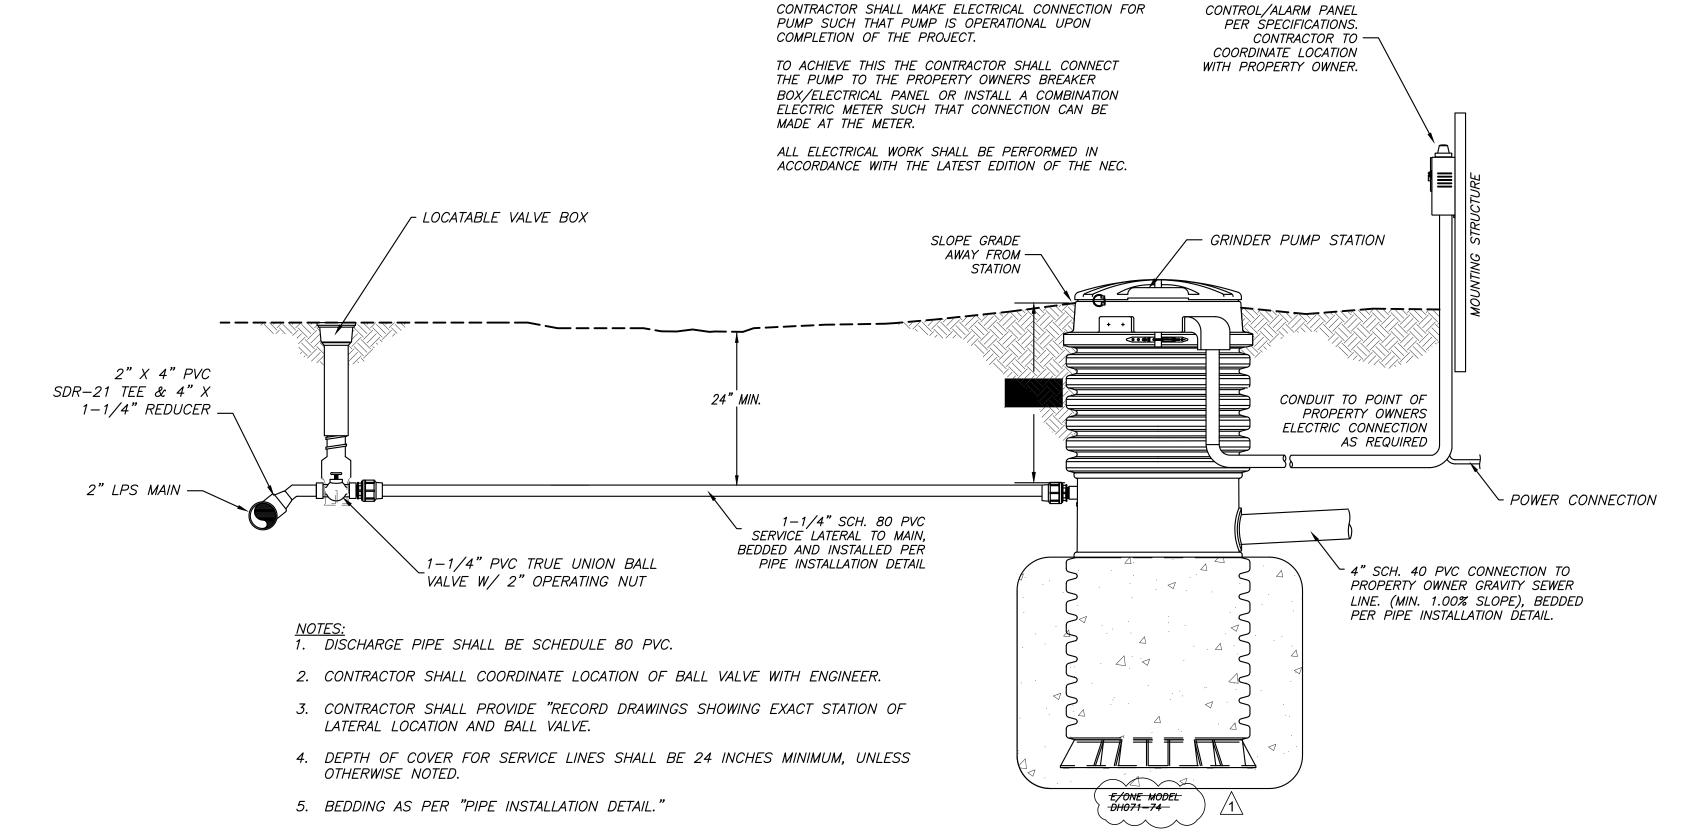

TYPICAL LOW PRESSURE LATERAL & GRINDER PUMP

INSTALLATION DETAIL

NOT TO SCALE

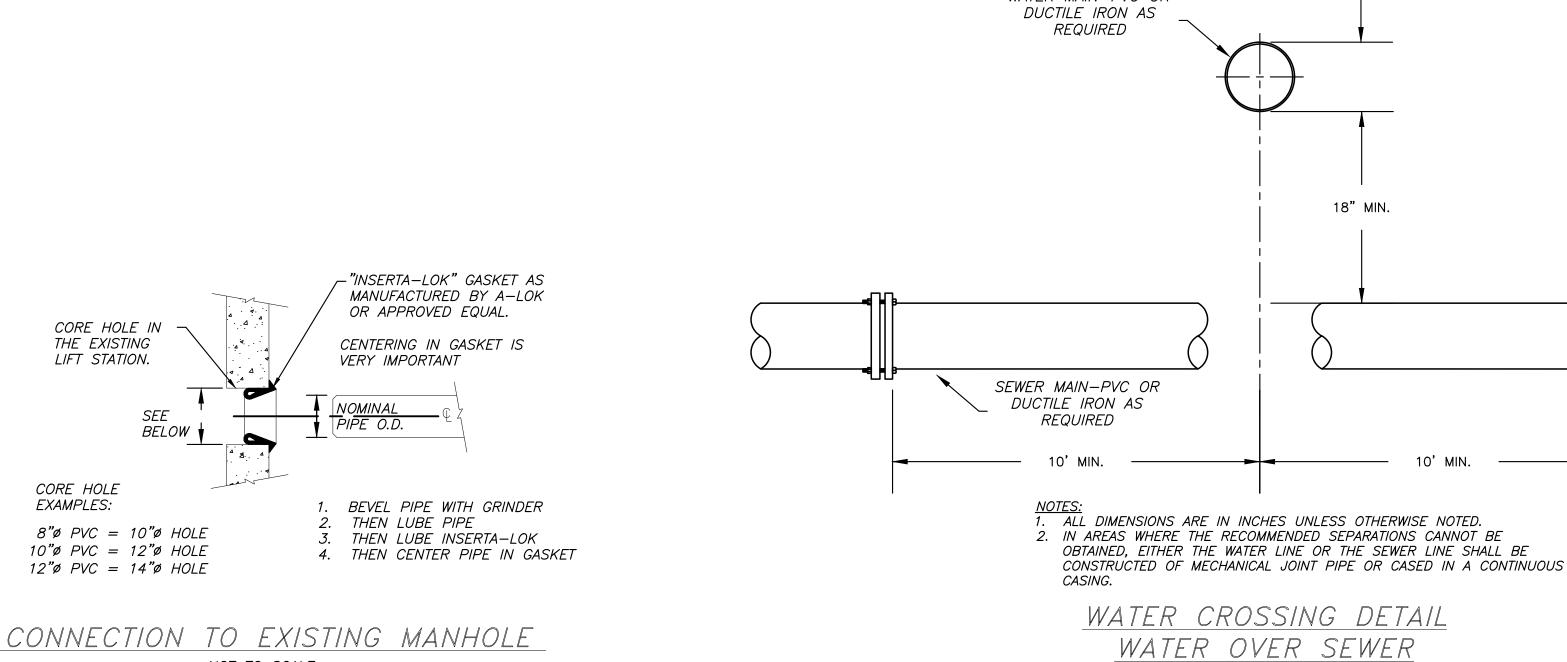


FINISHED GRADE


WATER MAIN-PVC OR

—— 42" MIN.

NOT TO SCALE

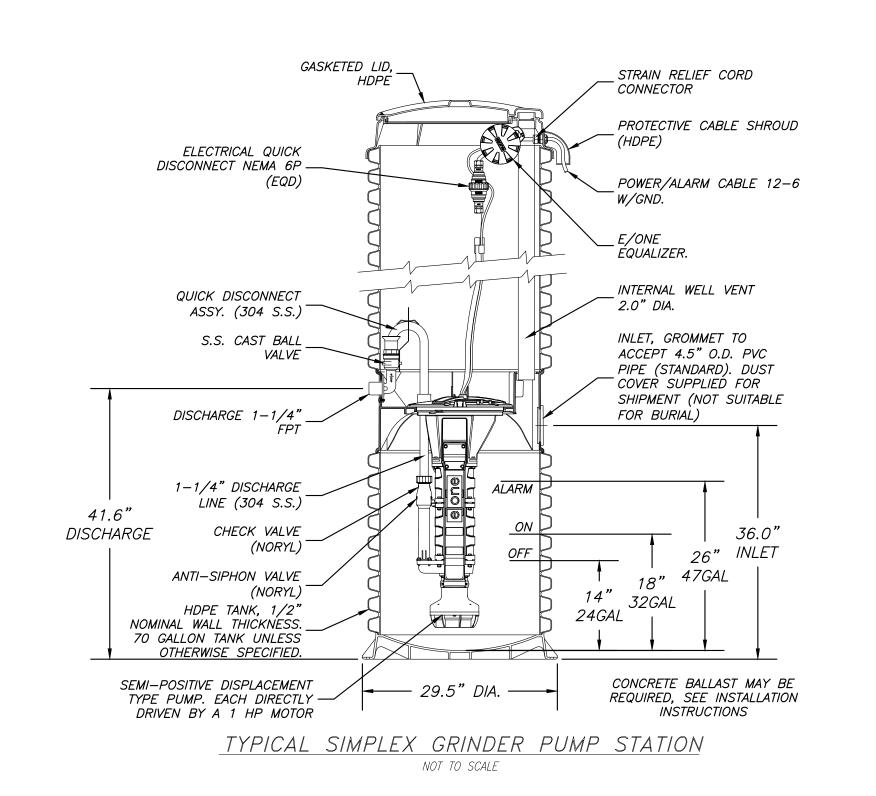

STATE OF MISSOURI MICHAEL L. PARSON, GOVERNOR

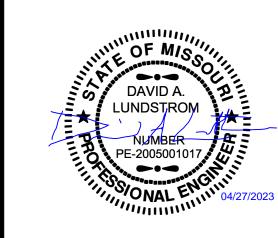

GREAT RIVER

Missouri State Certificate of Authority Numbers:

Missouri State Certificate of Authority Numbers:

Missouri State Certificate of Authority Numbers:

OFFICE OF ADMINISTRATION DIVISION OF FACILITIES MANAGEMENT, DESIGN AND CONSTRUCTION

DEPARTMENT OF NATURAL RESOURCES MISSOURI STATE PARKS

TABLE ROCK STATE PARK REPLACE 5 BASIC SITES WITH 5 PREMIUM YURTS

TABLE ROCK STATE PARK CAMPGROUND #2 5272 STATE HWY 165 BRANSON, MISSOURI 65616

PROJECT # X2215-01 SITE # 5603 ASSET # 03018

REVISION: REV. 1 - ADDENDUM 1
DATE: 04/20/2023
REVISION:
DATE:
REVISION:
DATE:
DATE:

ISSUE DATE: 01/17/2023

CAD DWG FILE: X2215-01_ C-004


DRAWN BY: WSH
CHECKED BY: CMW
DESIGNED BY: WSH

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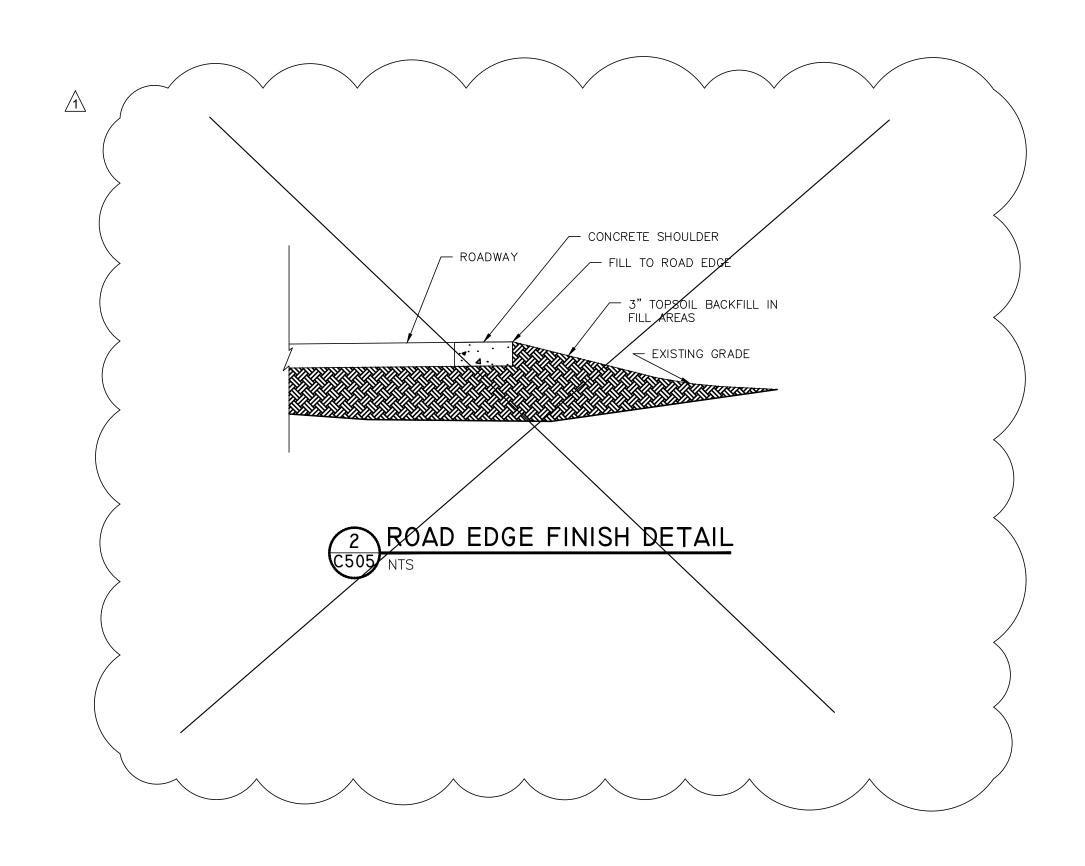
SEWER DETAILS


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C-50






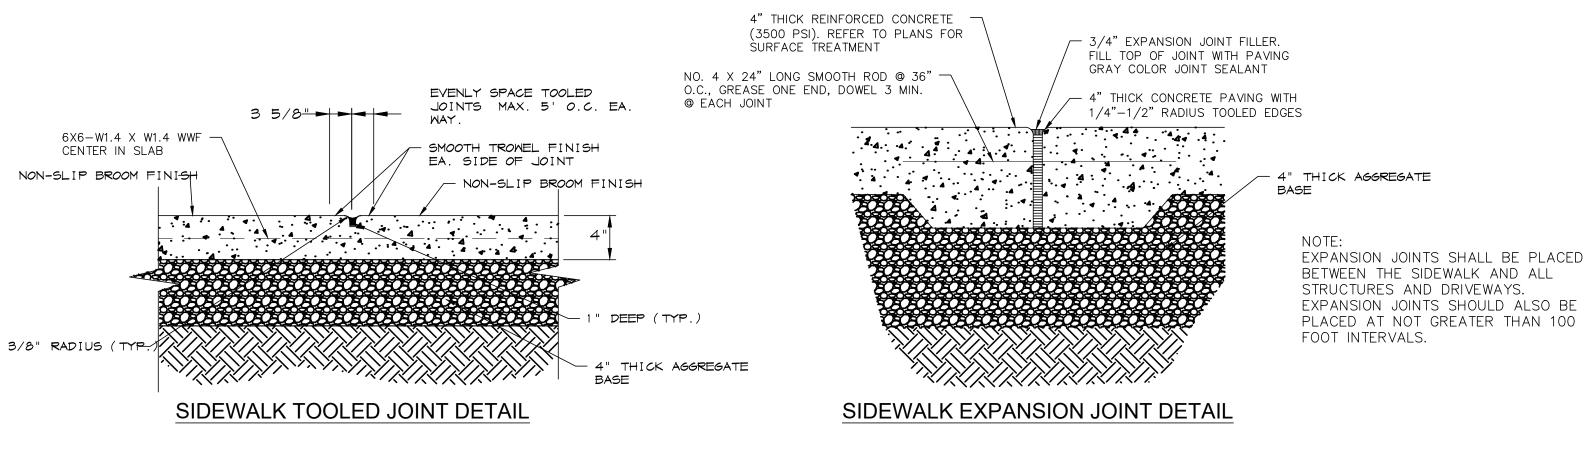




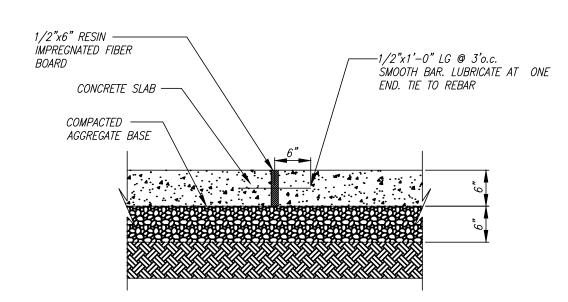


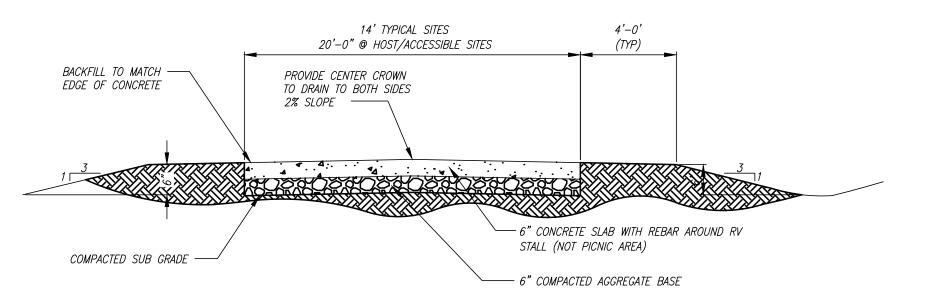



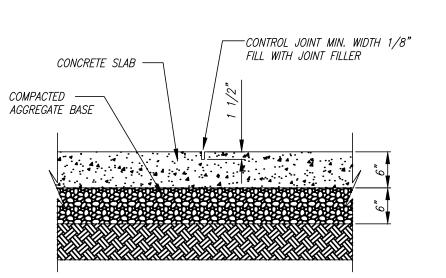




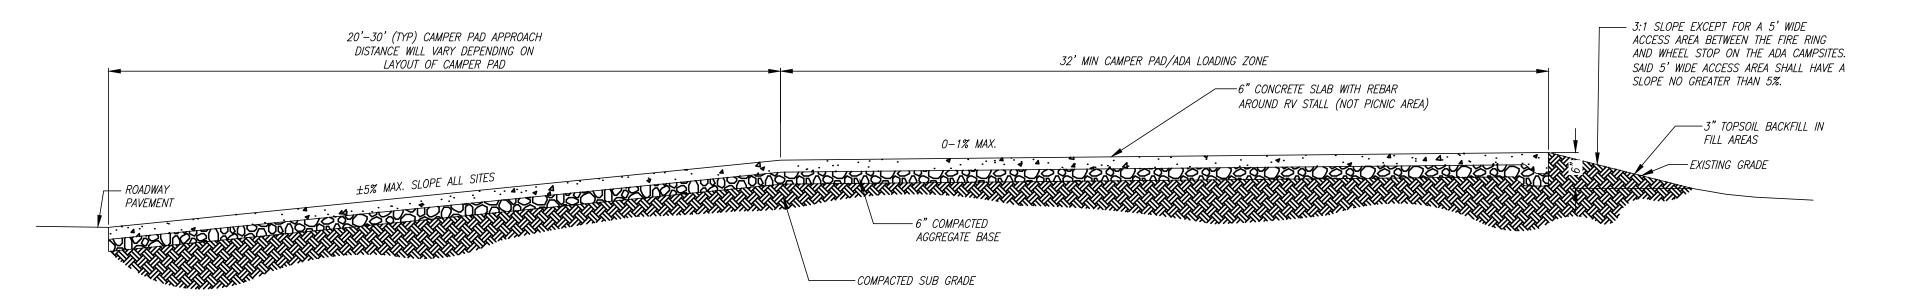

6 CAMPSITE LONGITUDINAL ELEVATION
C505 NTS

STATE OF MISSOURI MICHAEL L. PARSON, GOVERNOR

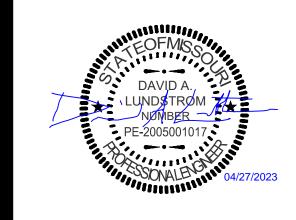



OFFICE OF ADMINISTRATION DIVISION OF FACILITIES MANAGEMENT, DESIGN AND CONSTRUCTION

DEPARTMENT OF NATURAL RESOURCES MISSOURI STATE PARKS

TABLE ROCK STATE PARK REPLACE 22 ELECTRIC SITES WITH 22 PREMIUM SITES

TABLE ROCK STATE PARK CAMPGROUND #2 5272 STATE HWY 165 BRANSON, MISSOURI 65616

7815603018

PROJECT # X2223-01 SITE # 5603

REVISION: <u>REV. 1 - ADDEN</u>DUM 1 DATE: <u>04/20/2023</u> REVISION: DATE: REVISION:

ASSET#

CAD DWG FILE:4638_water-waste
DRAWN BY: EB
CHECKED BY: CMW
DESIGNED BY: CMW

SHEET TITLE:

SITE DETAILS

SHEET NUMBER:

C-505

PRESSURE TREATED SILL PLATE: 32 SEGMENTS 15' RADIUS ESTIMATED QUANTITIES **ITEM UNITS** TOTAL 2x6 PERIMETER CONCRETE CU. YARD (SHORT SIDE OF BOARD) SILL PLATE REINFORCING POUNDS 620 " THICK REINFORCED CONCRETE **SLAB WITH 8" THICKENED EDGES OVER 15 MIL POLY COMPACTED** CLEAN CRUSH STONE FILL BEFORE ADDING DRIP EDG


CIRCULAR SLAB WITH 2x6 SILL PLATE

#4 BARS @ 18" CTS.

CONCRETE DIAMETER = 29'-11" DRIP EDGE THICKNESS = 1/2"

ANCHOR RING THICKNESS = 1/2" MINIMUM HEIGHT ABOVE GRADE = 6"

- 1. CONCRETE SHALL BE 3,000 psi @ 28 DAYS.
- 2. CONTRACTOR SHALL PROVIDE CONTROL JOINTS THAT ARE 1/4 OF SLAB THICKNESS AT A MAXIMUM SPACING OF 10' x 10'.
- 3. CONTRACTOR SHALL COMPACT SOIL BENEATH FOUNDATION CONCRETE PRIOR TO PLACEMENT OF CONCRETE.

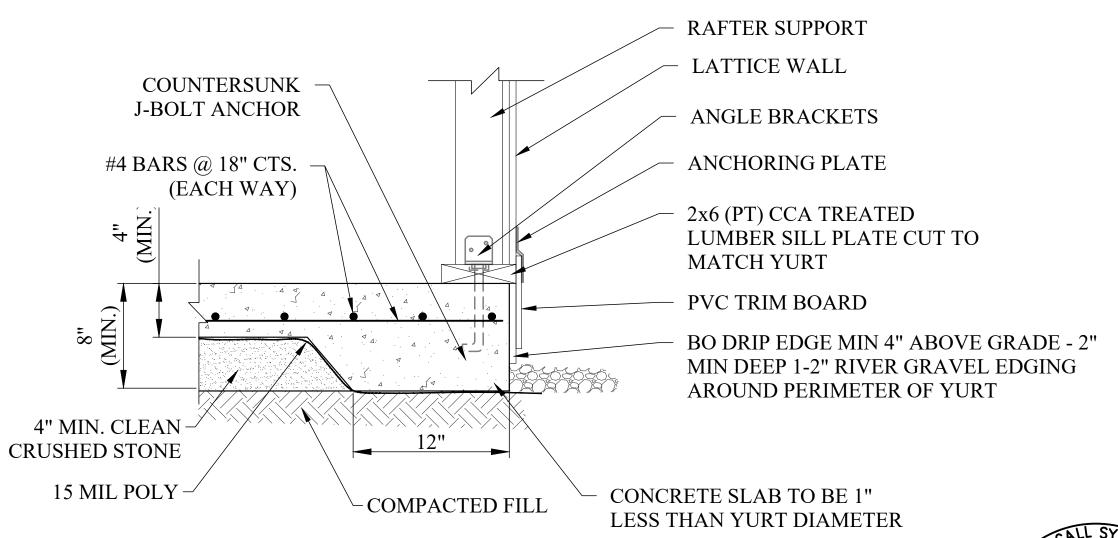


YURT CONNECTION TO SLAB DETAIL

NOTE:

PROVIDE 1/2" DIA. x 6" MIN. EMBEDDED ANCHOR BOLT WITH MIN. 2" WASHER @ 6'-0" O.C. MAX. AND (2) ANCHOR BOLTS MIN. PER SILL PLATE RUN.


ESTIMATED QUANTITIES (ADD ALTERNATE 1)

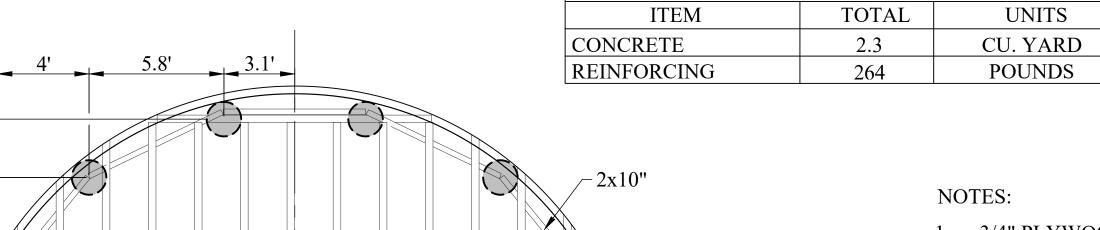

(2) 2x107.1' 2x10" JOISTS SPACED @ 16" O.C. 2" PVC DRIP EDGE ATTACHED TO EDGE OF PLATFORM. TOP OF DRIP

- 1. 3/4" PLYWOOD FLOORING TO BE LAID PERPENDICULAR TO JOISTS AND TRIMMED TO THE SAME DIAMETER AS THAT OF THE YURT.
- FOOTINGS SHALL BE EMBEDDED IN THE GROUND A MIN. 30" AND SHOULD EXTEND 6" ABOVE GROUND SURFACE MINIMUM.
- LUMBER SHALL BE NO. 3 SOUTHERN PINE MINIMUM. REFER TO CHAPTER 5.6 OF 2018 IRC FOR ALTERNATE STRUCTURAL LUMBER.

30' PLATFORM FRAMING PLAN

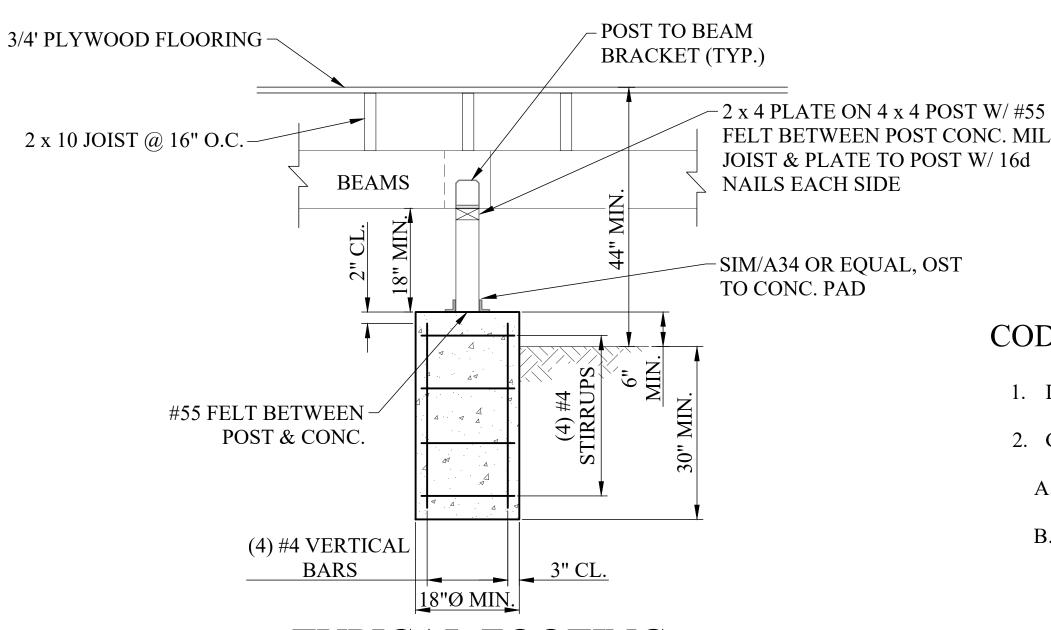

TYPICAL FOOTING

NOTES:

CONCRETE DIAMETER = 29'-11" ANCHOR RING THICKNESS = 1/2" DRIP EDGE THICKNESS = 1/2" MINIMUM HEIGHT ABOVE GRADE = 6"

- CONCRETE SHALL BE 3,000 psi @ 28 DAYS.
- CONTRACTOR SHALL PROVIDE CONTROL JOINTS THAT ARE 1/4 OF SLAB THICKNESS AT A MAXIMUM SPACING OF 10' x 10'.
- CONTRACTOR SHALL COMPACT SOIL BENEATH FOUNDATION CONCRETE PRIOR TO PLACEMENT OF CONCRETE.

PIER DETAILS FOR 30' DIAMETER YURT

CODE STUDY

EDGE TO BE 1" ABOVE PLATE

1. DESIGN CODES IBC 2021

2. GRAVITY LOADS

A. DEAD LOADS-SELF WEIGHT

B. LIVE LOADS

5 PSF MIN ROOF LIVE LOAD OR SNOW 40 PSF LIVE LOAD-FLOOR

C. SNOW LOAD

24 PSF P_σ GROUND SNOW LOAD IMPORTANCE FACTOR (I) 1.0 SNOW EXPOSURE FACTOR (C_e) 1.0 THERMAL FACTOR PER CODE - SNOW DRIFT

3. LATERAL LOADS

A. WI	ND LOADS	
-	WIND SPEED	107 MPH
-	IMPORTANCE FACTOR (I)	1.0
-	EXPOSURE CATEGORY	C
-	DIRECTIONALITY FACTOR (K_d)	0.85
-	TOPOGRAPHIC FACTOR (K _{zt})	0.85
-	INTERNAL PRESSURE (GC .) UPLIFT (PSF)	± 0.18
_	UPLIFT (PSF)	22 PSF

STATE OF MISSOURI MICHAEL L. PARSON, **GOVERNOR**





OFFICE OF ADMINISTRATION DIVISION OF FACILITIES MANAGEMENT, **DESIGN AND CONSTRUCTION**

DEPARTMENT OF NATURAL RESOURCES MISSOURI STATE PARKS

TABLE ROCK STATE PARK REPLACE 5 BASIC SITES WITH 5 PREMIUM YURTS

TABLE ROCK STATE PARK CAMPGROUND #2 5272 STATE HWY 165 BRANSON, MISSOURI 65616

PROJECT # X2215-01 5603 03018 ASSET#

REVISION: DATE: **REVISION:** DATE: **REVISION:** DATE:

ISSUE DATE: 01/17/2023

CAD DWG FILE:X2215-01 S-101
DRAWN BY: KAB
CHECKED BY: JAB DESIGNED BY: JAB

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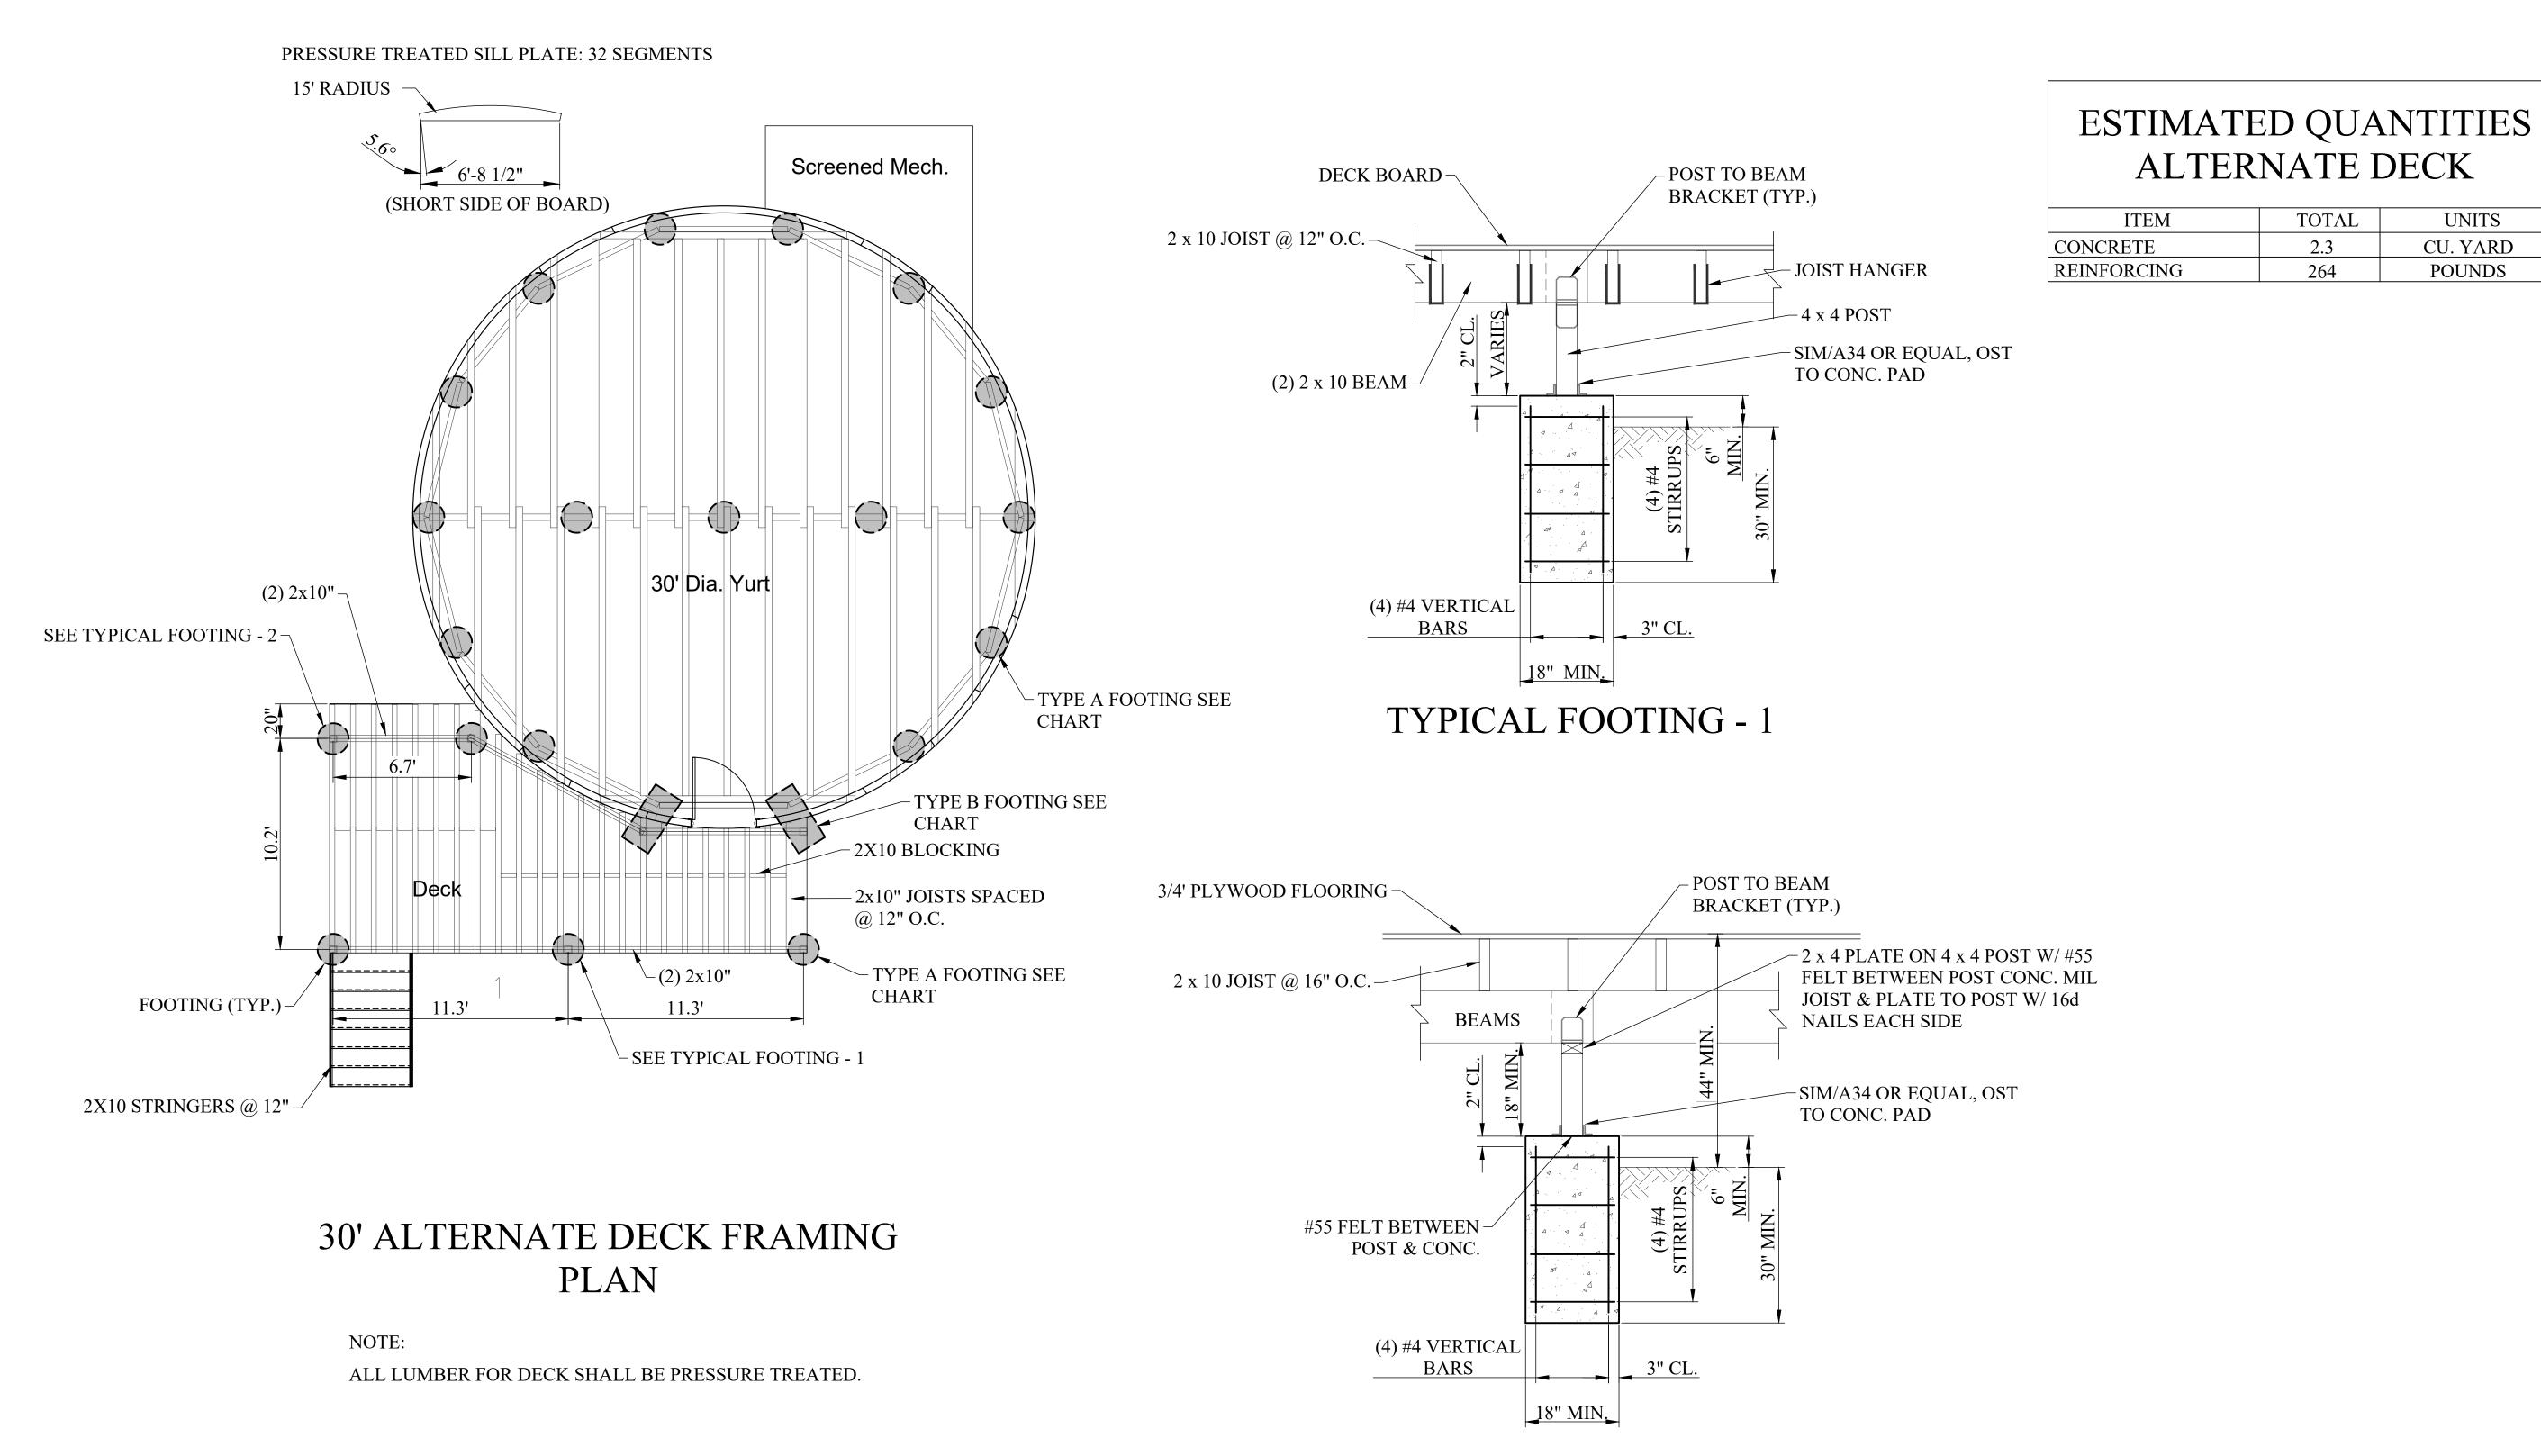
FOUNDATION DETAILS FOR 30' DIA. YURT - ADD ALT. 1

SHEET NUMBER:

16 OF 32 SHEETS


JANUARY 17, 2023

CONCRETE SLAB DETAILS FOR 30' DIAMETER YURT



TYPICAL FOOTING - 2

FOOTING SIZES				
ID	DIMENSIONS			
A	18"Ø X 36" DEEP			
В	18" WIDE X 3' LONG X 36" DEEP			

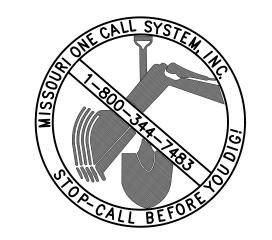

STATE OF MISSOURI MICHAEL L. PARSON, **GOVERNOR**



TOTAL


2.3

264

UNITS

CU. YARD

POUNDS

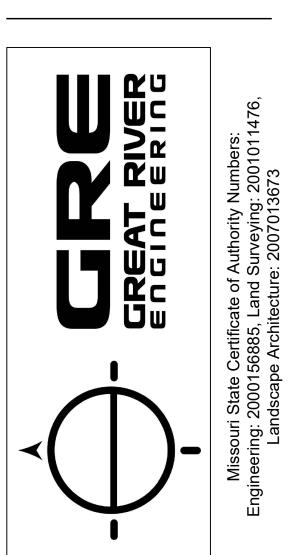

OFFICE OF ADMINISTRATION DIVISION OF FACILITIES MANAGEMENT, DESIGN AND CONSTRUCTION

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PROJECT # X2215-01 ASSET# 03018

REVISION: REVISION: REVISION: DATE: ISSUE DATE: 01/17/2023

CAD DWG FILE:X2215-01 S-101
DRAWN BY: KAB
CHECKED BY: JAB
DESIGNED BY: JAB


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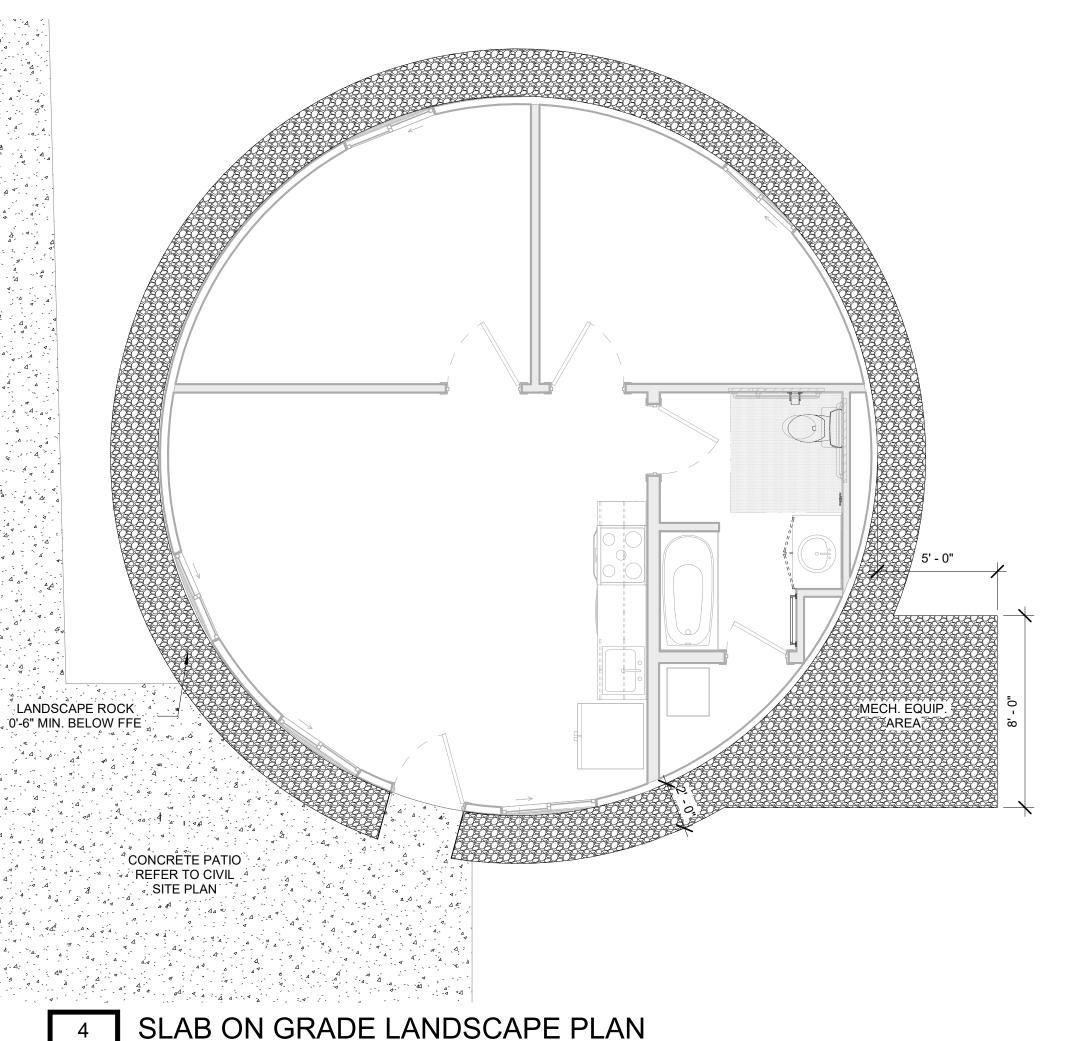
DECK DETAILS FOR 30' DIA. YURT -ADD ALT. 1


SHEET NUMBER:

S-102 17 OF 32 SHEETS

JANUARY 17, 2023



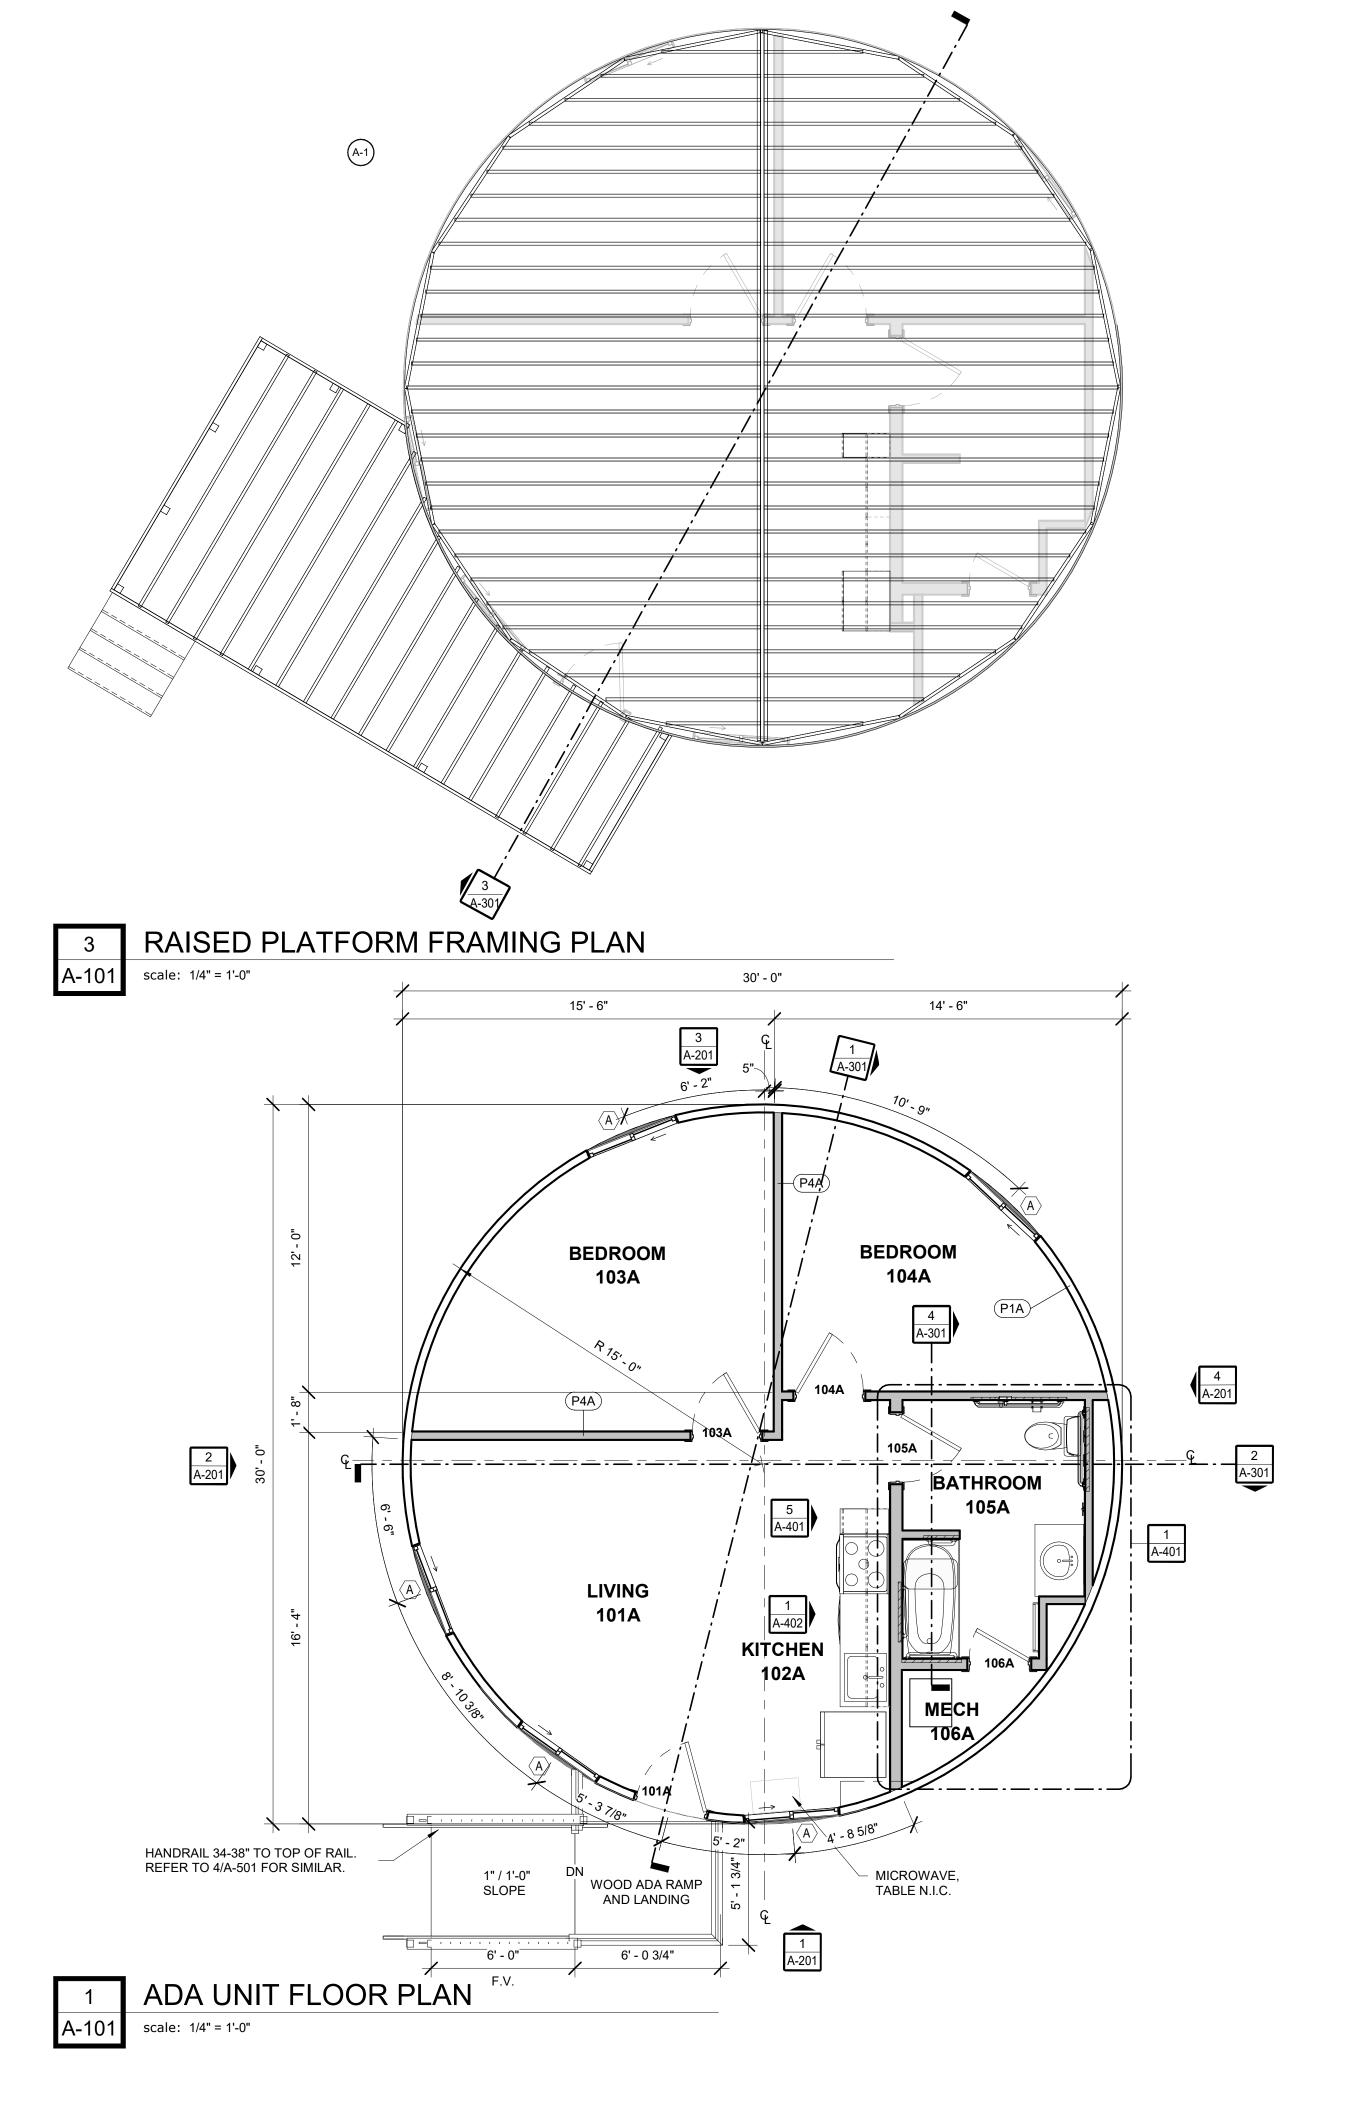

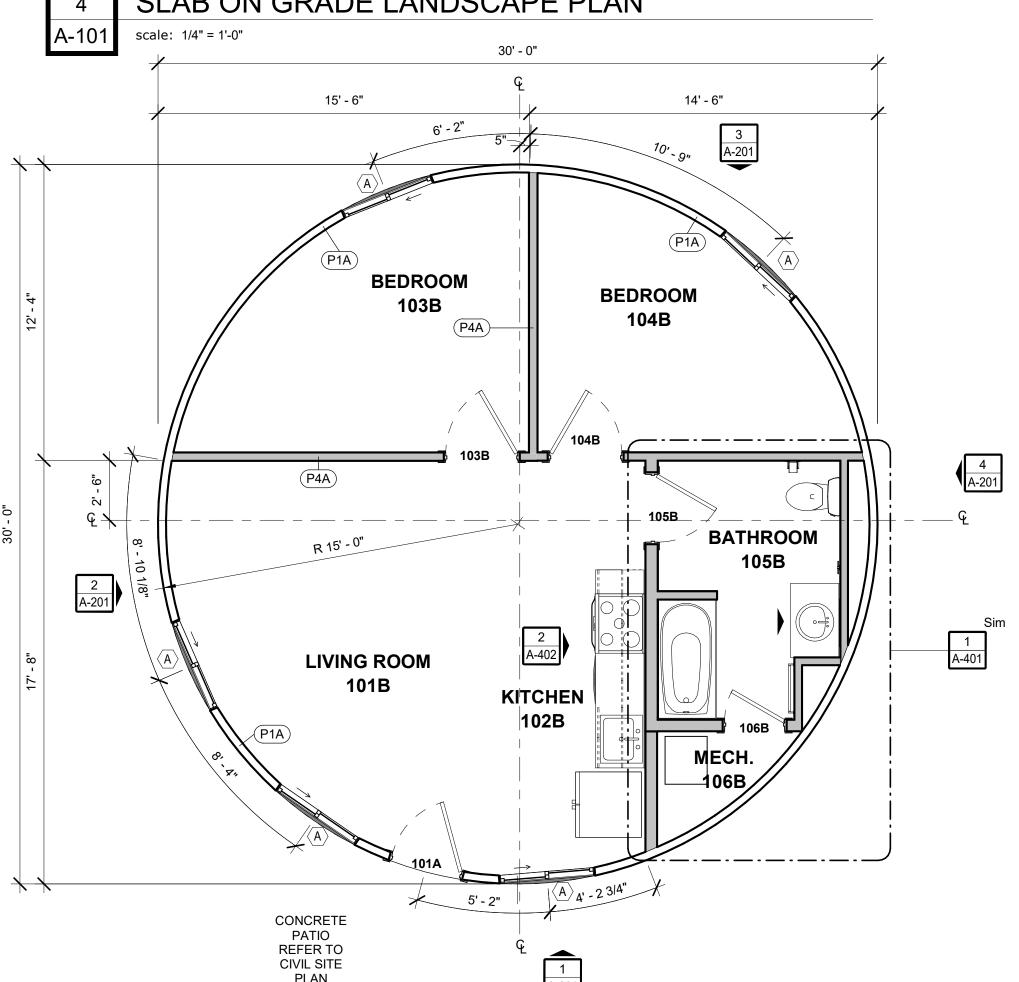

STANDARD UNIT FLOOR PLAN A-101 scale: 1/4" = 1'-0"

GENERAL NOTES - FLOOR PLAN

- ALL DIMENSIONS INDICATED IN CONTRACT DOCUMENTS ARE FROM FACE OF STUD TO FACE OF STUD FOR INTERIOR PARTITIONS, FACE OF EXISTING STRUCTURE OR FINISH, FACE OF CONCRETE OR BLOCK, OR TO STRUCTURAL LINE, EXCEPT AS NOTED OTHERWISE. DIMENSIONS OF EXISTING STRUCTURE, ETC. ARE +/- AND SHOULD BE FIELD VERIFIED PRIOR TO COMMENCEMENT OF
- WORK AND ARCHITECT NOTIFIED OF ANY DISCREPANCIES EQUIPMENT SHOWN ON THIS PLAN IS FOR REFERENCE ONLY. SEE EQUIPMENT, MECHANICAL, PLUMBING, AND/OR ELECTRICAL PLANS FOR
- ADDITIONAL INFORMATION.
- COORDINATE WITH OWNER ON OWNER SUPPLIED APPLIANCES AND EQUIPMENT PRIOR TO FABRICATION/INSTALLATION.
- WALL TYPES INDICATE TYPICAL CONDITIONS, SOME CONDITIONS MAY VARY, REFER TO SECTIONS, INTERIOR ELEVATIONS AND STRUCTURAL DRAWINGS FOR ADDITIONAL DETAILS WALL SECTIONS INDICATE PRIMARY WALL TYPE. OVERLAID VENEERS, WAINSCOT, PILASTERS, PAINT, WALL COVERINGS ETC. ARE INDICATED ON FLOOR PLANS, FINISH PLANS INTERIOR ELEVATIONS,
- SCHEDULES, SPECIFICATIONS OR OTHER DETAILS. GENERAL CONTRACTOR TO PROVIDE ALL BACKING AS REQUIRED IN WALL FOR CABINETS, FIRE EXTINGUISHER CABINETS, GRAB BARS, BATHROOM
- ACCESSORIES, WALL STOP LOCATIONS, ETC. AS REQUIRED. PENETRATIONS OF PIPES, CONDUIT, DUCTS AND VENTS THROUGH RATED
- ALL WALL INSULATION SHALL EXTEND THE FULL HEIGHT OF THE WALL UNLESS
- RECESSED FIXTURE SUCH AS OUTLETS SHOULD NOT BE PLACED BACK TO BACK IN THE SAME STUD CAVITY.

GENERAL NOTES - PARTITIONS

- ARCHITECTS RECOMMENDATION ON RESTROOM PARTITIONS: ALL PARTITION TYPES TO RECEIVE ACOUSTIC SEALANT ON BOTH SIDES OF THE WALL AT TOP AND BOTTOM.
- ALL PARTITIONS TO RECEIVE WALL BASE ON BOTH SIDES OF WALL. REFER TO FINISH PLAN AND LEGEND FOR MORE INFORMATION. ANY WALL CONSTRUCTION NOT NOTED WITH A PARTITION TYPE WALL TAG
- SHALL BE CLARIFIED FOR INTERPRETATION BY ARCHITECT PRIOR TO BIDDING. CONTRACTOR SHALL COORDINATE WALL FRAMING ABOVE FINISHED CEILINGS WITH FRAMING, PLUMBING, AND HVAC CONTRACTORS. FRAMING CONTRACTOR SHALL PROVIDE NECESSARY ROUGH OPENING FRAMING REQUIRED TO FACILITATE PIPING OR DUCTWORK PENETRATIONS - REFER TO MEP ENGINEERING DRAWINGS FOR LOCATIONS OF LOCATIONS OF NEW DUCTS, PIPING, ETC. SOME WALL FRAMING / BRACING MAY REQUIRE
- ADJUSTMENT OR RE-LOCATION TO ALLOW FOR DUCT / PIPE ROUTING. REFER TO U.L. DESIGN DIRECTORY FOR LISTED DESIGN NUMBERS NOT
- ASSEMBLIES SHOULD BE AIRTIGHT. SEAL ALL PENETRATIONS AND CRACKS
- WITH ACOUSTICAL SEALANT. WALL SECTIONS INDICATE PRIMARY WALL TYPE. OVERLAID VENEERS, WAINSCOT, PILASTERS, PAINT, WALL COVERINGS ETC. ARE INDICATED ON FLOOR PLANS, FINISH PLANS, INTERIOR ELEVATIONS, SCHEDULES, SPECIFICATIONS OR OTHER DETAILS.
- REFERENCE INTERIOR ELEVATION SHEETS FOR THE HEIGHTS OF FINISH MATERIALS (I.E. - TILE, WOOD PLANKS, ETC.)

KEYNOTE LEGEND


KEYNOTES - A 101 Character Note Text REFER TO STRUCTURALSHEETS FOR FRAMING LAYOUT AND SIZING.

P1A


OUTSIDE FACE
- VINYL LAMINATED FABRIC COVER - YURT PKG - WOOD LATTICE WALL - YURT PKG - 0' 3 1/2" WOOD STUD - YURT PKG INSIDE FACE

OUTSIDE FACE
- 0' 3/8" KNOTTY PINE BEAD BOARD PANEL
- 0' 3 1/2" WOOD STUD @ 16" O.C. - EXTEND TO 9'-0" A.F.F.
- 0' 3/8" KNOTTY PINE BEAD BOARD PANEL
INSIDE FACE

OUTSIDE FACE - 0' 3/8" KNOTTY PINE BEAD BOARD PANEL - 0' 3 1/2" WOOD STUD @ 16" O.C. - EXTEND TO 9'-0" A.F.F. INSIDE FACE

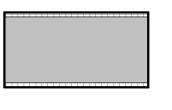


OUTSIDE FACE
- 0' 3/8" KNOTTY PINE BEAD BOARD PANEL
- 0' 5 1/2" WOOD STUD @ 16" O.C. - EXTEND TO 9'-0" A.F.F.
- 0' 3/8" KNOTTY PINE BEAD BOARD PANEL
INSIDE FACE

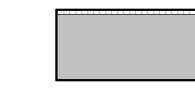

OUTSIDE FACE - 0' 3/8" KNOTTY PINE BEAD BOARD PANEL - 0' 5 1/2" WOOD STUD @ 16" O.C. - EXTEND TO 9'-0" A.F.F. **INSIDE FACE**

STATE OF MISSOURI MICHAEL L. PARSON, **GOVERNOR**

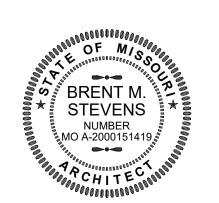

OFFICE OF ADMINISTRATION DIVISION OF FACILITIES MANAGEMENT, **DESIGN AND CONSTRUCTION**

DEPARTMENT OF NATURAL RESOURCES MISSOURI STATE PARKS

TABLE ROCK STATE PARK REPLACE 5 BASIC SITES WITH 5 PREMIUM YURTS

TABLE ROCK STATE PARK CAMPGROUND #2 5272 STATE HWY 165 BRANSON, MISSOURI 65616

PROJECT # X2215-01 7815603018

REVISION: DATE: **REVISION:** DATE: **REVISION:** DATE:

ASSET #


ISSUE DATE: JANUARY 17, 2023

CAD DWG FILE: X221601 A-101 DRAWN BY: HDG CHECKED BY: HDG DESIGNED BY: HDG


SHEET TITLE: OVERALL PLANS

SHEET NUMBER:

SHEET <u>18</u> OF <u>32</u> 1/17/2023 9:12:06 AM

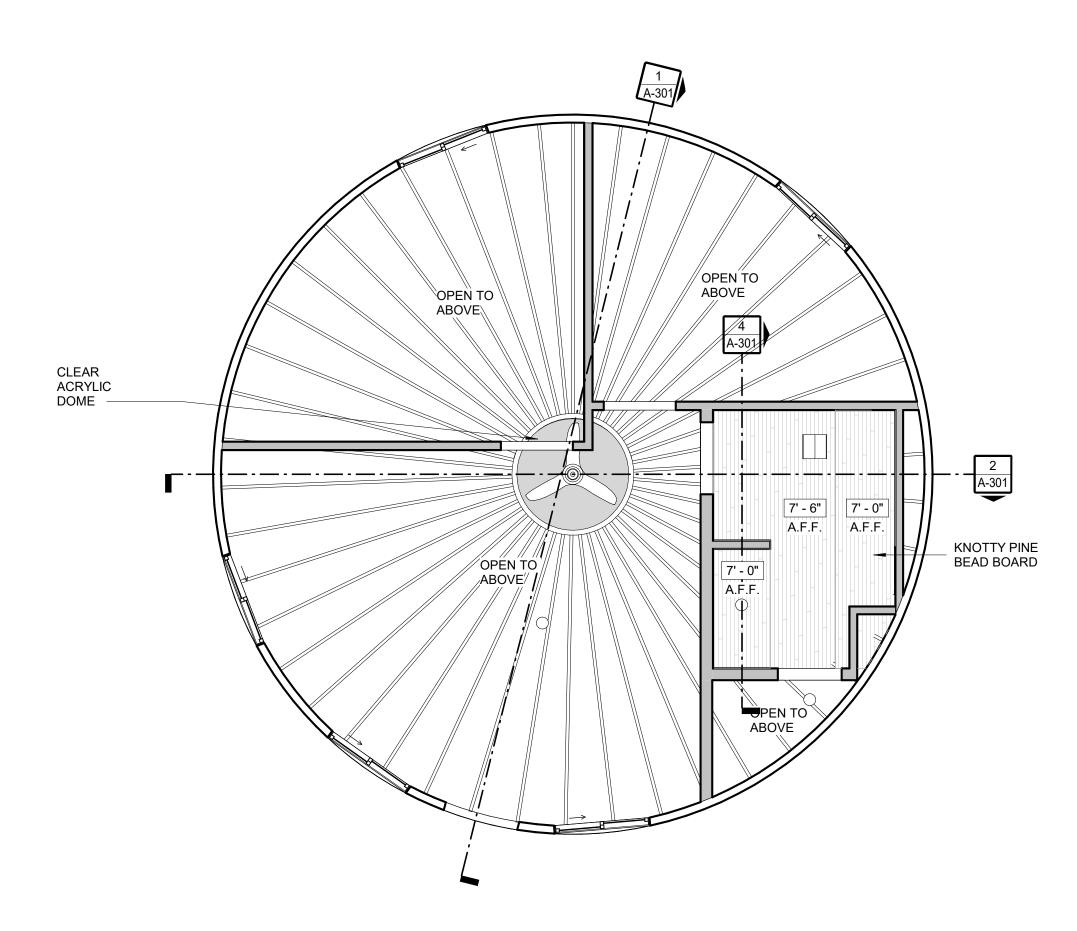

REFLECTED CEILING PLAN scale: 1/4" = 1'-0"

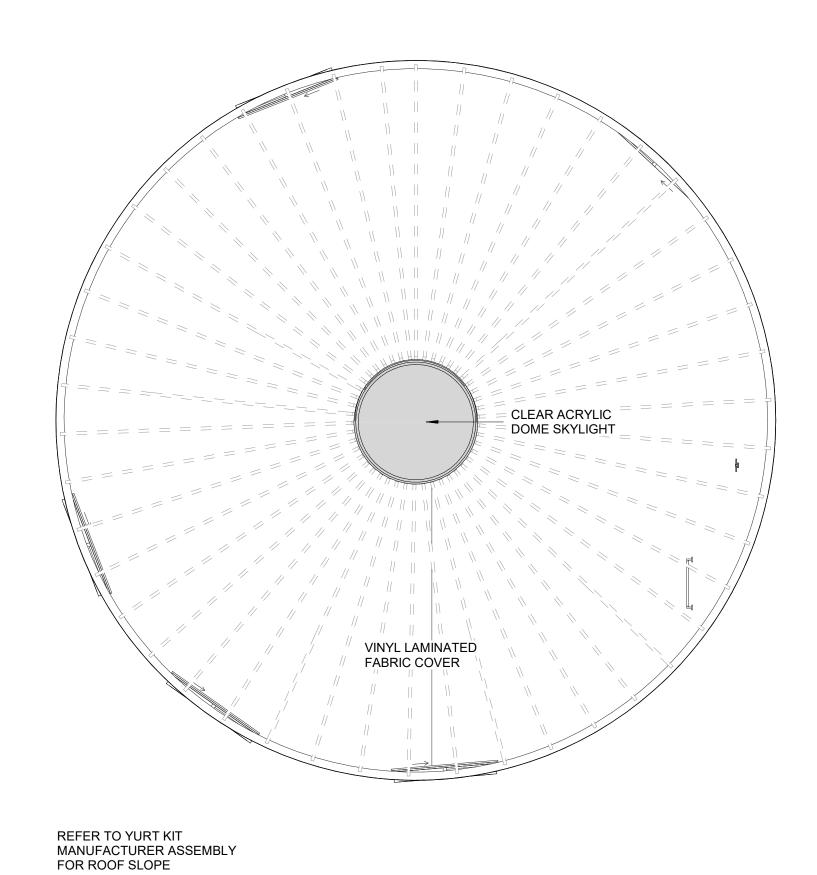

(D-1)

ROOF scale: 1/4" = 1'-0"

INTERIOR FINISH PLAN scale: 1/4" = 1'-0"

FLOOR FINISH LEGEND:

MANUFACTURER: SHAW COLLECTION: DISTINCTION PLUS COLOR: EUCALYPTUS PATTERN: 1/3 OFFSET

MILLWORK:

COUNTERTOPS:

GROUT:

DECKING FINISH:

SOLID KNOTTY PINE

FINISH: CLEAR

THICKNESS: 3CM

TYPE: QUARTZ

SIZE: 2"X4"

ALL TILE TO RECEIVE - UNSANDED GROUT

PATTERN: MOSAIC

EDGE PROFILE: PENCIL

MANUFACTURER: CORIAN

COLOR: SADDLE BROWN

MANUFACTURER: DALTILE

COLLECTION: ESTA VILLA

COLOR: GARDEN WHITE EV97

VERIFY COLOR WITH ARCH.

TYPE: STAINED PRESSURE TREATED PINE

DECKING AND RAILING SURFACES U.N.O.

LOCATION: ALL EXTERIOR EXPOSED

COLOR: MATCH EXISTING, VERIFY WITH ARCH

SHAPE: SQUARE RAISED

INSTALLATION: ALL MILLWORK

LOCATION: ALL COUNTERS U.N.O.

UNLESS NOTED OTHERWISE.

WALL COVERINGS:

KNOTTY PINE BEAD BOARD PANEL FINISH: CLEAR OIL BASED POLYURETHANE INSTALLATION: ALL WALL SURFACES UNLESS NOTED OTHERWISE.

MOISTURE RESISTANT BEAD BOARD PANEL FINISH: PAINTED WHITE, VERIFY WITH ARCH. PORCELAIN TILE: INSTALLATION: BATHROOM WALLS AND CEILING UNLESS NOTED OTHERWISE.

MOLDING

TYPE: BASE & CROWN KNOTTY PINE

PROFLE: 356 FINISH:CLEAR OIL BASED POLYURETHANE INSTALLATION: ALL AREAS UNLESS NOTED OTHERWISE

TYPE: BASE & CROWN MOISTURE RESISTANT MDF PROFLE: 356

FINISH: PAINTED WHITE, VERIFY WITH ARCH. INSTALLATION: BATHROOM

SOLID RADIATA PINE STYLE: 6 PANEL FINISH: CLEAR OIL BASED POLYURETHANE

ALL EXPOSED SURFACES TO RECEIVE FINISH.

TAKE MEASURES TO PROTECT SENSITIVE FIRE SPRINKLERS, HVAC, ELECTRICAL AND ANY OTHER SENSITIVE EQUIPMENT WITHIN THE SPACE.

3. KNOTTY PINE BEAD BOARD TO RECEIVE A CLEAR COAT FINISH.

4. KNOTTY PINE BEAD BOARD IN RESTROOMS TO RECEIVE OIL BASED CLEAR COAT FINISH.

GENERAL NOTES - FINISHES

- ALL FINISHES COLORS SELECTED BY OWNER. SUBMIT SAMPLES TO OWNER'S FOR APPROVAL.
- ALL PAINT SYSTEMS TO BE WASHABLE TYPE. SUBMIT PAINT SAMPLES AND PRODUCT SPEC'S FOR APPROVAL. TWO FINISH COATS PAINT SYSTEM EQUAL
- TO SHERWIN WILLIAM PRO MAR 200 OVER SHERWIN WILLIAM GYP. BD. PRIMER. SUBMIT THREE DIFFERENT 12 x 24 KNOCK DOWN TEXTURE SAMPLES FOR OWNERS SELCTION. CEILING AND WALL TEXTURES WILL NOT BE THE SAME. INTERIOR FLOOR FINISH AND COVERING MATERIAL SHALL BE CLASS I OR
- CLASS II AND COMPLY WITH DOCFF-1 "PILL TEST" (CPSC 16 CFT, PART 1630). SUBMIT MATERIAL SAMPLES AND MANUFACTURER'S TESTING REPORTS FOR CORRIDOR, ROOMS AND ENCLOSED SPACES INTERIOR WALL AND CEILING
- FINISHES TO CLASS C WITH NO GREATER FLAME SPREAD OF 76-200 AND SMOKE DEVELOPED 0-450. ALL WINDOW TREATMENT AND AWNING MATERIAL TO BE FIRE RETARDANT AND
- TESTED IN ACCORDANCE WITH NFPA 286. SLEEPING UNITS BATH ROOM LAVATORY TO BE CULTURED MARBLE COUNTER TOP AND INTEGRAL SINK WITH OVERFLOW AND RECESS BOWL EDGE. PROVIDE
- BACKSPLASH WHERE COUNTER ABUTS WALLS. PAINTER TO FURNISH AND INSTALL BACKER ROD AND CAULKING AROUND PERIMETER OF EXTERIOR WINDOWS AND DOORS. CAULKING COLOR TO MATCH WINDOW/DOOR FINISH. CAULKING EQUAL TO NP-1, OTHERS TO BEE TREMCO DYMONIC FC POLYURETHANE HYBRID.

STATE OF MISSOURI MICHAEL L. PARSON, **GOVERNOR**



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DEPARTMENT OF NATURAL RESOURCES MISSOURI STATE PARKS

TABLE ROCK STATE PARK REPLACE 5 BASIC SITES WITH 5 PREMIUM YURTS

TABLE ROCK STATE PARK CAMPGROUND #2 5272 STATE HWY 165 BRANSON, MISSOURI 65616

PROJECT # X2215-01 **ASSET** # 7815603018

REVISION: REVISION: DATE: **REVISION:** DATE:

ISSUE DATE: JANUARY 17, 2023


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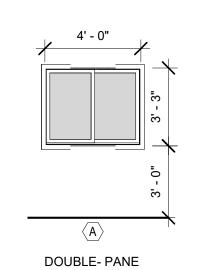
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SHEET NUMBER:


SHEET 19 OF 32 1/17/2023 9:04:59 AM


		DO	OR + FRA	ME SCHEDU	JLE			
		Door Information			Frame Information			
Mark	Туре	Door Material	Door Finish	Door Type	Frame Material	Finish	Frame Type	Comments
101A	3'-0" x 6'-8"	WD	STN	D2	WD	STN	F2	
101B	42" x 42"							
103A	2'-10" x 6'-8"	WD	STN	D1	WD	STN	F1	
103B	3'-0" x 6'-8"	WD	STN	D1	WD	STN	F1	
104A	2'-10" x 6'-8"	WD	STN	D1	WD	STN	F1	
104B	3'-0" x 6'-8"	WD	STN	D1	WD	STN	F1	
105A	2'-10" x 6'-8"	WD	STN	D1	WD	STN	F1	
105B	2'-10" x 6'-8"	WD	STN	D1	WD	STN	F1	
106A	2'-6" x 6'-8"	WD	STN	D1	WD	STN	F1	
106B	2'-6" x 6'-8"	WD	STN	D1	WD	STN	F1	



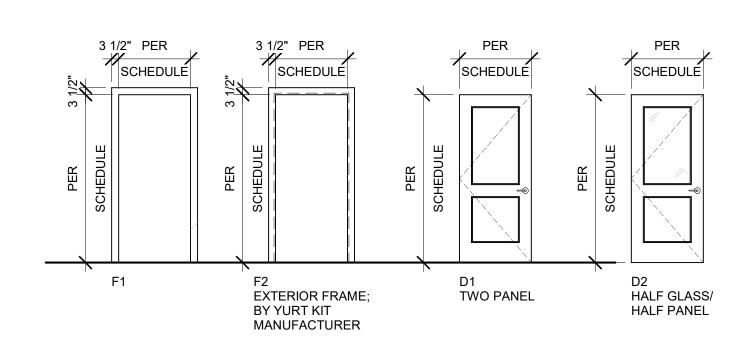

SLIDING WINDOW

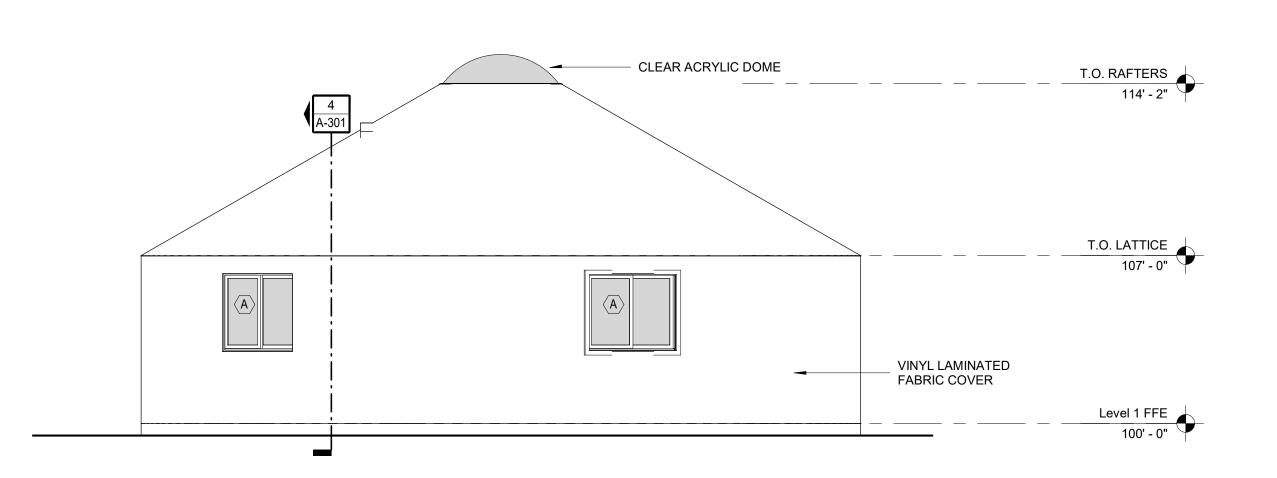


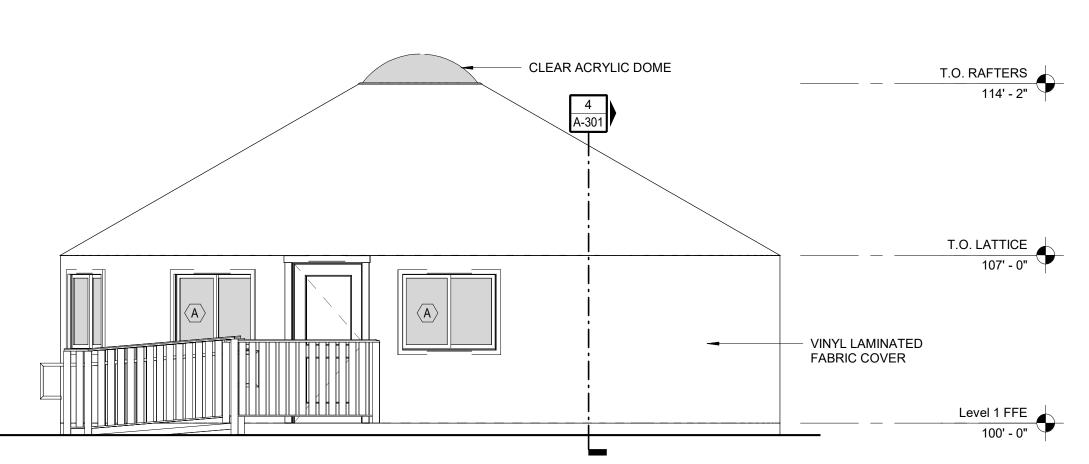




BACK ELEVATION

scale: 1/4" = 1'-0"

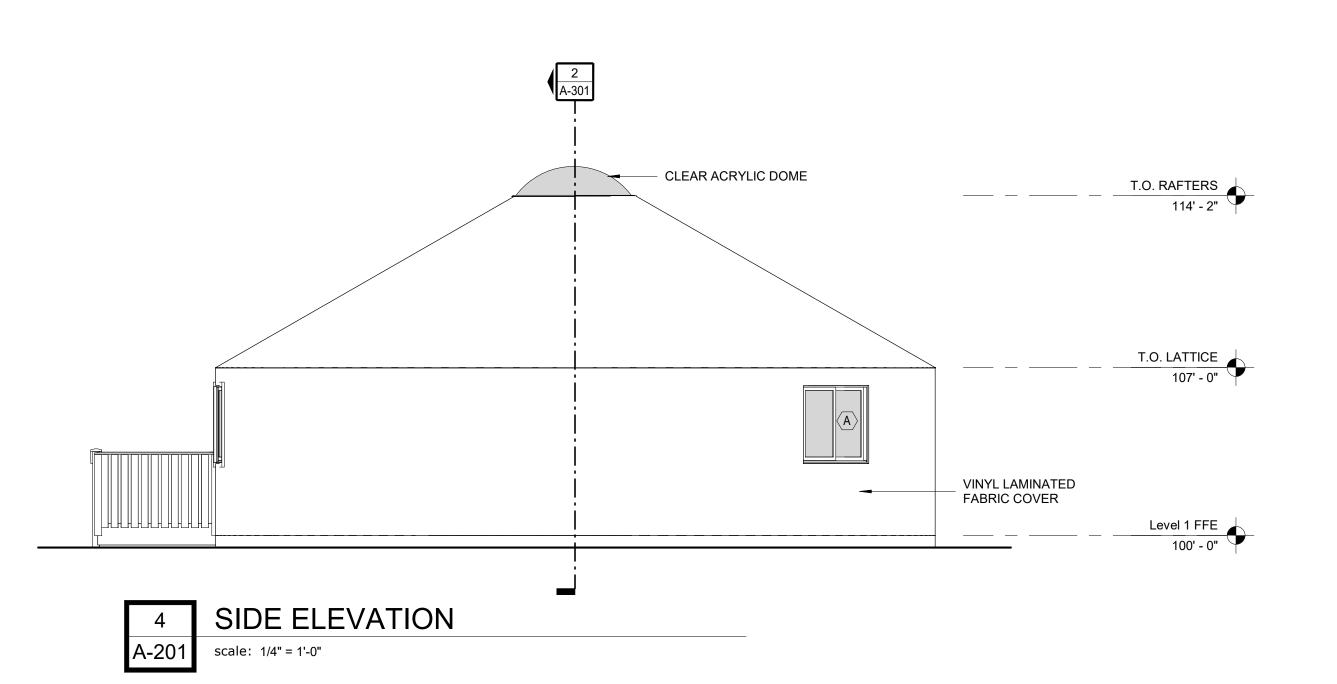

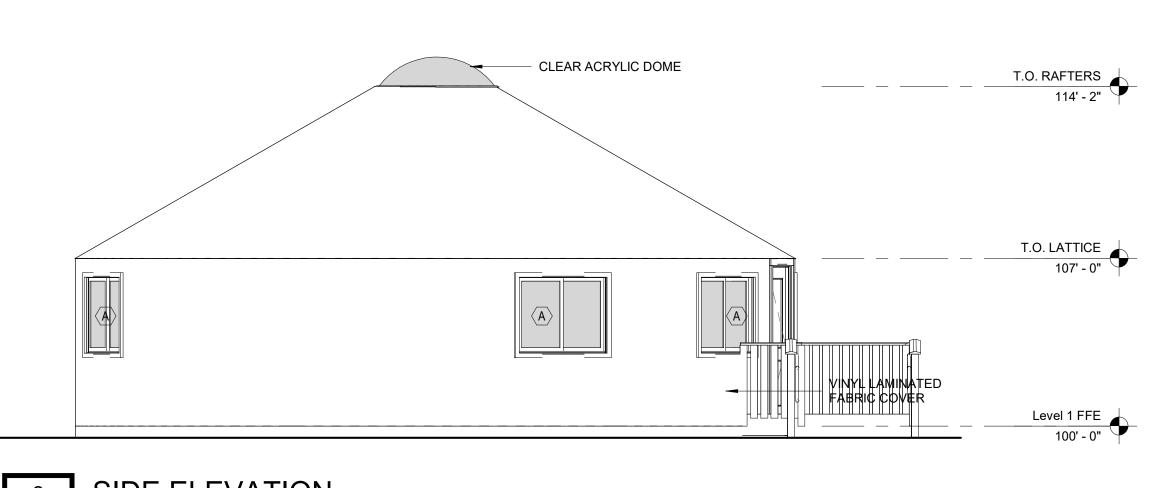

SIDE ELEVATION scale: 1/4" = 1'-0"

GENERAL NOTES - OPENINGS

ABBREVIATIONS:

(ALUM) ALUMINUM FRAME

(HM) HOLLOW METAL
(PF) PRE-FINISHED
(PNT) PAINT
(STN) STAIN
(WD) WOOD
(SC) SOILD CORE

- T = TEMPERED PANES OF GLAZING. ALL PANES WITHIN 18" OF GROUND PLAN, FINISH FLOOR, OR SIDEWALKS SHALL BE TEMPERED. ALL PANES WITHIN AN 18"
- SPHERE OF A DOOR SHALL ALSO BE TEMPERED. FIELD MEASURE ALL OPENINGS PRIOR TO FABRICATION OF FRAMES.

NOTE: YURT PACKAGE BASIS OF DESIGN TO BE PACIFIC YURTS INC. 30' YURT. YURT PACKAGE SHALL INCLUDE STANDARD AND OPTIONAL FEATURES LISTED BELOW.

- LATTICE WALL RAFTERS
- CENTER RING - EXTERIOR ENTRY DOOR
- TINTED ACRYLIC DOME - TENSION CABLE
- SIDE COVER
- VINYL DOUBLE PANE WINDOS - TOP COVER
- RAIN DIVERTER - HARDWARE
- SNOW AND WIND KIT - PERIMETER BLOCKING - 2X6 RAFTER/RING/HARDWARE UPGRADE
- FAN SUPPORT - INSTRUCTIONS

STATE OF MISSOURI MICHAEL L. PARSON, **GOVERNOR**



OFFICE OF ADMINISTRATION DIVISION OF FACILITIES MANAGEMENT, DESIGN AND CONSTRUCTION

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TABLE ROCK STATE PARK CAMPGROUND #2 5272 STATE HWY 165 BRANSON, MISSOURI 65616

PROJECT # X2215-01 **ASSET** # 7815603018

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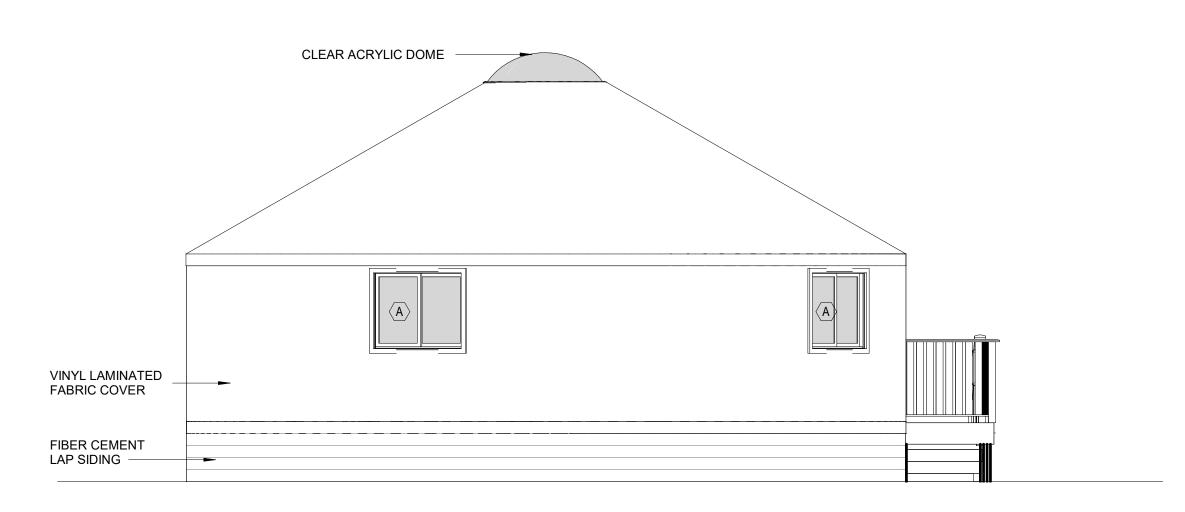
ISSUE DATE: JANUARY 17, 2023

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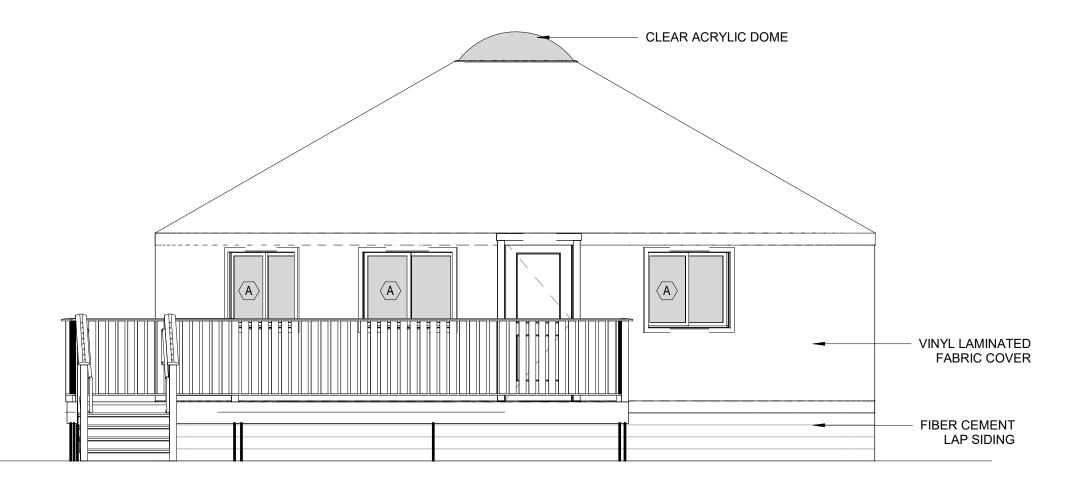
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SHEET NUMBER:

SHEET <u>20</u> OF <u>32</u> 1/17/2023 9:05:02 AM












scale: 1/4" = 1'-0"

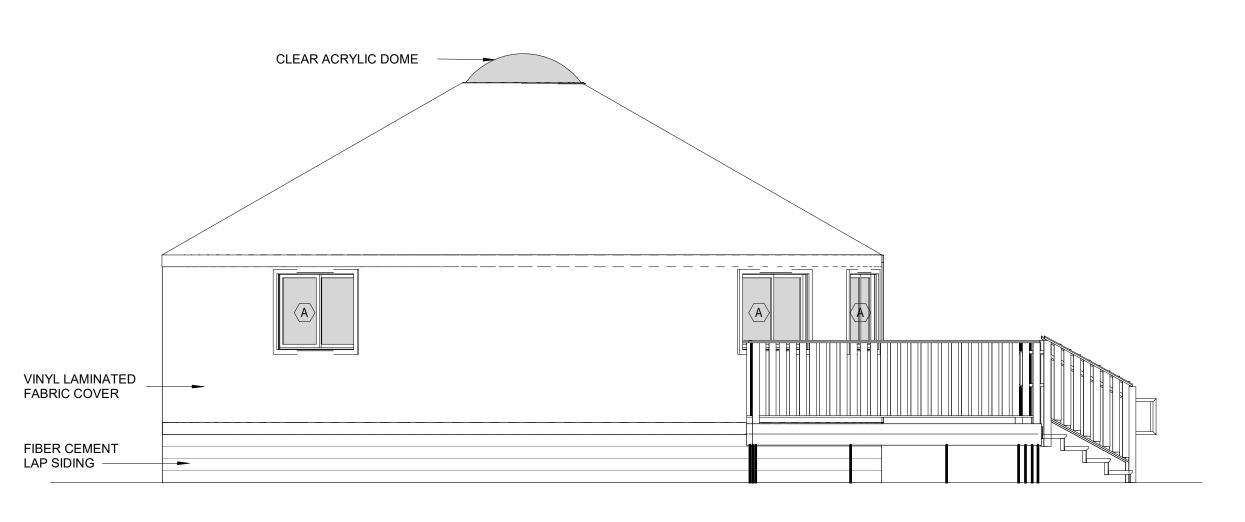

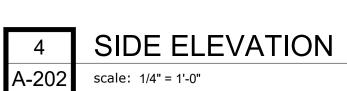

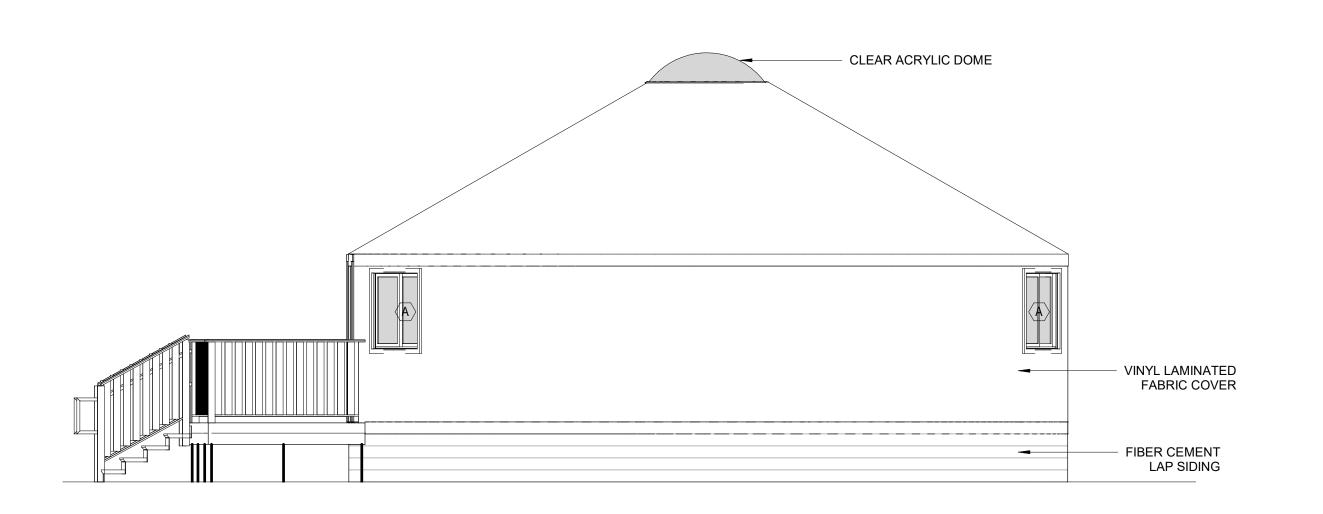

2	SIDE ELEVATION
A-202	scale: 1/4" = 1'-0"

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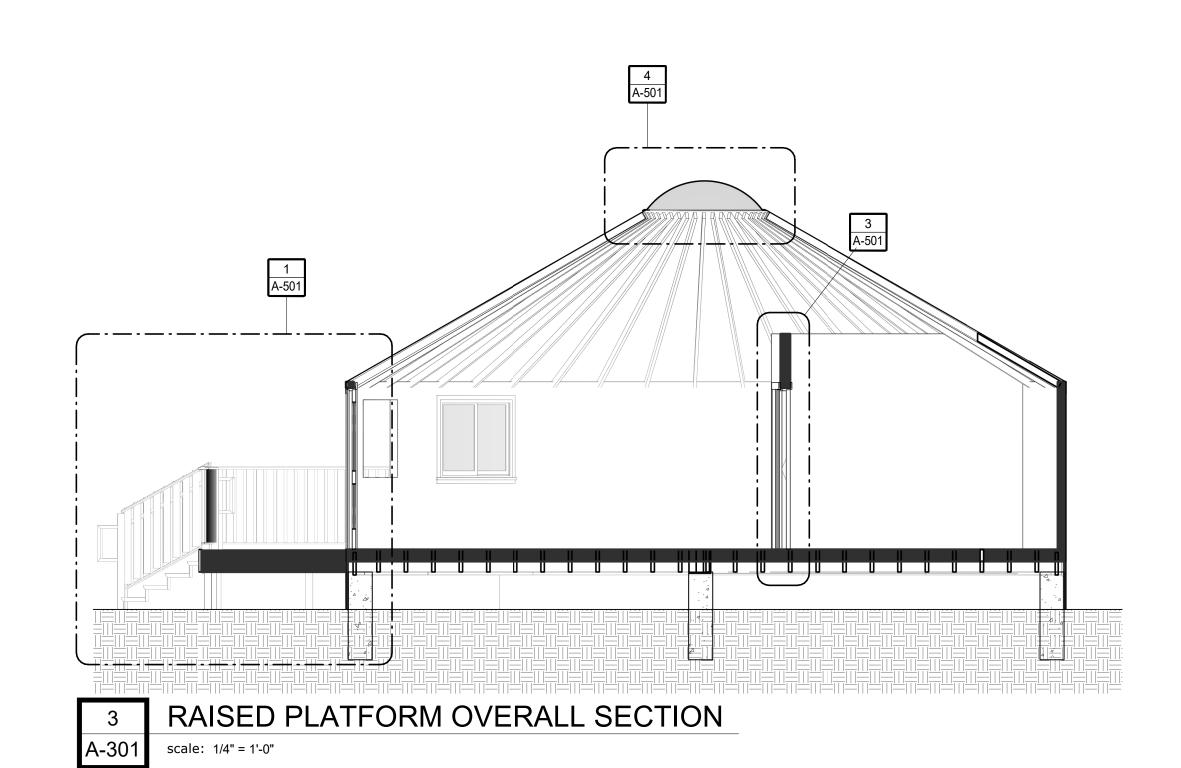
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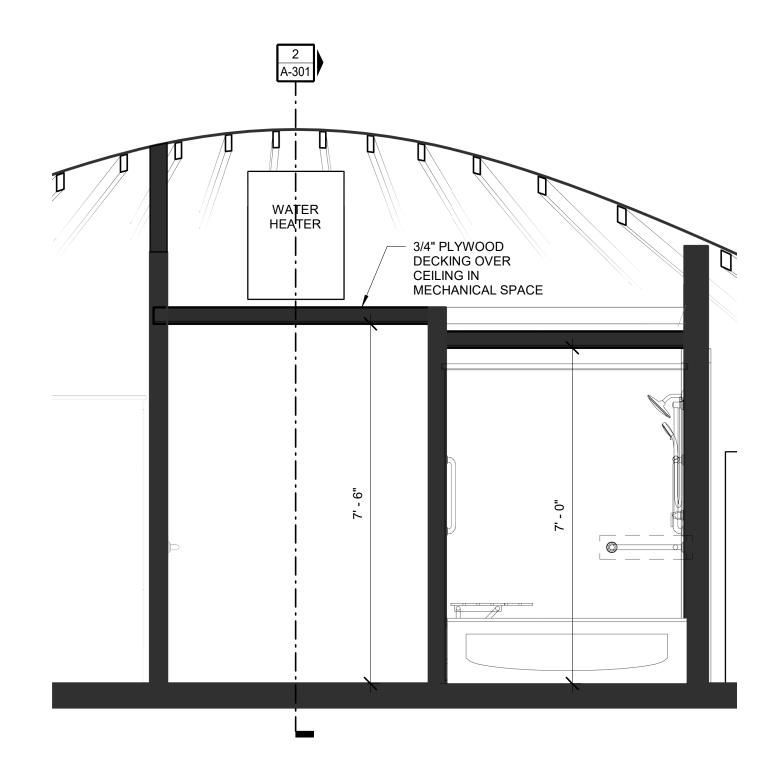
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RAISED PLATFORM ELEVATIONS


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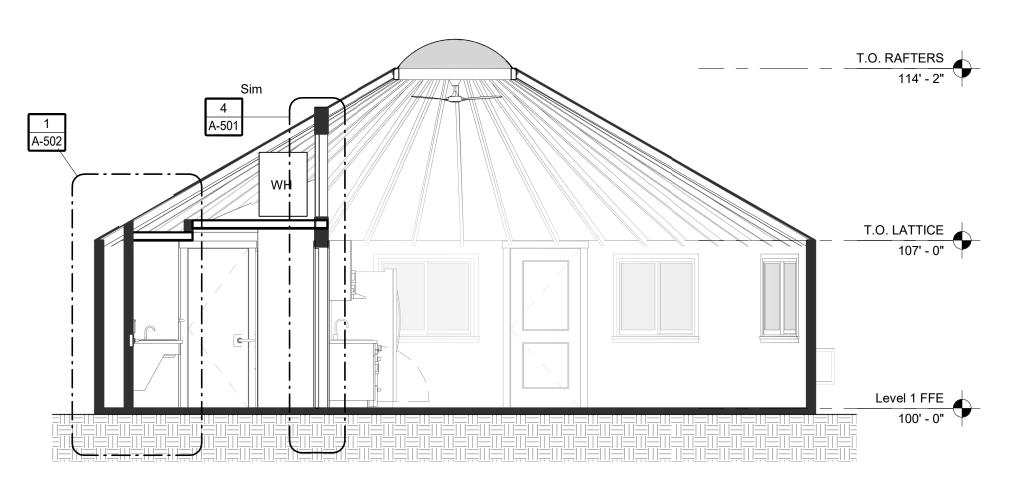




4 ENLARGED SECTION
A-301 scale: 1/2" = 1'-0"





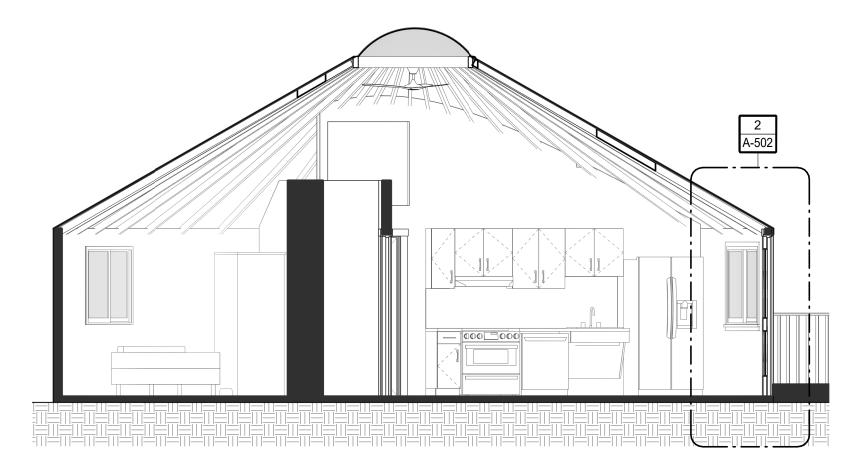

2 **OVERALL SECTION**A-301 scale: 1/4" = 1'-0"

STATE OF MISSOURI MICHAEL L. PARSON, GOVERNOR



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DEPARTMENT OF NATURAL RESOURCES MISSOURI STATE PARKS

TABLE ROCK STATE PARK REPLACE 5 BASIC SITES WITH 5 PREMIUM YURTS

TABLE ROCK STATE PARK CAMPGROUND #2 5272 STATE HWY 165 BRANSON, MISSOURI 65616

PROJECT # X2215-01 SITE # 5603 ASSET # 7815603018

REVISION:
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ISSUE DATE: JANUARY 17, 2023

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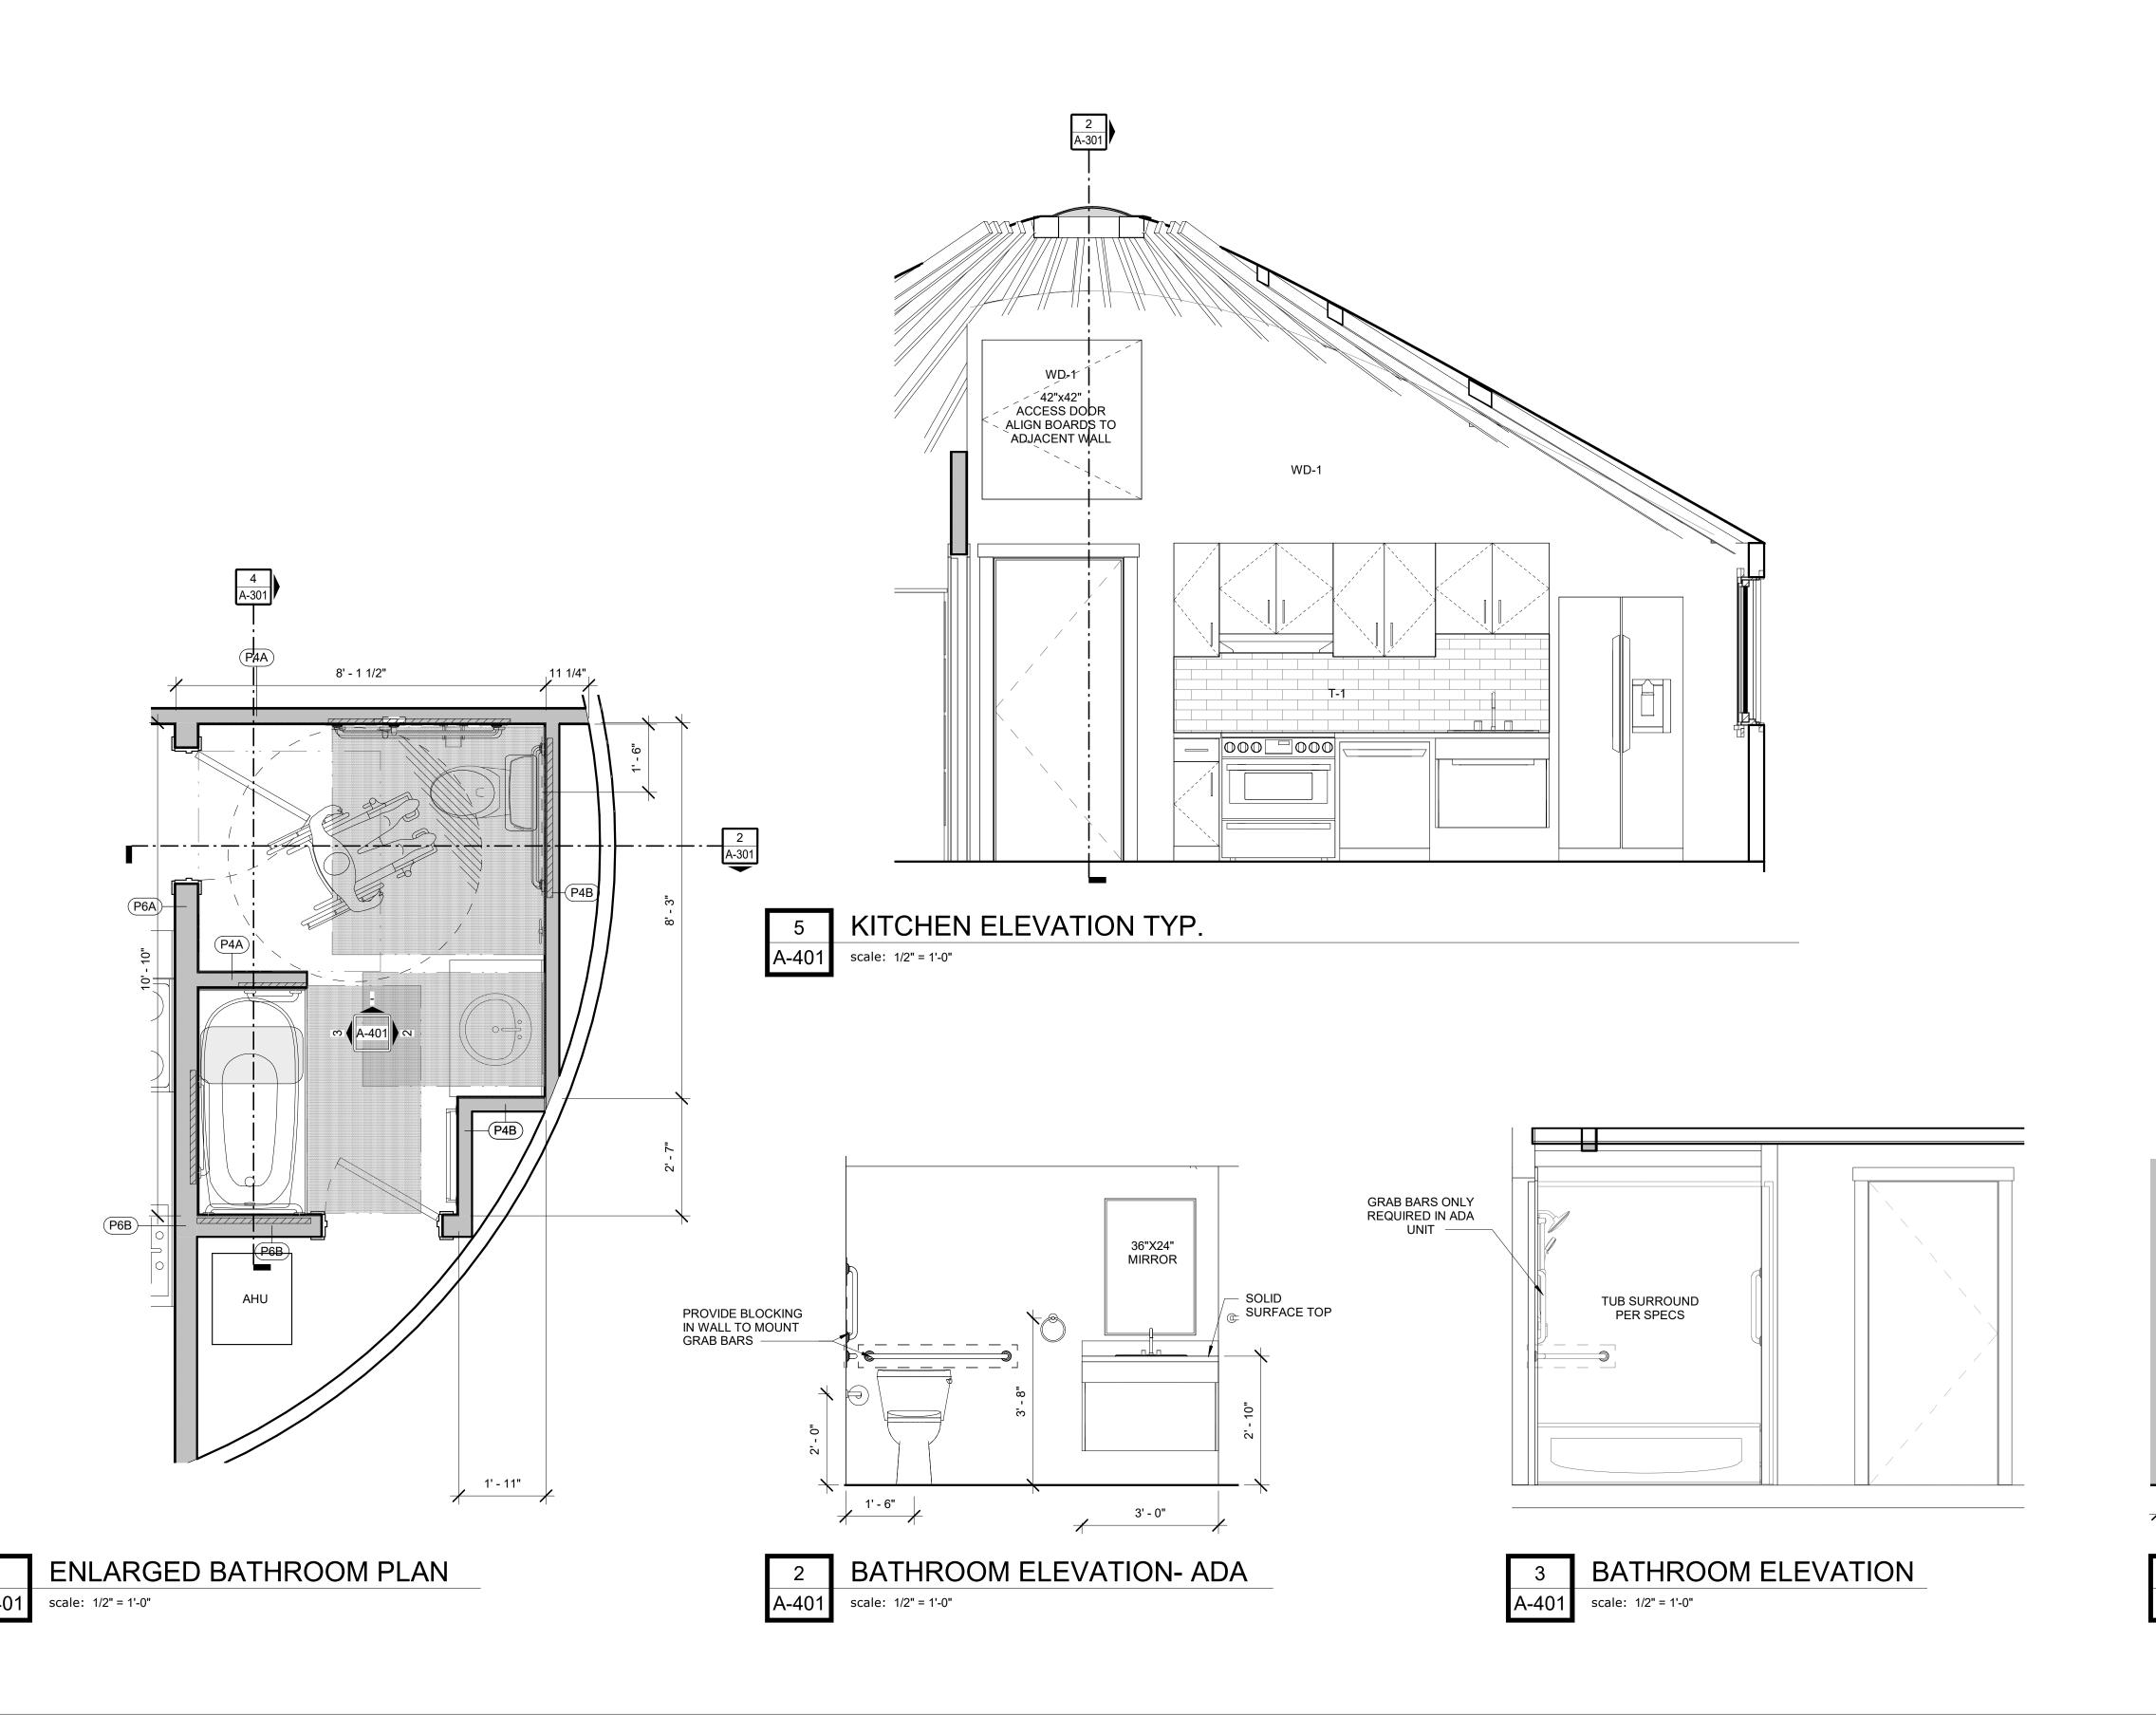
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CHECKED BY: HDG
DESIGNED BY: HDG

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OVERALL
SECTIONS

SHEET NUMBER:


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SHEET <u>22</u> OF <u>32</u> 1/17/2023 9:07:53 AM







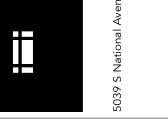

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ISSUE DATE: JANUARY 17, 2023

CAD DWG FILE: X221601 A-401
DRAWN BY: HDG
CHECKED BY: HDG
DESIGNED BY: HDG

SHEET TITLE: ENLARGED VIEWS

36"x24" MIRROR

3' - 0"


BATHROOM ELEVATION

scale: 1/2" = 1'-0"

SOILD SURFACE
 COUNTER TOP

SHEET NUMBER:

SHEET <u>23</u> OF <u>32</u> 1/17/2023 9:08:12 AM

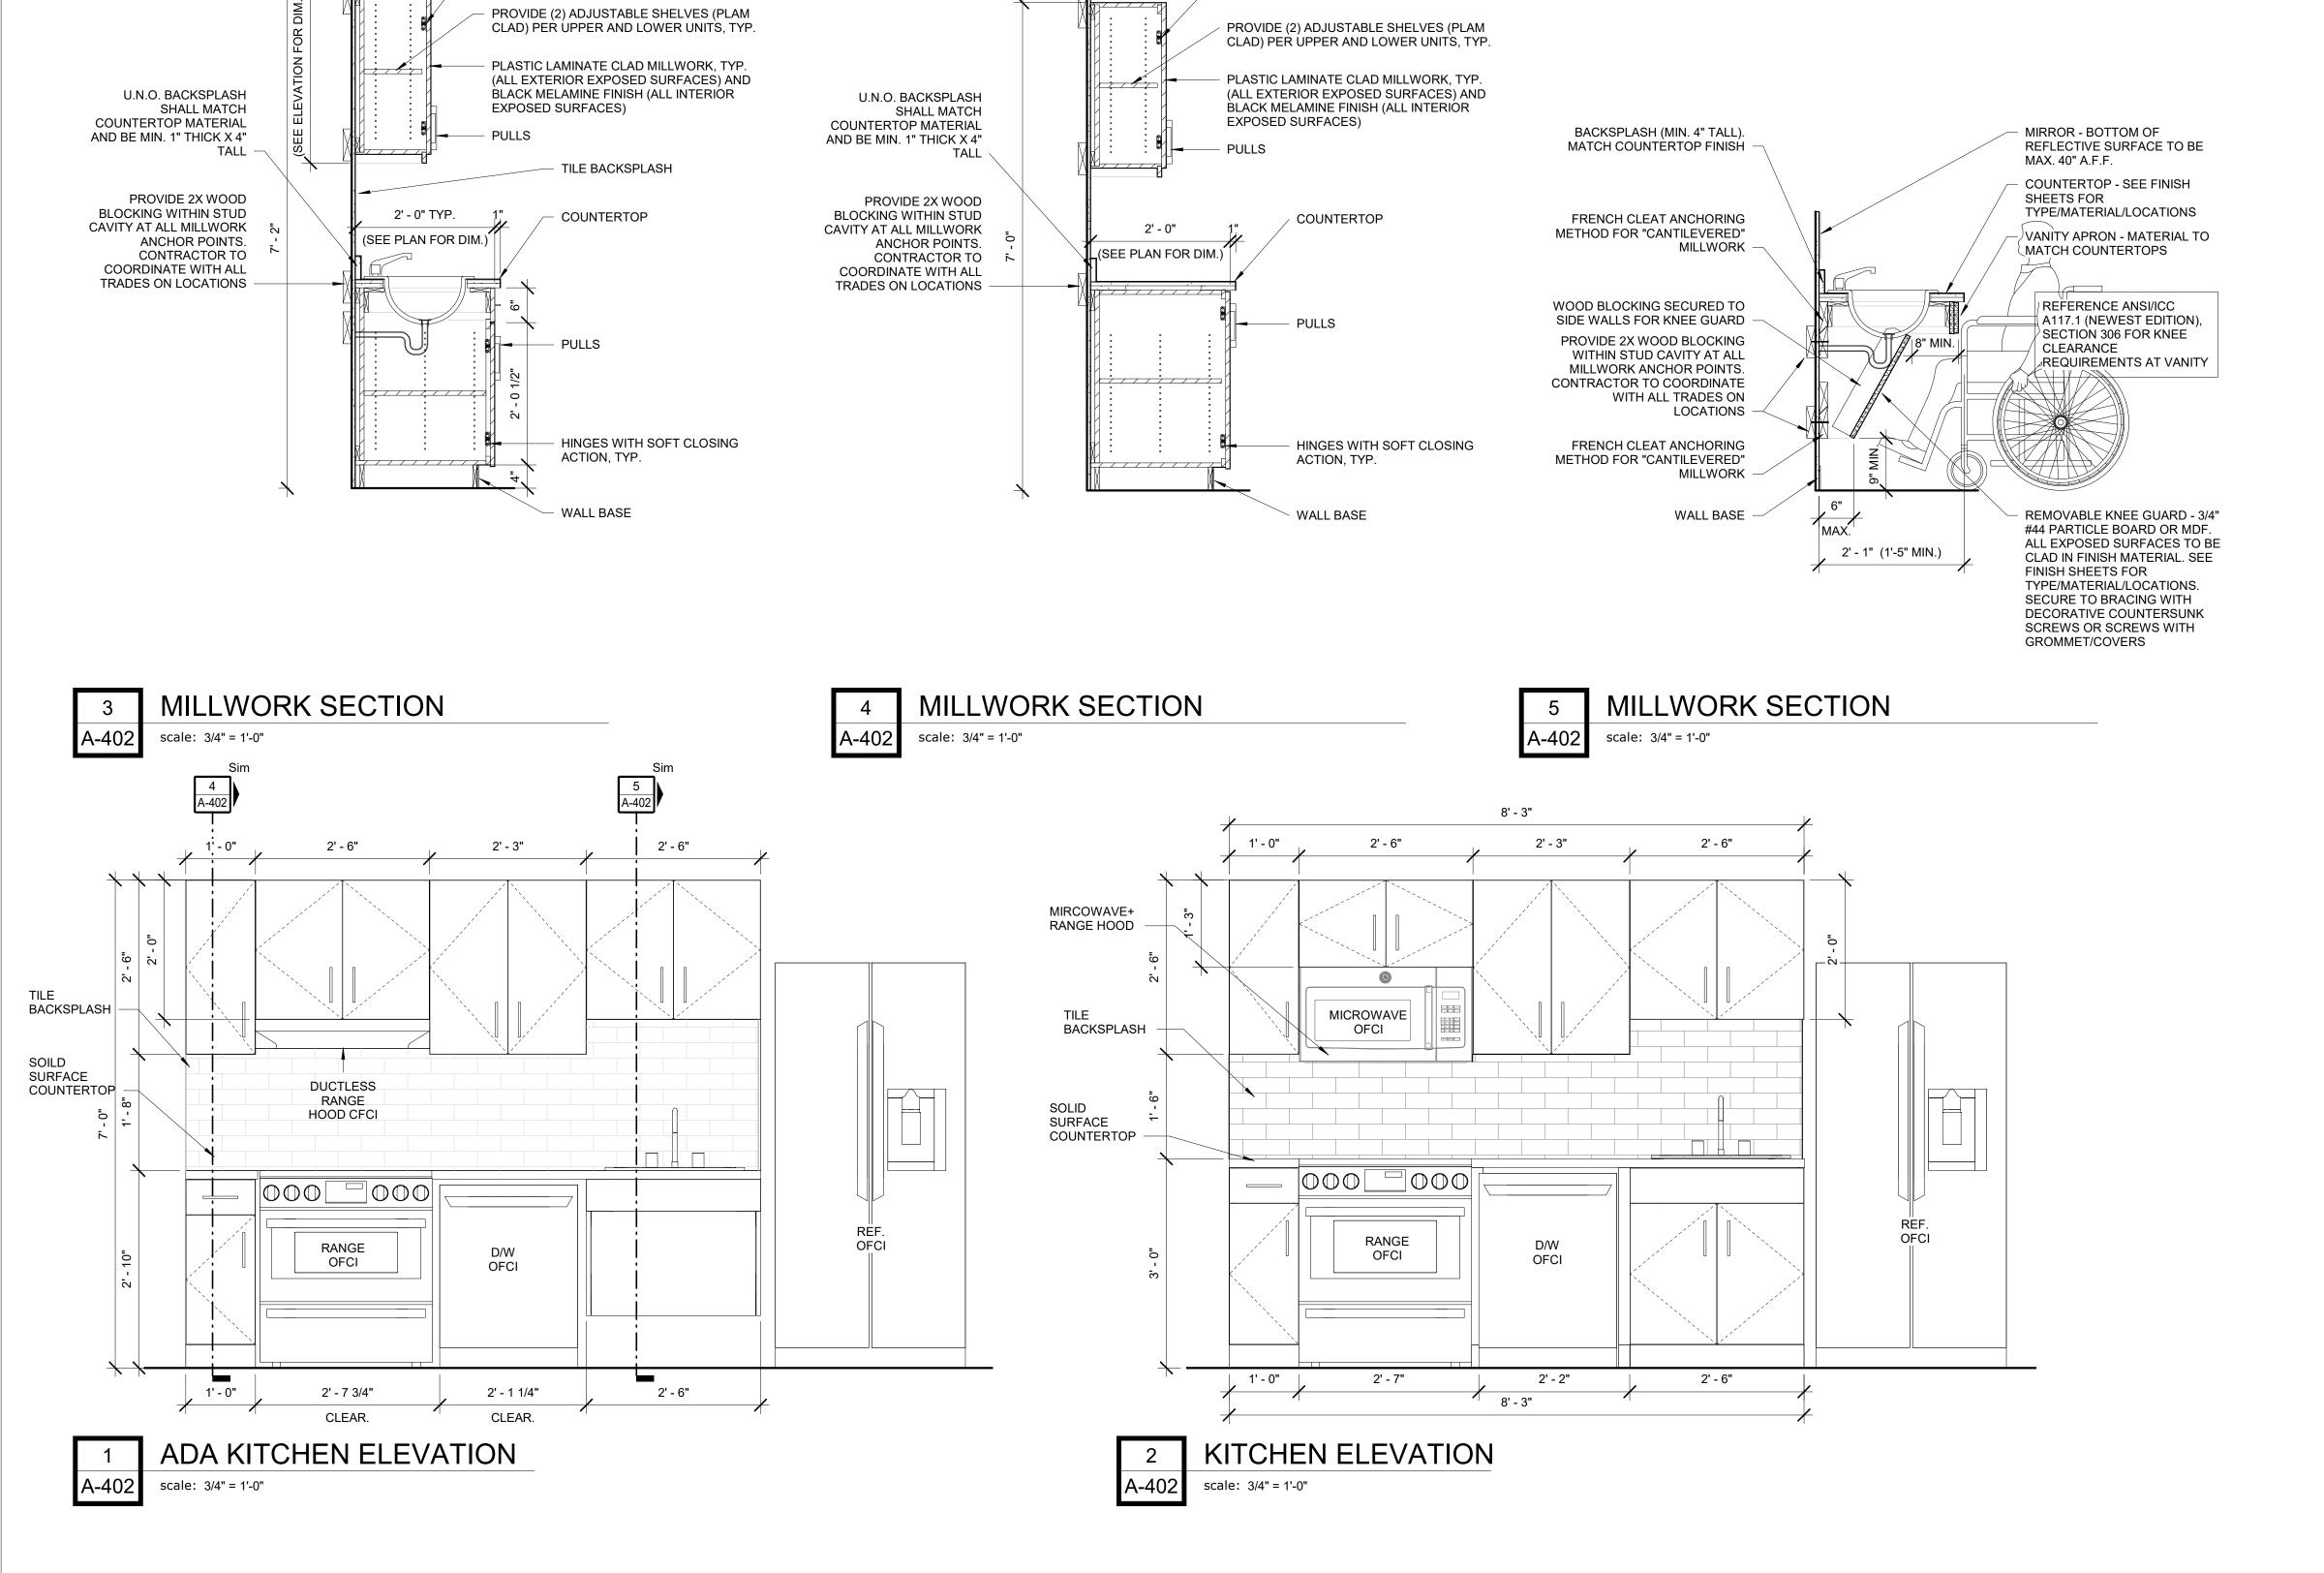

HINGES WITH SOFT CLOSING ACTION, TYP.

1' - 1"

HINGES WITH SOFT CLOSING ACTION, TYP.

GENERAL NOTES - APPLIANCES

1. ALL APPLIANCES HAVE BEEN DESIGNED AROUND INDUSTRY STANDARD CABINET DEPTH AND STANDARD APPLIANCE DIMENSIONS. COORDINATE WITH OWNER(S) ON ANY VARIANCES IN APPLIANCE DIMENSIONS PRIOR TO FABRICATION AND INSTALLATION OF MILLWORK. COORDINATE PRIOR TO SHOP DRAWING SUBMISSION.

GENERAL NOTES - MILLWORK

- COORDINATE FINAL FINISHES AND CABINETRY DETAILS WITH ARCHITECT PRIOR TO FABRICATION. IF THERE IS A DISCREPANCY BETWEEN DETAILS,
- PLEASE NOTIFY ARCHITECT PRIOR TO FABRICATION
- REFER TO INTERIOR FINISH PLAN FOR ROOM FINISH SCHEDULE, MATERIALS LEGEND AND ADDITIONAL WALL AND FLOOR FINISH INFORMATION
 CONSTRUCT WALLS WITH ROUGH OPENINGS AS NEEDED FOR SIZES OF

INSTALL MATCHING WOOD QUARTER ROUND BASE SHOE AT ALL TOEKICK &

- MILLWORK INDICATED
 4. INSTALL MATCHING WOOD SCRIBE AT ALL MILLWORK/WALL JOINTS
- END PANEL / FINISH FLOOR JOINTS. TOEKICKS TO MATCH MILLWORK FINISH
 6. PRIOR TO FABRICATION OF CASEWORK, CONTRACTOR SHALL FIELD VERIFY
- ACTUAL FINISH WALL DIMENSIONS
 7. PROVIDE FINISHED SURFACES ON MILLWORK & COUNTERTOPS WHERE
- EXPOSED TO VIEW

 8. UTILIZE 2X WOOD BLOCKING AS REQUIRED FOR INSTALLATION OF MILLWORK
- WHERE INDICATED AND AS NEEDED FOR SECURE ANCHOR TO WALLS
 9. CONTINUOUS CAULK AROUND ALL FIXTURES AT FLOORS, WALLS, ETC.
- 10. PROVIDE 1/4" GAP BETWEEN ALL DOORS, DRAWERS, LATERAL FILE, AND OTHER MOVEABLE PIECES OF MILLWORK
- 11. COUNTERTOPS TO BE SOLID SURFACE MATERIAL PER SPEC IN ALL PUBLIC AREAS AND WET AREAS.
- 12. ALL HARDWARE TO BE OIL RUBBED BRONZE FINISH.

STATE OF MISSOURI MICHAEL L. PARSON, GOVERNOR



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PROJECT # X2215-01 SITE # 5603 ASSET # 7815603018

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DATE:

ISSUE DATE: JANUARY 17, 2023


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DRAWN BY: HDG
CHECKED BY: HDG
DESIGNED BY: HDG

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INTERIOR
ELEVATIONS


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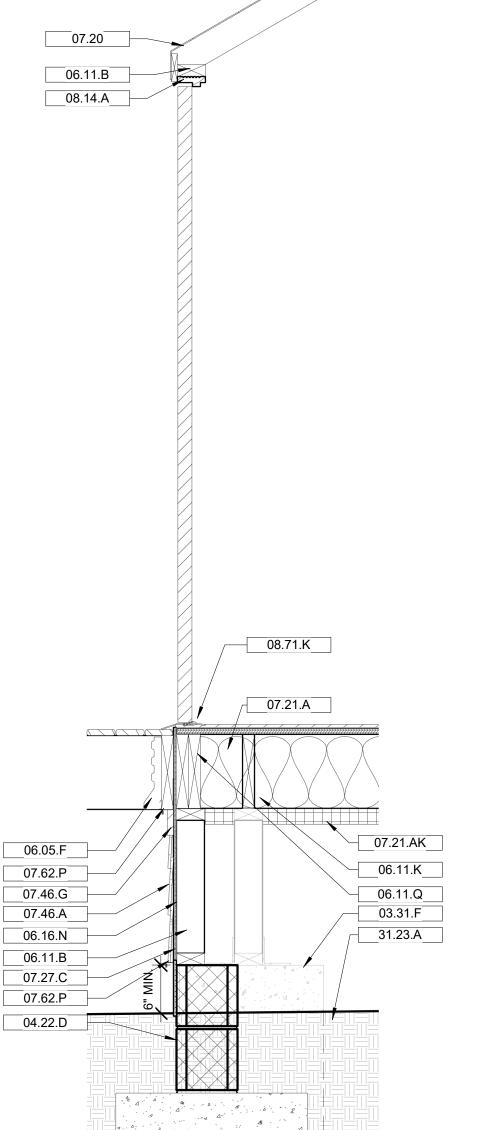
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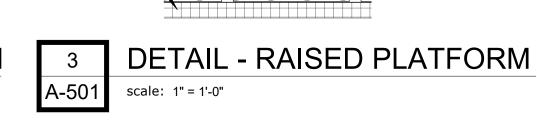





WALL SECTION - RAISED PLATFORM
scale: 1/2" = 1'-0"

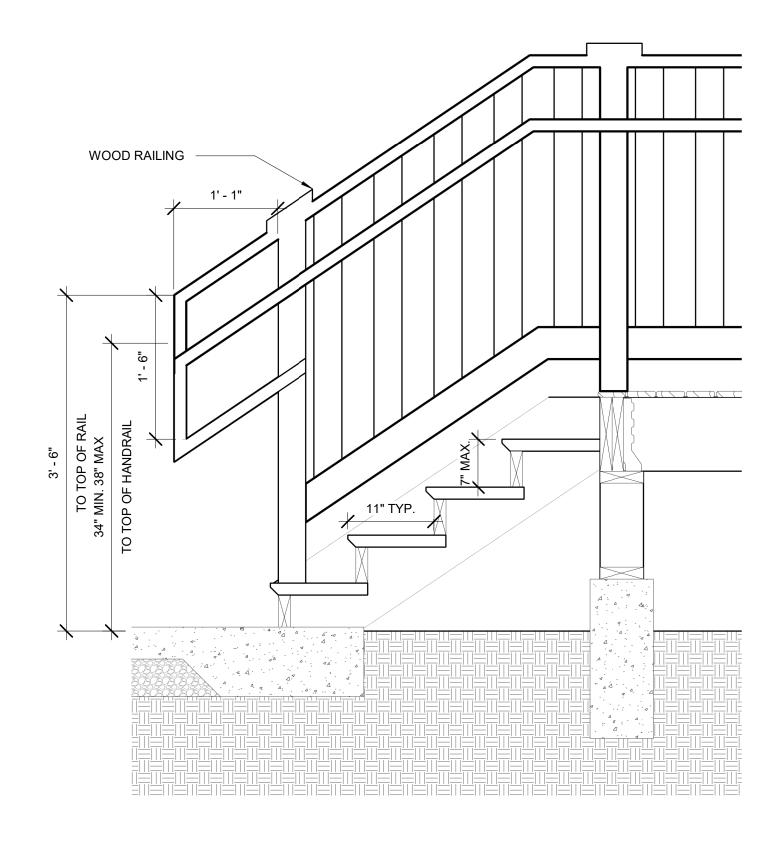



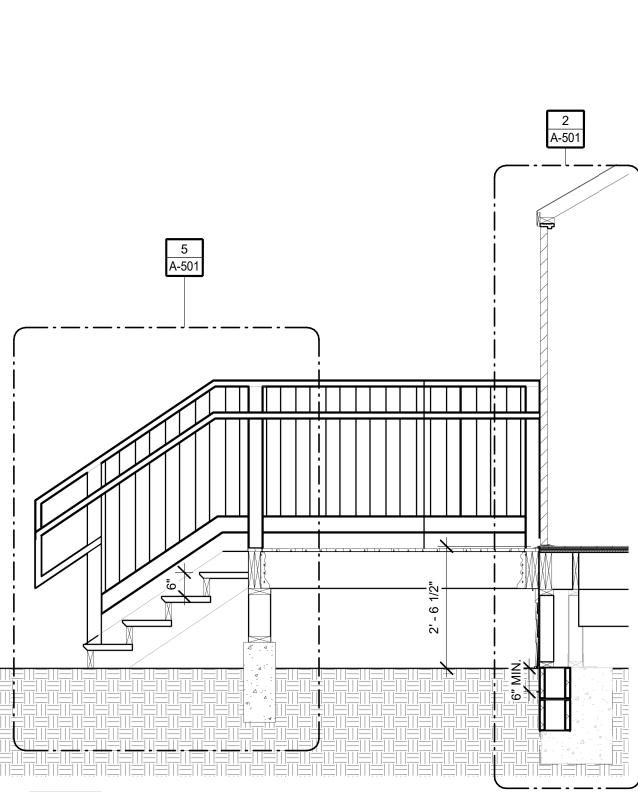

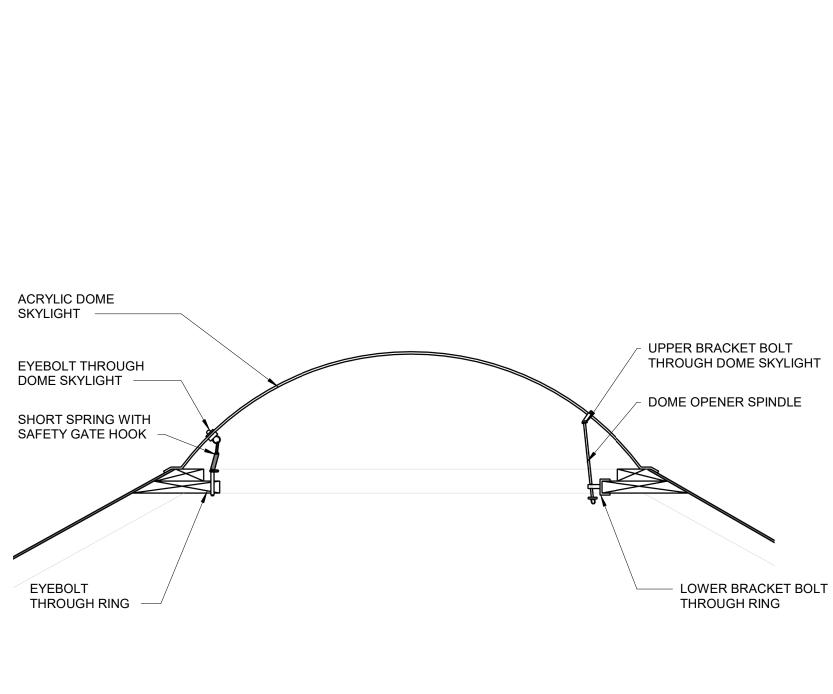

DETAIL

scale: 1" = 1'-0"

KEYNOTE LEGEND

GENERAL NOTES - RAILINGS

FLOOR AT THE TOP OF A FLIGHT.

TREAD & RISER: STAIR RISER HEIGHTS SHALL BE 7 INCHES MAXIMUM AND 4" MINIMUM AND SHALL BE OF UNIFORM SIZE & SHAPE. STAIR TREAD DEPTHS SHALL BE 11" MINIMUM. THE RADIUS AT THE CURVATURE OF THE LEADING EDGE OF THE TREAD SHALL BE NOT GREATER THAN 1/2". BEVELING OF NOSINGS SHALL NOT EXCEED 1/2". RISERS SHALL BE SOLID AND VERTICAL OR SLOPED FROM THE UNDERSIDE OF THE LEADING EDGE OF THE TREAD ABOVE

AT AN ANGLE NOT MORE THAN 30 DEGREES FROM THE VERTICAL. THE LEADING EDGE (NOSINGS) OF TREADS SHALL PROJECT NOT MORE THAN 1.25 INCHES BEYOND THE TREAD BELOW AND ALL PROJECTIONS OF THE LEADING

EDGES SHALL BE OF UNIFORM SIZE, INCLUDING THE LEADING EDGE OF THE

HANDRAILS: STAIRS SHALL HAVE HANDRAILS ON EACH SIDE AT A UNIFORM

HEIGHT OF 34" TO 38" ABOVE STAIR TREAD NOSINGS. HANDRAILS WITH A CIRCULAR CROSS SECTION SHALL HAVE AN OUTSIDE DIAMETER OF AT LEAST 1.25 INCHES AND NOT GREATER THAN 2 INCHES. IF THE HANDRAIL IS NOT CIRCULAR, IT SHALL HAVE A PERIMETER DIMENSIONS OF AT LEAST 4 INCHES AND NOT GREATER THAN 6.25 INCHES WITH A MAXIMUM CROSS-SECTION DIMENSIONS OF 2.25 INCHES. EDGES SHALL HAVE A MINIMUM RADIUS OF 0.125

HORIZONTALLY AT LEAST 12 INCHES BEYOND THE TOP RISER AND CONTINUE TO SLOPE FOR THE DEPTH OF ONE TREAD BEYOND THE BOTTOM RISER. CLEAR SPACE BETWEEN A HANDRAIL AND A WALL SHALL NOT EXCEED 4.5 INCHES AT OR BELOW THE HANDRAIL HEIGHT AND SHALL NOT BE LESS THAN

INCHES. HANDRAILS SHALL RETURN TO A WALL AND SHALL EXTEND

WIDTH: STAIRWAY WIDTH SHALL NOT BE LESS THAN 44" CLEAR.

03.30A	UNDERSLAB VAPOR RETARDER. SEE SPEC SECTION 033099 "UNDERSLAB VAPOR RETARDER" FOR MORE INFOMRATION.
03.31.A	THICKENED SLAB. SEE STRUCTURAL DRAWINGS FOR MORE INFORMATION.
03.31.F	CAST-IN-PLACE CONCRETE WALL PER STRUCTURAL. SEE STRUCTURAL DRAWINGS FOR MORE INFORMATION.
03.31.G	CAST-IN-PLACE CONCRETE FOOTING PER STRUCTURAL. SEE STRUCTURAL DRAWINGS FOR MORE INFORMATION.
04.22.D	CONCRETE UNIT MASONRY, 8"X8"X16", 2-CORE, WITH FULLY GROUTED CORES. SEE STRUCTURAL DRAWINGS/SPECIFICATIONS FOR MORE INFORMATION.
06.05.F	ENGINEERED JOIST HANGER CONNECTOR. SEE STRUCTURAL FOR MORE INFORMATION.
06.11.B	2x4 FRAMING. SEE STRUCTURAL FOR MORE INFORMATION INCLUDING SPECIES, DETAILS, SPACING, AND MORE INFORMATION.
06.11.K	2X WOOD FRAMING - USE TREATED WOOD BLOCKING IN EXTERIOR OR WET APPLICATIONS. SEE STRUCTURAL FOR MORE INFORMATION INCLUDING SPECIES, DETAILS, SPACING, AND MORE INFORMATION.
06.11.Q	CONTINUOUS 2X RIM BOARD - USE TREATED WOOD BLOCKING IN EXTERIOR OR WET APPLICATIONS. SEE STRUCTURAL FOR MORE INFORMATION INCLUDING SIZE, SPECIES, DETAILS, SPACING, AND MORE INFORMATION.
06.16.L	1/2" EXTERIOR GRADE PLYWOOD SHEATHING.
06.16.M	5/8" EXTERIOR GRADE PLYWOOD SHEATHING.
06.16.N	3/4" EXTERIOR GRADE PLYWOOD SHEATHING.
07.20	YURT SURROUND PER YURT MANUFACTURE.
07.21.A	SOUND BATT INSULATION, ENTIRE CAVITY, TYPICAL AT ALL INTERIOR WALLS, UNLESS NOTED OTHERWISE. SEE SPECIFICATIONS FOR MORE INFORMATION.
07.21.AK	2-1/2" RIGID INSULATION. SEE SPECIFICATIONS FOR MORE INFORMATION.
07.27.C	FLUID-APPLIED WEATHER RESISTIVE BARRIER (WRB) SYSTEM. SEE SPECIFICATIONS FOR MORE INFORMATION. SYSTEM JOINT/CORNER TAPE TO BE APPLIED AT ALL PANEL JOINTS, SILLS/JAMBS/HEADS OF ALL OPENINGS, AT INSIDE/OUTSIDE CORNERS, PENETRATIONS, AND AT ALL MANUFACTURER REQUIRED LOCATIONS; SYSTEM TO WRAP OVER ANY PARAPET; AND SYSTEM TO PROVIDE A CONTINUOUS BUILDING ENVELOPE.
07.46.A	FIBER-REINFORCED CEMENT HORIZONTAL SIDING (PROFILE 1) WITH INTEGRAL COLOR. SEE SPECIFICATIONS FOR MORE INFORMATION. SEE ELEVATION SHEETS FOR LOCATION OF TRIM/JOINTS.
07.46.G	FIBER-REINFORCED CEMENT TRIM BOARD, 4" EXPOSED FACE. SEE SPECIFICATIONS FOR MORE INFORMATION.
07.62.A	PREFORMED, PREFINISHED ALUMINUM FLASHING. SEE SPECIFICATIONS AND DETAILS FOR MORE INFORMATION. ALL EXPOSED EDGES TO BE HEMMED.
07.62.P	PREFORMED, PREFINISHED BASE + COUNTER FLASHING WITH INTEGRAL DRIPS TO COVER CONTINUOUS CLEAT. PROVIDE MINIMUM INDICATED VERTICAL LEG. ALL EXPOSED EDGES TO BE HEMMED. SEE DETAIL SHEETS (ALL DISCIPLINES) FOR MORE INFORMATION.
07.95.K	FIBROUS EXPANSION JOINT FILLER.
08.14.A	WOOD DOOR/FRAME ASSEMBLY. SEE DETAILS, SPECIFICATIONS, AND A3 SERIES SHEETS FOR MORE INFORMATION.
08.71.K	THRESHOLDS. SEE DOOR HARDWARE SCHEDULE, SPECIFICATIONS, DETAILS, AND A3 SERIES SHEETS FOR MORE INFORMATION.
09.60	FLOORING
09.64.A	HARDWOOD FLOORING. SEE FINISH PLANS, FINISH SCHEDULE, DETAILS, AND/OR SPECIFICATIONS FOR MORE INFORMATION.
09.72.B	VINYL WALLCOVERING. SEE FINISH PLANS, FINISH SCHEDULE, DETAILS, AND/OR SPECIFICATIONS FOR MORE INFORMATION.
09.77.D	3/8" KNOTTY PINE BEAD BOARD.
31.23.A	FINISH GRADE AND EARTHWORK BACKFILL (SLOPE FINISH GRADE MIN. 1/8" PER 1'-0" AWAY FROM BUILDING FOR A MIN. 5'-0"). SEE CIVIL, STRUCTURAL, AND ARCHITECTURAL DETAIL SHEETS AND SPECIFICATIONS FOR MORE INFORMATION

GRAVEL. SEE CIVIL, STRUCTURAL, AND ARCHITECTURAL DETAIL SHEETS AND

COMPACTED GRAVEL SUB-BASE. SEE CIVIL, STRUCTURAL, AND

ARCHITECTURAL DETAIL SHEETS AND SPECIFICATIONS FOR MORE

SPECIFICATIONS FOR MORE INFORMATION.

INFORMATION.

OFFICE OF ADMINISTRATION DIVISION OF FACILITIES MANAGEMENT, DESIGN AND CONSTRUCTION

STATE OF MISSOURI

MICHAEL L. PARSON,

GOVERNOR

STEVENS

MO A-2000151419

NUMBER

DEPARTMENT OF NATURAL RESOURCES MISSOURI STATE PARKS

TABLE ROCK STATE PARK REPLACE 5 BASIC SITES WITH 5 PREMIUM YURTS

TABLE ROCK STATE PARK CAMPGROUND #2 5272 STATE HWY 165 BRANSON, MISSOURI 65616

PROJECT # X2215-01 SITE # 5603 ASSET # 7815603018

ISSUE DATE: JANUARY 17, 2023

CAD DWG FILE: X221601 A-501
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CHECKED BY: HDG
DESIGNED BY: HDG


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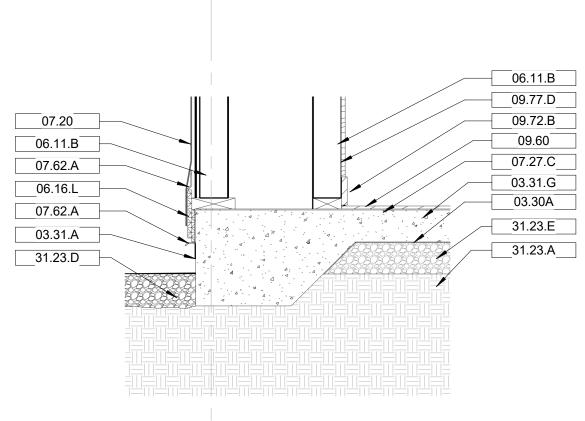
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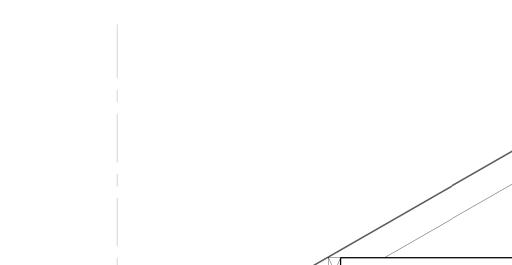
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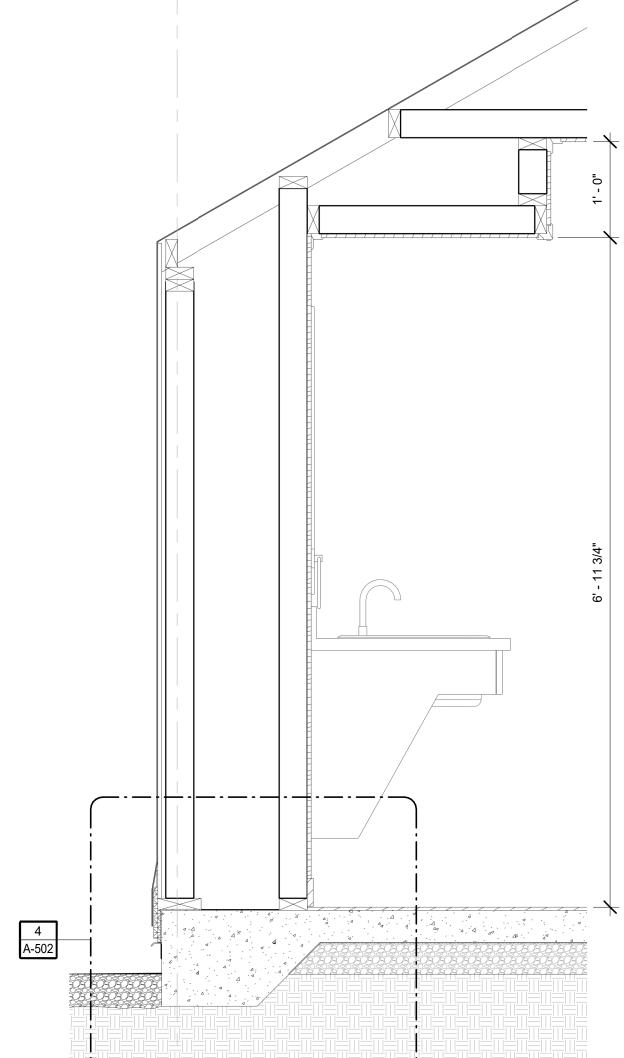
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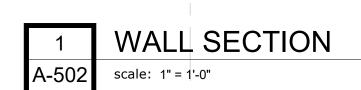













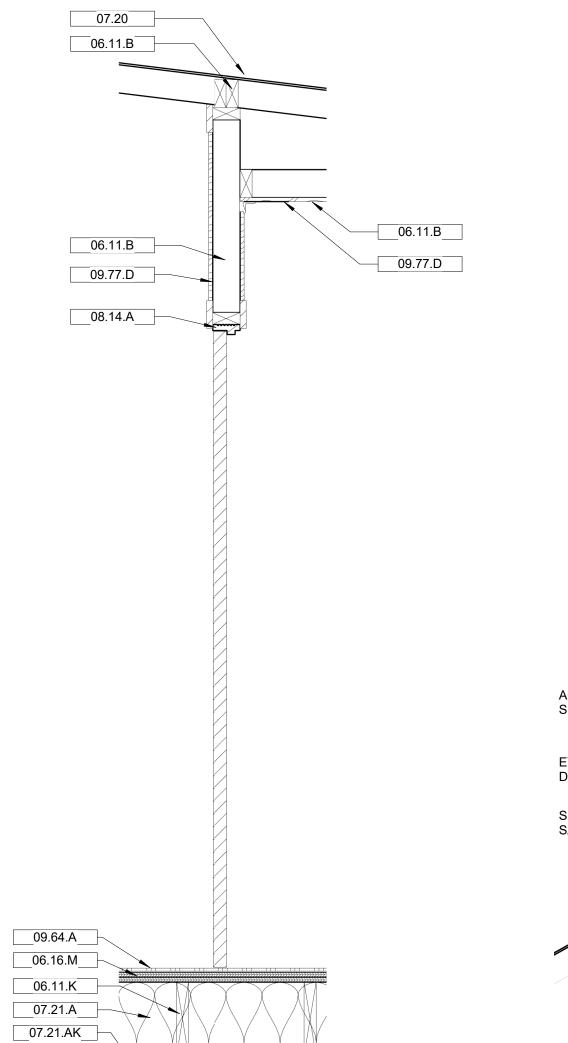


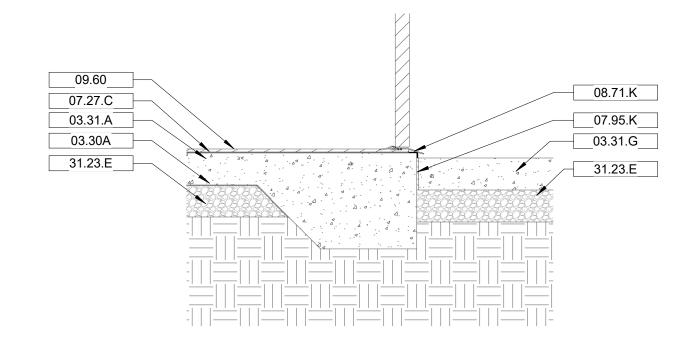



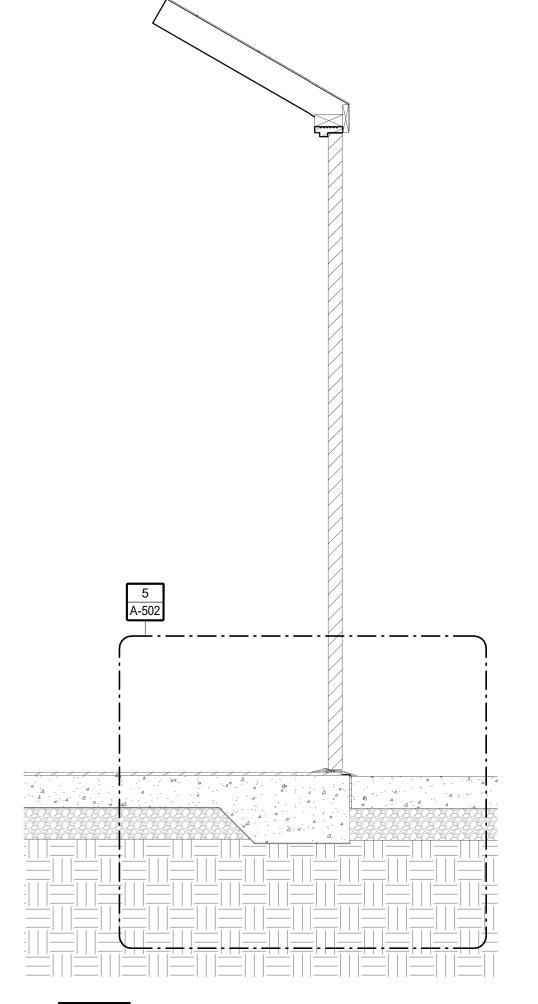

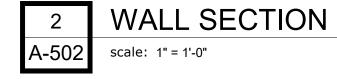

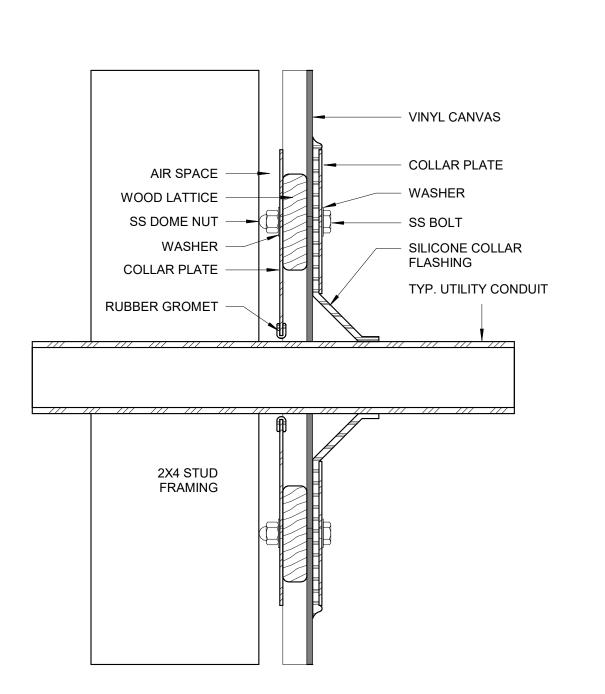

TYP. EXTERIOR WALL PENETRATION scale: 6" = 1'-0"

KEYNOTE LEGEND

03.30A

03.31.A 03.31.F

03.31.G

04.22.D

06.05.F

06.11.B

06.11.K

06.11.Q

06.16.L

06.16.M

06.16.N

07.20

07.21.A

07.21.AK 07.27.C

07.46.A

07.46.G

07.62.A

07.62.P

07.95.K 08.14.A

08.71.K

09.60 09.64.A

09.72.B

09.77.D 31.23.A

31.23.D

31.23.E

OTE LEGEND	MICHAEL L. PARSON,
UNDERSLAB VAPOR RETARDER. SEE SPEC SECTION 033099 "UNDERSLAB VAPOR RETARDER" FOR MORE INFOMRATION. THICKENED SLAB. SEE STRUCTURAL DRAWINGS FOR MORE INFORMATION. CAST-IN-PLACE CONCRETE WALL PER STRUCTURAL. SEE STRUCTURAL DRAWINGS FOR MORE INFORMATION.	GOVERNOR
CAST-IN-PLACE CONCRETE FOOTING PER STRUCTURAL. SEE STRUCTURAL DRAWINGS FOR MORE INFORMATION.	STATE OF MISSING
CONCRETE UNIT MASONRY, 8"X8"X16", 2-CORE, WITH FULLY GROUTED CORES. SEE STRUCTURAL DRAWINGS/SPECIFICATIONS FOR MORE INFORMATION.	BRENT M.
ENGINEERED JOIST HANGER CONNECTOR. SEE STRUCTURAL FOR MORE INFORMATION.	NUMBER NO A-2000151419 &
2x4 FRAMING. SEE STRUCTURAL FOR MORE INFORMATION INCLUDING SPECIES, DETAILS, SPACING, AND MORE INFORMATION.	A A Community of Man
2X WOOD FRAMING - USE TREATED WOOD BLOCKING IN EXTERIOR OR WET APPLICATIONS. SEE STRUCTURAL FOR MORE INFORMATION INCLUDING SPECIES, DETAILS, SPACING, AND MORE INFORMATION.	BRENT M. STEVENS NUMBER MO A-2000151419 ARCHITECTORING
CONTINUOUS 2X RIM BOARD - USE TREATED WOOD BLOCKING IN EXTERIOR OR WET APPLICATIONS. SEE STRUCTURAL FOR MORE INFORMATION INCLUDING SIZE, SPECIES, DETAILS, SPACING, AND MORE INFORMATION.	
1/2" EXTERIOR GRADE PLYWOOD SHEATHING.	
5/8" EXTERIOR GRADE PLYWOOD SHEATHING.	
3/4" EXTERIOR GRADE PLYWOOD SHEATHING.	
YURT SURROUND PER YURT MANUFACTURE.	
SOUND BATT INSULATION, ENTIRE CAVITY, TYPICAL AT ALL INTERIOR WALLS, UNLESS NOTED OTHERWISE. SEE SPECIFICATIONS FOR MORE INFORMATION.	
2-1/2" RIGID INSULATION. SEE SPECIFICATIONS FOR MORE INFORMATION.	
FLUID-APPLIED WEATHER RESISTIVE BARRIER (WRB) SYSTEM. SEE SPECIFICATIONS FOR MORE INFORMATION. SYSTEM JOINT/CORNER TAPE TO BE APPLIED AT ALL PANEL JOINTS, SILLS/JAMBS/HEADS OF ALL OPENINGS, AT INSIDE/OUTSIDE CORNERS, PENETRATIONS, AND AT ALL MANUFACTURER REQUIRED LOCATIONS; SYSTEM TO WRAP OVER ANY PARAPET; AND SYSTEM TO PROVIDE A CONTINUOUS BUILDING ENVELOPE.	
FIBER-REINFORCED CEMENT HORIZONTAL SIDING (PROFILE 1) WITH INTEGRAL COLOR. SEE SPECIFICATIONS FOR MORE INFORMATION. SEE ELEVATION SHEETS FOR LOCATION OF TRIM/JOINTS.	d no
FIBER-REINFORCED CEMENT TRIM BOARD, 4" EXPOSED FACE. SEE SPECIFICATIONS FOR MORE INFORMATION.	
PREFORMED, PREFINISHED ALUMINUM FLASHING. SEE SPECIFICATIONS AND DETAILS FOR MORE INFORMATION. ALL EXPOSED EDGES TO BE HEMMED.	O) - 0
PREFORMED, PREFINISHED BASE + COUNTER FLASHING WITH INTEGRAL DRIPS TO COVER CONTINUOUS CLEAT. PROVIDE MINIMUM INDICATED VERTICAL LEG. ALL EXPOSED EDGES TO BE HEMMED. SEE DETAIL SHEETS (ALL DISCIPLINES) FOR MORE INFORMATION.	hdesign architecture + design Springfield, MO 65810 417
FIBROUS EXPANSION JOINT FILLER.	hd architec
WOOD DOOR/FRAME ASSEMBLY. SEE DETAILS, SPECIFICATIONS, AND A3 SERIES SHEETS FOR MORE INFORMATION. THRESHOLDS, SEE DOOR HARDWARE SCHEDULE, SPECIFICATIONS, DETAILS	_
THRESHOLDS. SEE DOOR HARDWARE SCHEDULE, SPECIFICATIONS, DETAILS, AND A3 SERIES SHEETS FOR MORE INFORMATION. FLOORING	S National Avenue
HARDWOOD FLOORING. SEE FINISH PLANS, FINISH SCHEDULE, DETAILS, AND/OR SPECIFICATIONS FOR MORE INFORMATION.	Nationa
VINYL WALLCOVERING. SEE FINISH PLANS, FINISH SCHEDULE, DETAILS, AND/OR SPECIFICATIONS FOR MORE INFORMATION.	2039 S
3/8" KNOTTY PINE BEAD BOARD. FINISH GRADE AND EARTHWORK BACKFILL (SLOPE FINISH GRADE MIN. 1/8"	
PER 1'-0" AWAY FROM BUILDING FOR A MIN. 5'-0"). SEE CIVIL, STRUCTURAL, AND ARCHITECTURAL DETAIL SHEETS AND SPECIFICATIONS FOR MORE INFORMATION.	OFFICE OF ADMINISTRATION DIVISION OF FACILITIES
GRAVEL. SEE CIVIL, STRUCTURAL, AND ARCHITECTURAL DETAIL SHEETS AND SPECIFICATIONS FOR MORE INFORMATION.	MANAGEMENT,
COMPACTED GRAVEL SUB-BASE. SEE CIVIL, STRUCTURAL, AND ARCHITECTURAL DETAIL SHEETS AND SPECIFICATIONS FOR MORE INFORMATION.	DESIGN AND CONSTRUCTION
	DEPARTMENT OF
	NATURAL RESOURCES
	MICCOUDICE ATERADIC

DEPARTMENT OF NATURAL RESOURCES MISSOURI STATE PARKS

STATE OF MISSOURI

TABLE ROCK STATE PARK REPLACE 5 BASIC SITES WITH 5 PREMIUM YURTS

TABLE ROCK STATE PARK CAMPGROUND #2 5272 STATE HWY 165 BRANSON, MISSOURI 65616

PROJECT # X2215-01 **ASSET** # 7815603018

REVISION:	
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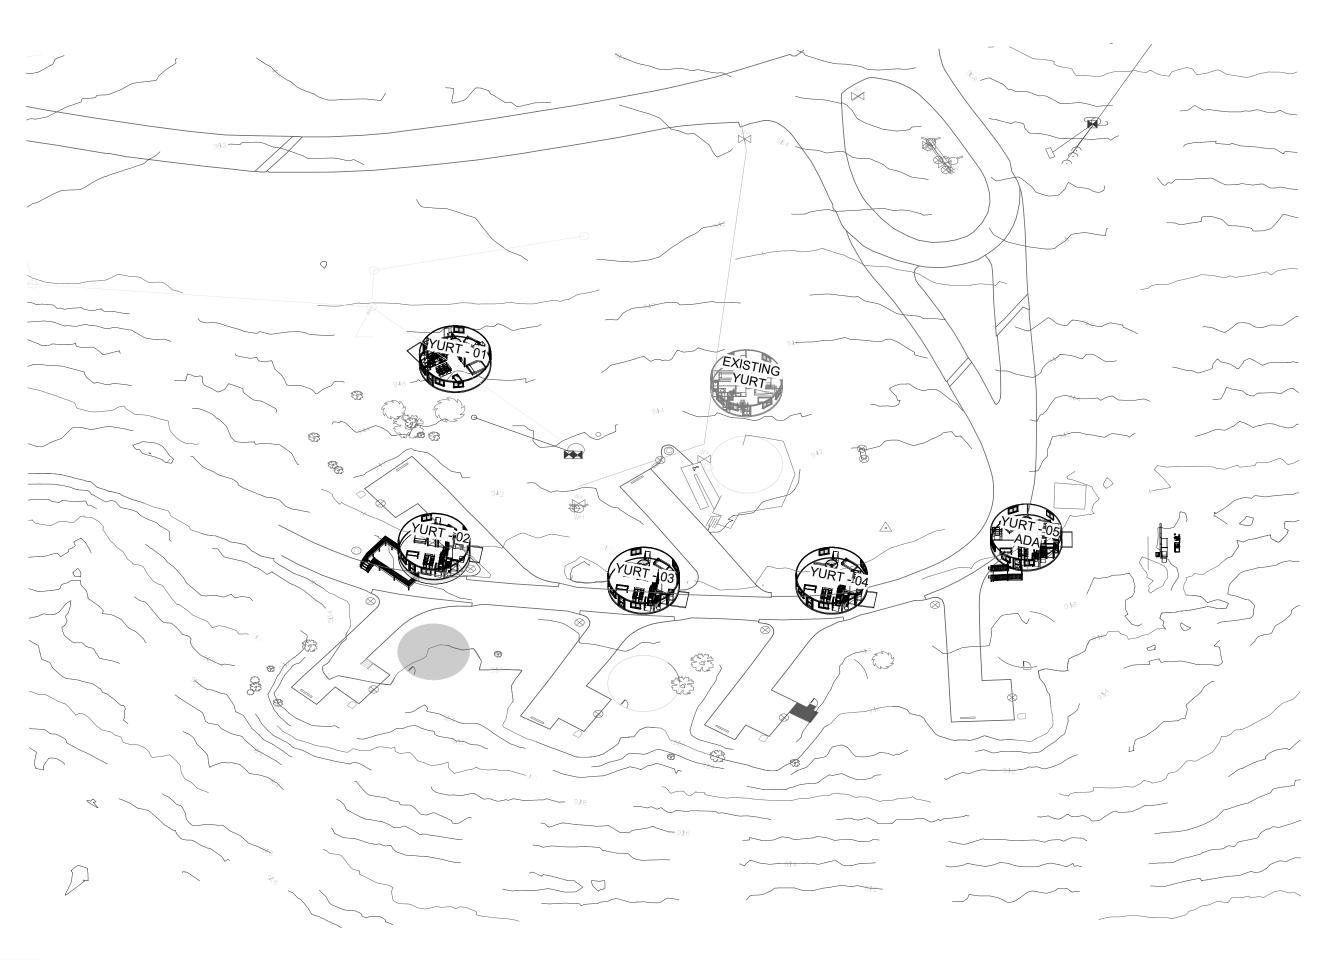
ISSUE DATE: JANUARY 17, 2023

CAD DWG FILE: X221601 A-502
DRAWN BY: HDG
CHECKED BY: HDG
DESIGNED BY: HDG


SHEET TITLE: DETAILS

SHEET NUMBER:

SHEET <u>26</u> OF <u>32</u> 1/17/2023 9:09:09 AM



SOLAR ORIENTATION DIAGRAM

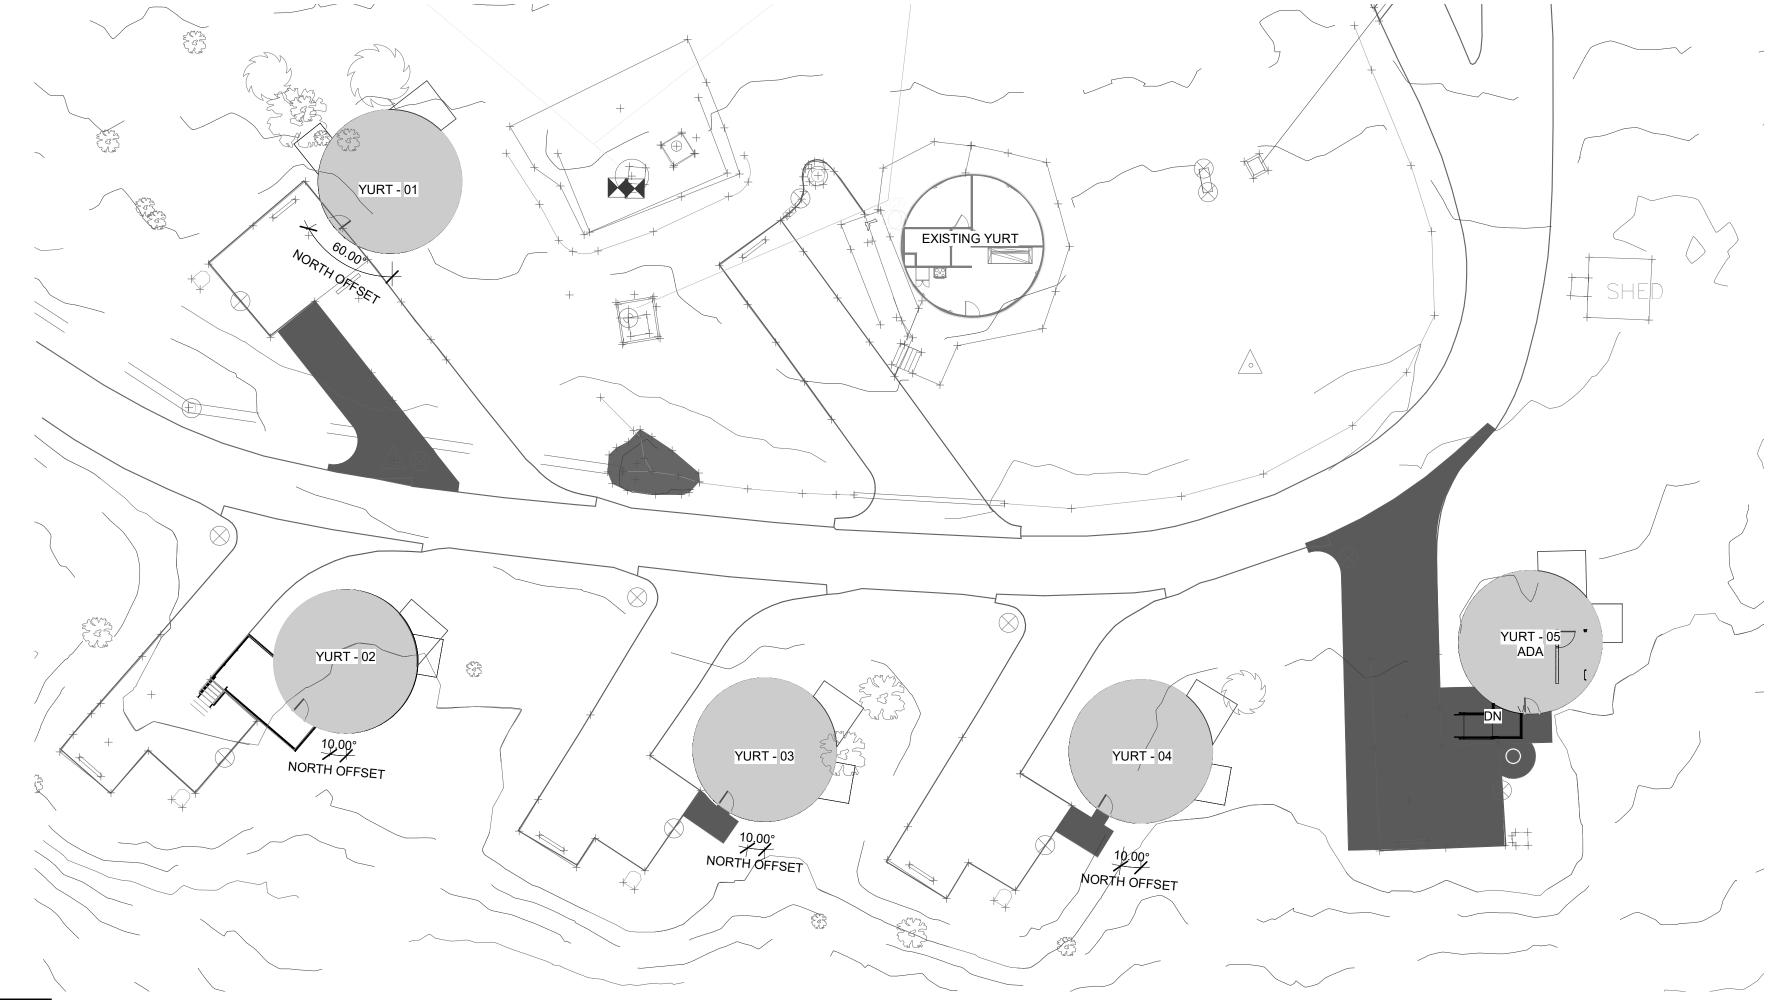

ARCH SITE PLAN

UNIT MIX QUANTITY GROSS S.F. YURT - 01 YURT - 02 (ALTERNATE) YURT - 03 YURT - 04 YURT - 05 SLAB ON GRADE RAISED PLATFORM SLAB ON GRADE SLAB ON GRADE SLAB ON GRADE - ADA 707 707 707 707 707

TOTAL GROSS S.F. 3,535 TOTAL NET S.F. 2,735

STATE OF MISSOURI MICHAEL L. PARSON, **GOVERNOR**



OFFICE OF ADMINISTRATION DIVISION OF FACILITIES MANAGEMENT, DESIGN AND CONSTRUCTION

DEPARTMENT OF NATURAL RESOURCES MISSOURI STATE PARKS

TABLE ROCK STATE PARK REPLACE 5 BASIC SITES WITH 5 PREMIUM YURTS

TABLE ROCK STATE PARK CAMPGROUND #2 5272 STATE HWY 165 BRANSON, MISSOURI 65616

PROJECT # X2215-01 **ASSET** # 7815603018

REVISION: DATE: REVISION: DATE: REVISION: DATE:

ISSUE DATE: JANUARY 17, 2023

CAD DWG FILE: X221601 AS-101
DRAWN BY: HDG
CHECKED BY: HDG
DESIGNED BY: HDG

SHEET TITLE: ARCH SITE PLAN

SHEET NUMBER:

AS-101

SHEET <u>27</u> OF <u>32</u> 1/17/2023 9:09:11 AM

ELECTRICAL SYMBOLS: EXIT LIGHT; WALL MOUNTED / CEILING MOUNTED FLUORESCENT LIGHT FIXTURE UNSWITCHED "NIGHT LIGHT" FIXTURE EMERGENCY LIGHTING FIXTURE RECESSED CAN LIGHT FIXTURE WALL-MOUNT LIGHT FIXTURE 20AMP, SINGLE POLE, 120/277V SWITCH 20AMP, THREE-WAY, 120/277V SWITCH 20AMP, FOUR-WAY, 120/277V SWITCH 20AMP, DOUBLE POLE, 120/277V SWITCH 20AMP, SINGLE POLE, 120/277V SWITCH WITH LOAD ON, LIGHT ON PILOT LIGHT 20AMP, SINGLE POLE, 120/277V, KEY OPERATED SWITCH 20AMP, MOMENTARY CONTACT, 120/277V SWITCH CEILING-MOUNTED OCCUPANCY SENSOR WALLBOX-MOUNTED OCCUPANCY SENSOR INTERCOM STATION. COORDINATE ROUGH-IN REQUIREMENTS WITH SYSTEM DOOR ACTUATOR PUSHBUTTON. COORDINATE ROUGH-IN REQUIREMENTS WITH SYSTEM CARD READER/ACCESS CONTROL DEVICE. COORDINATE ROUGH—IN REQUIREMENTS WITH SECURITY CAMERA. PROVIDE DOUBLE-GANG BOX. SINGLE-GANG PLASTER RING. AND 0.75" CONDUIT TO ACCESSIBLE CEILING SPACE OR ELECTRICAL/IDF ROOM. SIMPLEX RECEPTACLE; 2P, 3W, 20A, 125V SIMPLEX RECEPTACLE; NEMA CONFIGURATION AS INDICATED DUPLEX RECEPTACLE: 2P. 3W. 20A. 125V DUPLEX RECEPTACLE; MOUNTED @ 42" ABOVE FINISHED FLOOR DUPLEX RECEPTACLE; INSTALLED FLUSH WITH CEILING DUPLEX RECEPTACLE; MOUNTED 6" ABOVE COUNTERTOP BACKSPLASH DUPLEX RECEPTACLE W/ GROUND FAULT INTERRUPTER DUPLEX RECEPTACLE FOR TV; COORDINATE MOUNTING HEIGHT WITH ARCHITECT AND TV SUPPLIER/INSTALLER ₩ DUPLEX RECEPTACLE; SWITCHED, BOTTOM HALF ONLY **∓** TR DUPLEX RECEPTACLE; TAMPER RESISTANT DUPLEX RECEPTACLE W/ USB CHARGING PORT. PROVIDE RECEPTACLE EQUAL TO DUPLEX RECEPTACLE; WEATHERPROOF DOUBLE DUPLEX RECEPTACLE WITH COMMON FACEPLATE RECEPTACLE MOUNTED IN FLUSH FLOOR BOX. REFER TO SPECIFICATIONS JUNCTION BOX - CEILING MOUNTED JUNCTION BOX — WALL MOUNTED LP1 LIGHTING & POWER PANELBOARD ELECTRICAL EQUIPMENT. REFER TO SCHEDULE FOR TAGGED EQUIPMENT US1 DISCONNECT SWITCH ------ CONDUIT CONCEALED IN CEILING OR WALL ---- CONDUIT CONCEALED IN FLOOR SLAB - - CONDUIT ROUTED EXPOSED AT STRUCTURE

* TELECOMMUNICATIONS OUTLET INSTALLED IN FLUSH FLOOR BOX * THESE DEVICE REQUIRE 4" SQUARE JUNCTION BOX WITH 1" CONDUIT TO NEAREST ACCESSIBLE CEILING SPACE (0.75" CONDUIT FROM GUESTROOM DEVICES). WHERE APPLICABLE, INSTALL CONDUIT TO NEAR CABLE TRAY. PROVIDE PULL STRING AND INSULATING BUSHING UNLESS INDICATED OTHERWISE IN PLANS

VOLUME CONTROL STATION - PROVIDE SINGLE-GANG JUNCTION BOX WITH 0.75" CONDUIT

* CABLE TELEVISION OR MATY OUTLET. COORDINATE MOUNTING HEIGHT WITH ARCHITECT

#12 CONDUCTORS, TICK MARKS INDICATE QUANTITY

→ P1-1 HOME RUN WITH PANEL AND CIRCUIT DESIGNATION

TO ACCESSIBLE CEILING SPACE

* TELECOMMUNICATIONS OUTLET

AND TV SUPPLIER/INSTALLER

ELECTRICAL GENERAL NOTES:

CJD LLC, BEING THE AUTHOR OF THESE CONSTRUCTION DOCUMENTS RESERVES THE RIGHT OF FINAL INTERPRETATION AS TO THEIR INTENT AND MEANING. ANY ADDITIONAL WORK OR COSTS RESULTING FROM THE CONTRACTORS OWN INTERPRETATION AS TO THE INTENT OR MEANING WITHOUT CONSULTATION WITH CJD LLC SHALL BE THE RESPONSIBILITY OF THE CONTRACTOR AT NO COST TO OWNER OR A/E.

THE INTENT OF THE WORK INDICATED ON THESE CONSTRUCTION DOCUMENTS IS TO PROVIDE A FULLY FUNCTIONING SYSTEM IN COMPLETE WORKING ORDER. IT SHALL BE THE RESPONSIBILITY OF THE CONTACTOR AND THE CONTRACTORS SUPPLIERS TO INCLUDE ALL ACCESSORIES, COMPONENTS, PARTS, ETC. THAT MAY IOT BE INDICATED ON THESE CONSTRUCTION DOCUMENTS TO PROVIDE SYSTEMS AND EQUIPMENT THAT

3. ALL ELECTRICAL WORK SHALL BE PERFORMED BY LICENSED ELECTRICIANS AND SHALL COMPLY WITH THE 1017 NATIONAL ELECTRICAL CODE AND ALL APPLICABLE LOCAL CODES AS ADOPTED BY THE CITY OF

4. THE CONTRACTOR SHALL INCLUDE ALL PERMIT AND INSPECTION FEES IN BID.

5. PLANS ARE DIAGRAMMATIC AND SHALL NOT BE SCALED. REFER TO CIVIL, STRUCTURAL AND ARCHITECTURAL DRAWINGS AND EXISTING CONDITIONS FOR DIMENSIONS. FIELD VERIFY DIMENSIONS.

6. THE CONTRACTOR SHALL VERIFY ALL EXISTING CONSTRUCTION PRIOR TO SUBMITTING HIS BID. NO EXTRAS WILL BE PAID DUE TO UNANTICIPATED EXISTING CONDITIONS.

PIPING, DUCTWORK, ETC. FINAL RESULT SHALL BE EQUIVALENT TO THAT INDICATED ON DRAWINGS.

8. COOPERATE CLOSELY WITH ALL OTHER TRADES TO EXPEDITE CONSTRUCTION AND AVOID INTERFERENCES AND CONFLICTS. BEFORE ANY PIPING, DUCTWORK, CONDUIT, ETC. IS INSTALLED, IT SHALL BE COORDINATED

9. MAINTAIN ALL CLEARANCES REQUIRED BY MECHANICAL AND ELECTRICAL EQUIPMENT. COORDINATE WITH PLUMBING AND HVAC CONTRACTORS TO MAINTAIN ALL CLEARANCES REQUIRED FOR EQUIPMENT. DO NOT

ROUTE PIPING, DUCTWORK, ETC. ABOVE ELECTRICAL PANELS. 10. THE CONTRACTOR SHALL SCHEDULE AND EXECUTE THE WORK WITH REGARD TO THE OWNER'S USE OF THE

11. THE CONTRACTOR SHALL BE RESPONSIBLE FOR ENSURING COSTS TO CUT, PATCH AND REPAIR EXISTING FLOOR AND CEILING CONSTRUCTION AS REQUIRED TO INSTALL NEW PLUMBING FIXTURES, PIPING, ETC.

12. THE CONTRACTOR SHALL SUBMIT A MINIMUM OF SIX (6) COPIES ON ALL FIXTURES AND EQUIPMENT FURNISHED UNDER THIS CONTRACT.

13. IF CONTRACTOR WISHES TO INCORPORATE PRODUCTS OTHER THAN THOSE NAMED IN SPECIFICATIONS IN HIS BID OR PRODUCTS BY MANUFACTURERS OTHER THAN THOSE LISTED AS APPROVED MANUFACTURERS, THE CONTRACTOR SHALL SUBMIT A WRITTEN REQUEST FOR REVIEW AND APPROVAL OF PROPOSED SUBSTITUTIONS TO COLVIN JONES DAVIS LLC NOT LESS THAN FIVE WORKING DAYS PRIOR TO BID DATE. APPROVAL OR ACCEPTANCE OF PROPOSED SUBSTITUTION OF MANUFACTURERS OR ITEMS IS FOR THE PURPOSES OF BIDDING ONLY AND DOES NOT RELIEVE THE PROPOSED SUBSTITUTION FROM THE SUBMITTAL/SHOP DRAWING REVIEW AND DOES NOT CONSTITUTE PRIOR APPROVAL OF PROPOSED SUBSTITUTIONS

14. THE CONTRACTOR SHALL BE RESPONSIBLE FOR THE COSTS OF LARGER WIRING, CONDUIT, ENCLOSURES, CONTROL AND OVERCURRENT PROTECTIVE DEVICES, ETC. RESULTING FROM SUBSTITUTION OF EQUIPMENT OTHER THAN THAT WHICH WAS THE BASIS OF DESIGN AT NO COST TO OWNER OR A/E.

15. THE CONTRACTOR SHALL GUARANTEE ALL EQUIPMENT, ACCESSORIES, AND MATERIAL FURNISHED BY HIM FOR A PERIOD OF ONE YEAR FROM FINAL ACCEPTANCE AGAINST ALL DEFECTS.

16. THE CONTRACTOR SHALL BE RESPONSIBLE FOR ENSURING COSTS TO CUT, PATCH AND REPAIR EXISTING WALL, ROOF AND CEILING CONSTRUCTION AS REQUIRED TO INSTALL NEW DUCTWORK, GRILLES, DIFFUSERS, ETC. ARE INCLUDED IN THE BID PRICE.

17. COORDINATE LIGHTING FIXTURE LOCATIONS WITH REFLECTED CEILING PLANS.

18. COORDINATE INFORMATION OUTLET, RECEPTACLE, AND OTHER DEVICE LOCATIONS WITH OWNER AND WITH

19. INFORMATION OUTLET (DATA AND TELEPHONE) DEVICES, WALL PLATES, AND ASSOCIATED PLENUM RATED WIRING SHALL BE SUPPLIED AND INSTALLED BY OTHERS UNDER A SEPARATE CONTRACT WITH THE OWNER.

LIGHT SWITCHES SHALL BE HUBBELL 1220 SERIES, 20-AMP, 120/277-VOLT, IN COLOR SELECTED BY THE

DUPLEX RECEPTACLES SHALL BE HUBBELL 5300 SERIES, 20A, 125V, NEMA CONFIGURATION 5-20R, IN COLOR SELECTED BY THE ARCHITECT/INTERIOR DESIGNER.

ELECTRICAL DEVICE WALL PLATES SHALL BE HIGH IMPACT NYLON PLASTIC IN COLOR AS SELECTED BY THE

4. EQUIVALENT WIRING DEVICES BY BRYANT, COOPER, HUBBELL AND LEVITON.

5. EQUIVALENT PANELBOARDS, LIGHTING CONTACTORS AND DISCONNECT SWITCHES BY CUTLER HAMMER, GENERAL ELECTRIC, AND SQUARE D.

ALL WIRING SHALL BE INSTALLED IN EMT CONDUIT AND SHALL BE CONCEALED UNLESS OTHERWISE NOTED. PVC CONDUIT WILL BE ALLOWED BELOW SLAB AND IN GRASSY AREAS. ALL TRANSITIONS FROM PVC TO STEEL CONDUIT SHALL BE MADE BELOW GRADE. MINIMUM CONDUIT SIZE FOR LIGHTING AND POWER BRANCH CIRCUITS ABOVE GRADE SHALL BE 1/2". MINIMUM CONDUIT SIZE FOR LIGHTING AND POWER BRANCH CIRCUITS BELOW GRADE SHALL BE 3/4". CONTRACTOR SHALL HAVE THE OPTION TO USE METALLIC CLAD

INSTALL BRANCH CIRCUIT WIRING, TELE/DATA, ETC. IN WIREMOLD SERIES 2000 SURFACE METAL RACEWAY WHERE EXISTING CONDITIONS NECESSITATE ITS INSTALLATION TO BE SURFACE MOUNTED AND ONLY WHEN APPROVED BY ARCHITECT/ENGINEER. EQUIVALENT BY HUBBELL. PAINT SURFACE MOUNTED RACEWAY AND

3. MINIMUM CONDUIT SIZE FOR INFORMATION OUTLETS SHALL BE 3/4". CONDUIT STUBS SHALL BE TERMINATED

4. FEEDER AND BRANCH CIRCUIT WIRING SHALL BE COPPER, 600V WITH THHN/THWN INSULATION. BRANCH CIRCUIT WIRING SHALL BE #12 AWG MINIMUM. HOMERUNS FOR BRANCH CIRCUITS OVER 75 FEET LONG SHALL BE #10 AWG; OVER 100 FEET LONG, #8 AWG UNLESS INDICATED OTHERWISE.

5. ALL LIGHTING AND POWER CIRCUITS SHALL HAVE A GROUNDING CONDUCTOR

6. ALL RECEPTACLES, TELECOMMUNICATIONS OUTLETS, AND TELEVISION OUTLETS SHALL BE INSTALLED AT 18" AFF TO CENTER UNLESS NOTED OTHERWISE. ALL SWITCHES SHALL BE INSTALLED AT 48" AFF TO CENTER

PROVIDE TYPED CIRCUIT DIRECTORIES FOR ALL PANELBOARDS. DIRECTORY INFORMATION SHALL INCLUDE CIRCUIT NUMBER AND EQUIPMENT SERVEL

8 FLECTRICAL CONTRACTOR SHALL PROVIDE ROLIGH—IN FOR THERMOSTATS AND SENSOR PROVIDE SINGLE-GANG BOX WITH 0.75" CONDUIT TO ABOVE ACCESSIBLE CEILING OR TO ASSOCIATED FOUIPMENT.


THERMOSTATS, SENSORS, AND WIRING SHALL BE PROVIDED BY MECHANICAL CONTRACTOR.


9. PROVIDE SLEEVES AT CONDUIT PENETRATIONS OF EXTERIOR WALLS. SEAL PENETRATIONS WEATHERTIGHT.

10. REFER TO ARCHITECTURAL DRAWINGS FOR TYPICAL PENETRATION DETAILS.

11. CONTRACTOR SHALL MAKE ALL FINAL CONNECTIONS TO KITCHEN EQUIPMENT. PROVIDE ADAPTERS, FITTINGS, CORD/PLUG CONNECTIONS, ETC. FOR ALL EQUIPMENT AS REQUIRED. COORDINATE SPECIFIC REQUIREMENTS WITH EQUIPMENT SUPPLIERS. REFER TO EQUIPMENT TEMPLATES / DRAWINGS FOR ADDITIONAL INFORMATION.

PLUMBING SYMBOLS:

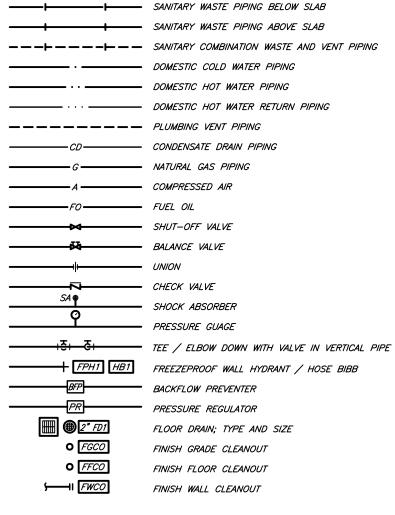

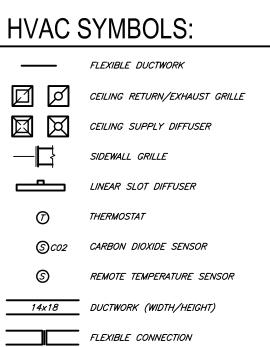

RECTANGULAR TO ROUND TAKE—OFF WITH DAMPER

DIFFUSER TYPE, SIZE, CFM

MECHANICAL GENERAL NOTES:

1. CJD, LLC, BEING THE AUTHOR OF THESE CONSTRUCTION DOCUMENTS RESERVES THE RIGHT OF FINAL INTERPRETATION AS TO THEIR INTENT AND MEANING. ANY ADDITIONAL WORK OR COSTS RESULTING FROM THE CONTRACTORS OWN INTERPRETATION AS TO THE INTENT OR MEANING WITHOUT CONSULTATION WITH CJD LLC SHALL BE THE RESPONSIBILITY OF THE CONTRACTOR AT NO COST TO OWNER OR A/E.

THE INTENT OF THE WORK INDICATED ON THESE CONSTRUCTION DOCUMENTS IS TO PROVIDE A FULLY FUNCTIONING SYSTEM IN COMPLETE WORKING ORDER. IT SHALL BE THE RESPONSIBILITY OF THE CONTACTOR AND THE CONTRACTORS SUPPLIERS TO INCLUDE ALL ACCESSORIES, COMPONENTS, PARTS, ETC. THAT MAY NOT BE INDICATED ON THESE CONSTRUCTION DOCUMENTS TO PROVIDE SYSTEMS AND EQUIPMENT THAT OPERATE SATISFACTORILY AS DESIGNED AND INTERDED.

3. ALL MECHANICAL WORK SHALL BE PERFORMED BY LICENSED CONTRACTORS IN ACCORDANCE WITH THE 2018 INTERNATIONAL BUILDING, PLUMBING, FUEL GAS, AND MECHANICAL CODES AS ADOPTED BY CITY OF SPRINGFIELD, WISCOLDS

4. THE CONTRACTOR SHALL INCLUDE ALL PERMIT AND INSPECTION FEES IN BID.

PLANS ARE DIAGRAMMATIC AND SHALL NOT BE SCALED. REFER TO CIVIL, STRUCTURAL AND ARCHITECTURAL DRAWINGS AND EXISTING CONDITIONS FOR DIMENSIONS. FIELD VERIFY DIMENSIONS.

6. THE CONTRACTOR SHALL VERIFY ALL EXISTING CONSTRUCTION PRIOR TO SUBMITTING HIS BID. NO EXTRAS WILL BE PAID DUE TO UNANTICIPATED EXISTING CONDITIONS.

PIPING AND DUCTWORK LAYOUTS ARE DIAGRAMMATIC. FIELD COORDINATE EXACT LOCATIONS AND ROUTINGS WITH STRUCTURE, PIPING, DUCTWORK, ETC. FINAL RESULT SHALL BE EQUIVALENT TO THAT INDICATED ON DRAWINGS. COOPERATE CLOSELY WITH ALL OTHER TRADES TO EXPEDITE CONSTRUCTION AND AVOID INTERFERENCES AND CONFLICTS. BEFORE ANY PIPING, DUCTWORK, CONDUIT, ETC. IS INSTALLED, IT SHALL BE COORDINATED CAREFULLY

9. MAINTAIN ALL CLEARANCES REQUIRED BY MECHANICAL AND ELECTRICAL EQUIPMENT. COORDINATE WITH PLUMBING AND HVAC CONTRACTORS TO MAINTAIN ALL CLEARANCES REQUIRED FOR EQUIPMENT. DO NOT ROUTE PIPING, DUCTWORK,

10. THE CONTRACTOR SHALL SCHEDULE AND EXECUTE THE WORK WITH REGARD TO THE OWNER'S USE OF THE BUILDING.

11. THE CONTRACTOR SHALL BE RESPONSIBLE FOR ENSURING COSTS TO CUT, PATCH AND REPAIR EXISTING WALL, FLOOR AND CEILING CONSTRUCTION AS REQUIRED TO INSTALL NEW PLUMBING FIXTURES, PIPING, ETC. ARE INCLUDED IN THE

12. THE CONTRACTOR SHALL SUBMIT A MINIMUM OF SIX (6) COPIES ON ALL FIXTURES AND EQUIPMENT FURNISHED UNDER THIS CONTRACT.

13. IF CONTRACTOR WISHES TO INCORPORATE PRODUCTS OTHER THAN THOSE NAMED IN SPECIFICATIONS IN HIS BID OR PRODUCTS BY MANUFACTURERS OTHER THAN THOSE LISTED AS APPROVED MANUFACTURERS, THE CONTRACTOR SHALL SUBMIT A WRITTEN REQUEST FOR REVIEW AND APPROVAL OF PROPOSED SUBSTITUTIONS TO COLVIN JONES DAVIS LLC NOT LESS THAN FIVE WORKING DAYS PRIOR TO BID DATE. APPROVAL OR ACCEPTANCE OF PROPOSED SUBSTITUTION OF MANUFACTURERS OR ITEMS IS FOR THE PURPOSES OF BIDDING ONLY AND DOES NOT RELIEVE THE PROPOSED SUBSTITUTION FROM THE SUBMITTAL/SHOP DRAWING REVIEW AND DOES NOT CONSTITUTE PRIOR APPROVAL OF

14. THE CONTRACTOR SHALL BE RESPONSIBLE FOR THE COSTS OF LARGER WIRING, CONDUIT, ENCLOSURES, CONTROL AND OVERCURRENT PROTECTIVE DEVICES, ETC. RESULTING FROM SUBSTITUTION OF EQUIPMENT OTHER THAN THAT WHICH WAS THE BASIS OF DESIGN AT NO COST TO OWNER OR A/E.

15. THE CONTRACTOR SHALL GUARANTEE ALL EQUIPMENT, ACCESSORIES, AND MATERIAL FURNISHED BY HIM FOR A PERIOD OF ONE YEAR FROM FINAL ACCEPTANCE AGAINST ALL DEFECTS.

THE CONTRACTOR SHALL BE RESPONSIBLE FOR ENSURING COSTS TO CUT, PATCH AND REPAIR EXISTING WALL, ROOF CEILING CONSTRUCTION AS REQUIRED TO INSTALL NEW DUCTWORK, GRILLES, DIFFUSERS, ETC. ARE INCLUDED IN

17. THE CONTRACTOR SHALL OBTAIN THE SERVICES OF AN INDEPENDENT FIRM CERTIFIED WITH ASSOCIATED AIR BALANCING COUNCIL OR NATIONAL ENVIRONMENTAL BALANCING BUREAU TO PERFORM THE HVAC SYSTEM TESTING AND BALANCING IN ACCORDANCE WITH AABC OR NEBB NATIONAL STANDARDS.

1. ALL SHUTOFF VALVES ON DOMESTIC WATER SHALL BE BRONZE FULL PORT BALL VALVE 600 PSI—WOG WITH PACKING NUT, TEFLON SEATS, BRONZE BALL, SILICON BRONZE STEM INSULATED HANDLE, AND SCREWED OR SOLDER ENDS.

ALL DUCTWORK SHALL BE FABRICATED OF G90 GALVANIZED STEEL AND INSTALLED IN ACCORDANCE WITH SMACNA STANDARDS, MANUAL 15D. ALL SUPPLY AIR DUCT PRESSURE CLASSES SHALL BE THE SAME AS THE EXTERNAL STATIC PRESSURE (ESP) OF THE EQUIPMENT SUPPLYING THE DUCT. THE EQUIPMENT ESP SHALL BE THE PRESSURE CLASS FOR THE ENTIRE SUPPLY DUCT SYSTEM.

RECTANGULAR SUPPLY AIR DUCT: - 1.5" PRESSURE CLASS OR GREATER: GALVANIZED SHEET METAL WITH DUCTMATE OR EQUIVALENT FLANGE DUCT FITTINGS. RECTANGULAR SUPPLY AND RETURN AIR DUCT: — 1.5" PRESSURE CLASS OR LESS: GALVANIZED SHEET METAL. INSULATE SUPPLY DUCTWORK WITH 2", 1.0 LB DENSITY FIBERGLASS DUCT WRAP WITH FOIL—SCRIM—KRAFT FACING.

CONCEALED ROUND SUPPLY AIR DUCT — 3" PRESSURE CLASS OR LESS: GALVANIZED SNAP—LOCK PIPE WITH TRANSVERSE JOINTS AND CONNECTIONS SEALED. WRAP SUPPLY DUCT WITH 2", 1.0 LB DENSITY FIBERGLASS DUCT WRAP WITH FOIL—SCRIM—KRAFT FACING.

CONCEALED ROUND RETURN AND EXHAUST DUCT — 3" PRESSURE CLASS OR LESS: GALVANIZED SNAP-LOCK PIPE WITH TRANSVERSE JOINTS AND CONNECTIONS SEALED. FLEXIBLE DUCTWORK: FLEXMASTER USA TYPE 8B, UL 181 CLASS 1 RATED PRE-INSULATED ACOUSTICAL FLEX DUCT WITH MECHANICAL LOCK HELIX CONSTRUCTION, 25/50 FLAME SMOKE RATING, AND R-6.0 THERMAL BARRIER. RUNS OF FLEXIBLE DUCT SHALL NOT EXCEED 5 LINEAR FEET. FLEXIBLE DUCT SHALL NOT BE USED ON SYSTEMS WITH

PRESSURE CLASS GREATER THAN 1" ROUND TAKE-OFF FITTINGS FROM RECTANGULAR DUCTWORK SHALL BE MADE WITH BUCKLEY AIR PRODUCTS MODEL 3300 AND 3300D RECTANGULAR TO ROUND BOOT FITTINGS FITTINGS WITH INTEGRAL VOLUME DAMPERS AND

INSULATION STAND-OFFS WHERE INDICATED. EQUIVALENT BY AIR-TITE AND CROWN. 4. ALL SUPPLY AIR DIFFUSERS SHALL BE 4-WAY THROW UNLESS INDICATED OTHERWISE.

5. ALL DUCTWORK SHALL BE FABRICATED OF G90 GALVANIZED STEEL AND INSTALLED IN ACCORDANCE WITH SMACNA STANDARDS, MANUAL 15d. ALL SUPPLY AIR DUCT PRESSURE CLASSES SHALL BE THE SAME AS THE EXTERNAL STATIC PRESSURE (ESP) OF THE EQUIPMENT SUPPLYING THE DUCT. THE EQUIPMENT ESP SHALL BE THE PRESSURE CLASS FOR THE ENTIRE SUPPLY DUCT SYSTEM.

6. EQUIVALENT EXHAUST FANS BY COOK, GREENHECK, PENN AND ACME.

EQUIVALENT GRILLES, DIFFUSERS AND REGISTERS BY CARNES, KRUEGER, GREENHECK, NAILOR, PRICE, TITUS AND *TUTTLE & BAILEY*

8. EQUIVALENT VRF HVAC EQUIPMENT BY DAIKIN AND LG.

1. INSULATE ALL ABOVE GRADE DOMESTIC WATER AND CONDENSATE DRAIN PIPING WITH ARMACELL 1/2" THICK

INSULATE ALL ABOVE GRADE ROOF DRAIN PIPING WITH OWENS CORNING 1" THICK FIBERGLASS PIPE INSULATION WITH WHITE FIRE RETARDANT ASJ JACKET.

3. PROVIDE SIOUX CHIEF WATER HAMMER ARRESTERS ON ALL PLUMBING FIXTURES SIZED IN ACCORDANCE WITH PLUMBING AND DRAINAGE INSTITUTE STANDARD P.D.I. WH201. EQUIVALENT BY JONESPEC, J.R. SMITH, OR WADE.

5. INSTALL TRAPS AT WASTE CONNECTIONS TO ALL FLOOR DRAINS AND OTHER PLUMBING FIXTURES WITHOUT A TRAP INTEGRAL TO THE FIXTURE.

6. INSTALL WATER AND WASTE PIPING BELOW SLAB AND BELOW GRADE ON TOP OF A 6" BED OF PEA GRAVEL, WITH 6" PEA GRAVEL ON SIDES AND TOP OF PIPING.

7. PAINT ALL NATURAL GAS PIPING INSTALLED OUTDOORS WITH TWO COATS OF ALL WEATHER PAINT. COLOR SHALL BE SELECTED BY THE ARCHITECT.

8. INSTALL ALL ROOF PIPE, CONDUIT AND DUCTWORK SUPPORTS, CURBS AND PENETRATIONS IN ACCORDANCE WITH THE REQUIREMENTS OF THE ROOFING SYSTEM MANUFACTURER. 9. SUPPORT PIPING ON ROOF WITH PREMANUFACTURERED PIPING SUPPORT EQUIVALENT TO B-LINE C-SERIES. FIELD

FABRICATED SUPPORTS CONSISTING OF LUMBER, ETC. ARE NOT ACCEPTABLE 10. PROVIDE FACTORY FABRICATED PIPE CURB ASSEMBLIES FOR MULTIPLE CONDUIT AND PIPING PENETRATIONS THROUGH THE ROOF. PIPE CURB ASSEMBLIES SALL BE FACTORY FABRICATED, 8" TALL (MINIMUM) GALVANIZED STEEL ROOF CURBS WITH INTEGRAL BASE PLATE, 3 LB. DENSITY INSULATION, WOOD NAILER, ACRYLIC CLAD THERMOPLASTIC COVER, FASTENING SCREWS, AND GRADUATED STEP BOOTS WITH STAINLESS STEEL CLAMPS AS MANUFACTURED BY PATE, THYBAR OR APPROVED EQUIVALENT. PROVIDE PIPE SEAL ASSEMBLIES FOR INDIVIDUAL CONDUIT OR PIPE PENETRATIONS, ALL WORK SHALL BE IN ACCORDANCE WITH ROOFING MANUFACTURER'S RECOMMENDATIONS AND

11. PROVIDE SLEEVES AT PIPE PENETRATIONS OF EXTERIOR WALLS. SEAL PENETRATIONS WEATHERTIGHT.

12. REFER TO ARCHITECTURAL DRAWINGS FOR TYPICAL PENETRATION DETAILS.

13. CONTRACTOR SHALL MAKE ALL FINAL CONNECTIONS TO SPECIAL EQUIPMENT. PROVIDE ADAPTERS, FITTINGS, ETC. FOR ALL EQUIPMENT AS REQUIRED. COORDINATE SPECIFIC REQUIREMENTS WITH EQUIPMENT SUPPLIERS. REFER TO EQUIPMENT TEMPLATES / DRAWINGS FOR ADDITIONAL INFORMATION.

14. SEAL ALL DUCTWORK IN ACCORDANCE WITH THE LATEST SMACNA METAL AND FLEXIBLE DUCT CONSTRUCTION STANDARDS MANUAL. AT A MINIMUM, LOW STATIC PRESSURE DUCTS SHALL BE SEALED WITH WATER, SOLVENT OR SILCONE BASED SEALANT IN ACCORDANCE WITH SMACNA DUCT SEAL CLASS C. THE USE OF DUCT TAPE IS STRICTLY

15. THERMOSTATS, SENSORS, AND ASSOCIATED WIRING SHALL BE PROVIDED BY HVAC CONTRACTOR. ROUGH—IN SHALL BE PROVIDED BY ELECTRICAL CONTRACTOR. PROVIDE ALL THERMOSTATS WITH LABEL INDICATING AREA SERVED.

16. BRANCH DUCTS SHALL BE THE SAME SIZE AS DIFFUSER NECK UNLESS NOTED OTHERWISE. 17. PROVIDE HVAC EQUIPMENT WITH A NEW FILTERS DURING CONSTRUCTION AND UPON SUBSTANTIAL COMPLETION.

18. PROVIDE AERO-DYNE OR EQUIVALENT DOUBLE WALL TURNING VANES IN ALL RECTUANGULAR ELBOWS.

19. COORDINATE CEILING DIFFUSER AND GRILLE LOCATIONS WITH ARCHITECTURAL REFLECTED CEILING PLANS. 20. PROVIDE FLEXIBLE CONNECTION AND TRANSITION TO UNIT OPENING SIZES FOR ALL HVAC EQUIPMENT.



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OFFICE OF ADMINISTRATION DIVISION OF FACILITIES MANAGEMENT, **DESIGN AND CONSTRUCTION**

DEPARTMENT OF NATURAL RESOURCES MISSOURI STATE PARKS

TABLE ROCK STATE PARK REPLACE 5 BASIC SITES WITH 5 PREMIUM YURTS

TABLE ROCK STATE PARK CAMPGROUND #2 5272 STATE HWY 165

BRANSON, MISSOURI 65616 **PROJECT** # X2216-01

FACILITY # 7815603031


REVISION: DATE: REVISION: DATE REVISION: DATE: ISSUE DATE: JANUARY 17, 2023

CAD DWG FILE: X2216-01 E-101 DRAWN BY: AKD CHECKED BY: AKD DESIGNED BY: AKD

SHEET TITLE: MECH & ELEC SYMBOLS &

GENERAL NOTES

SHEET NUMBER:

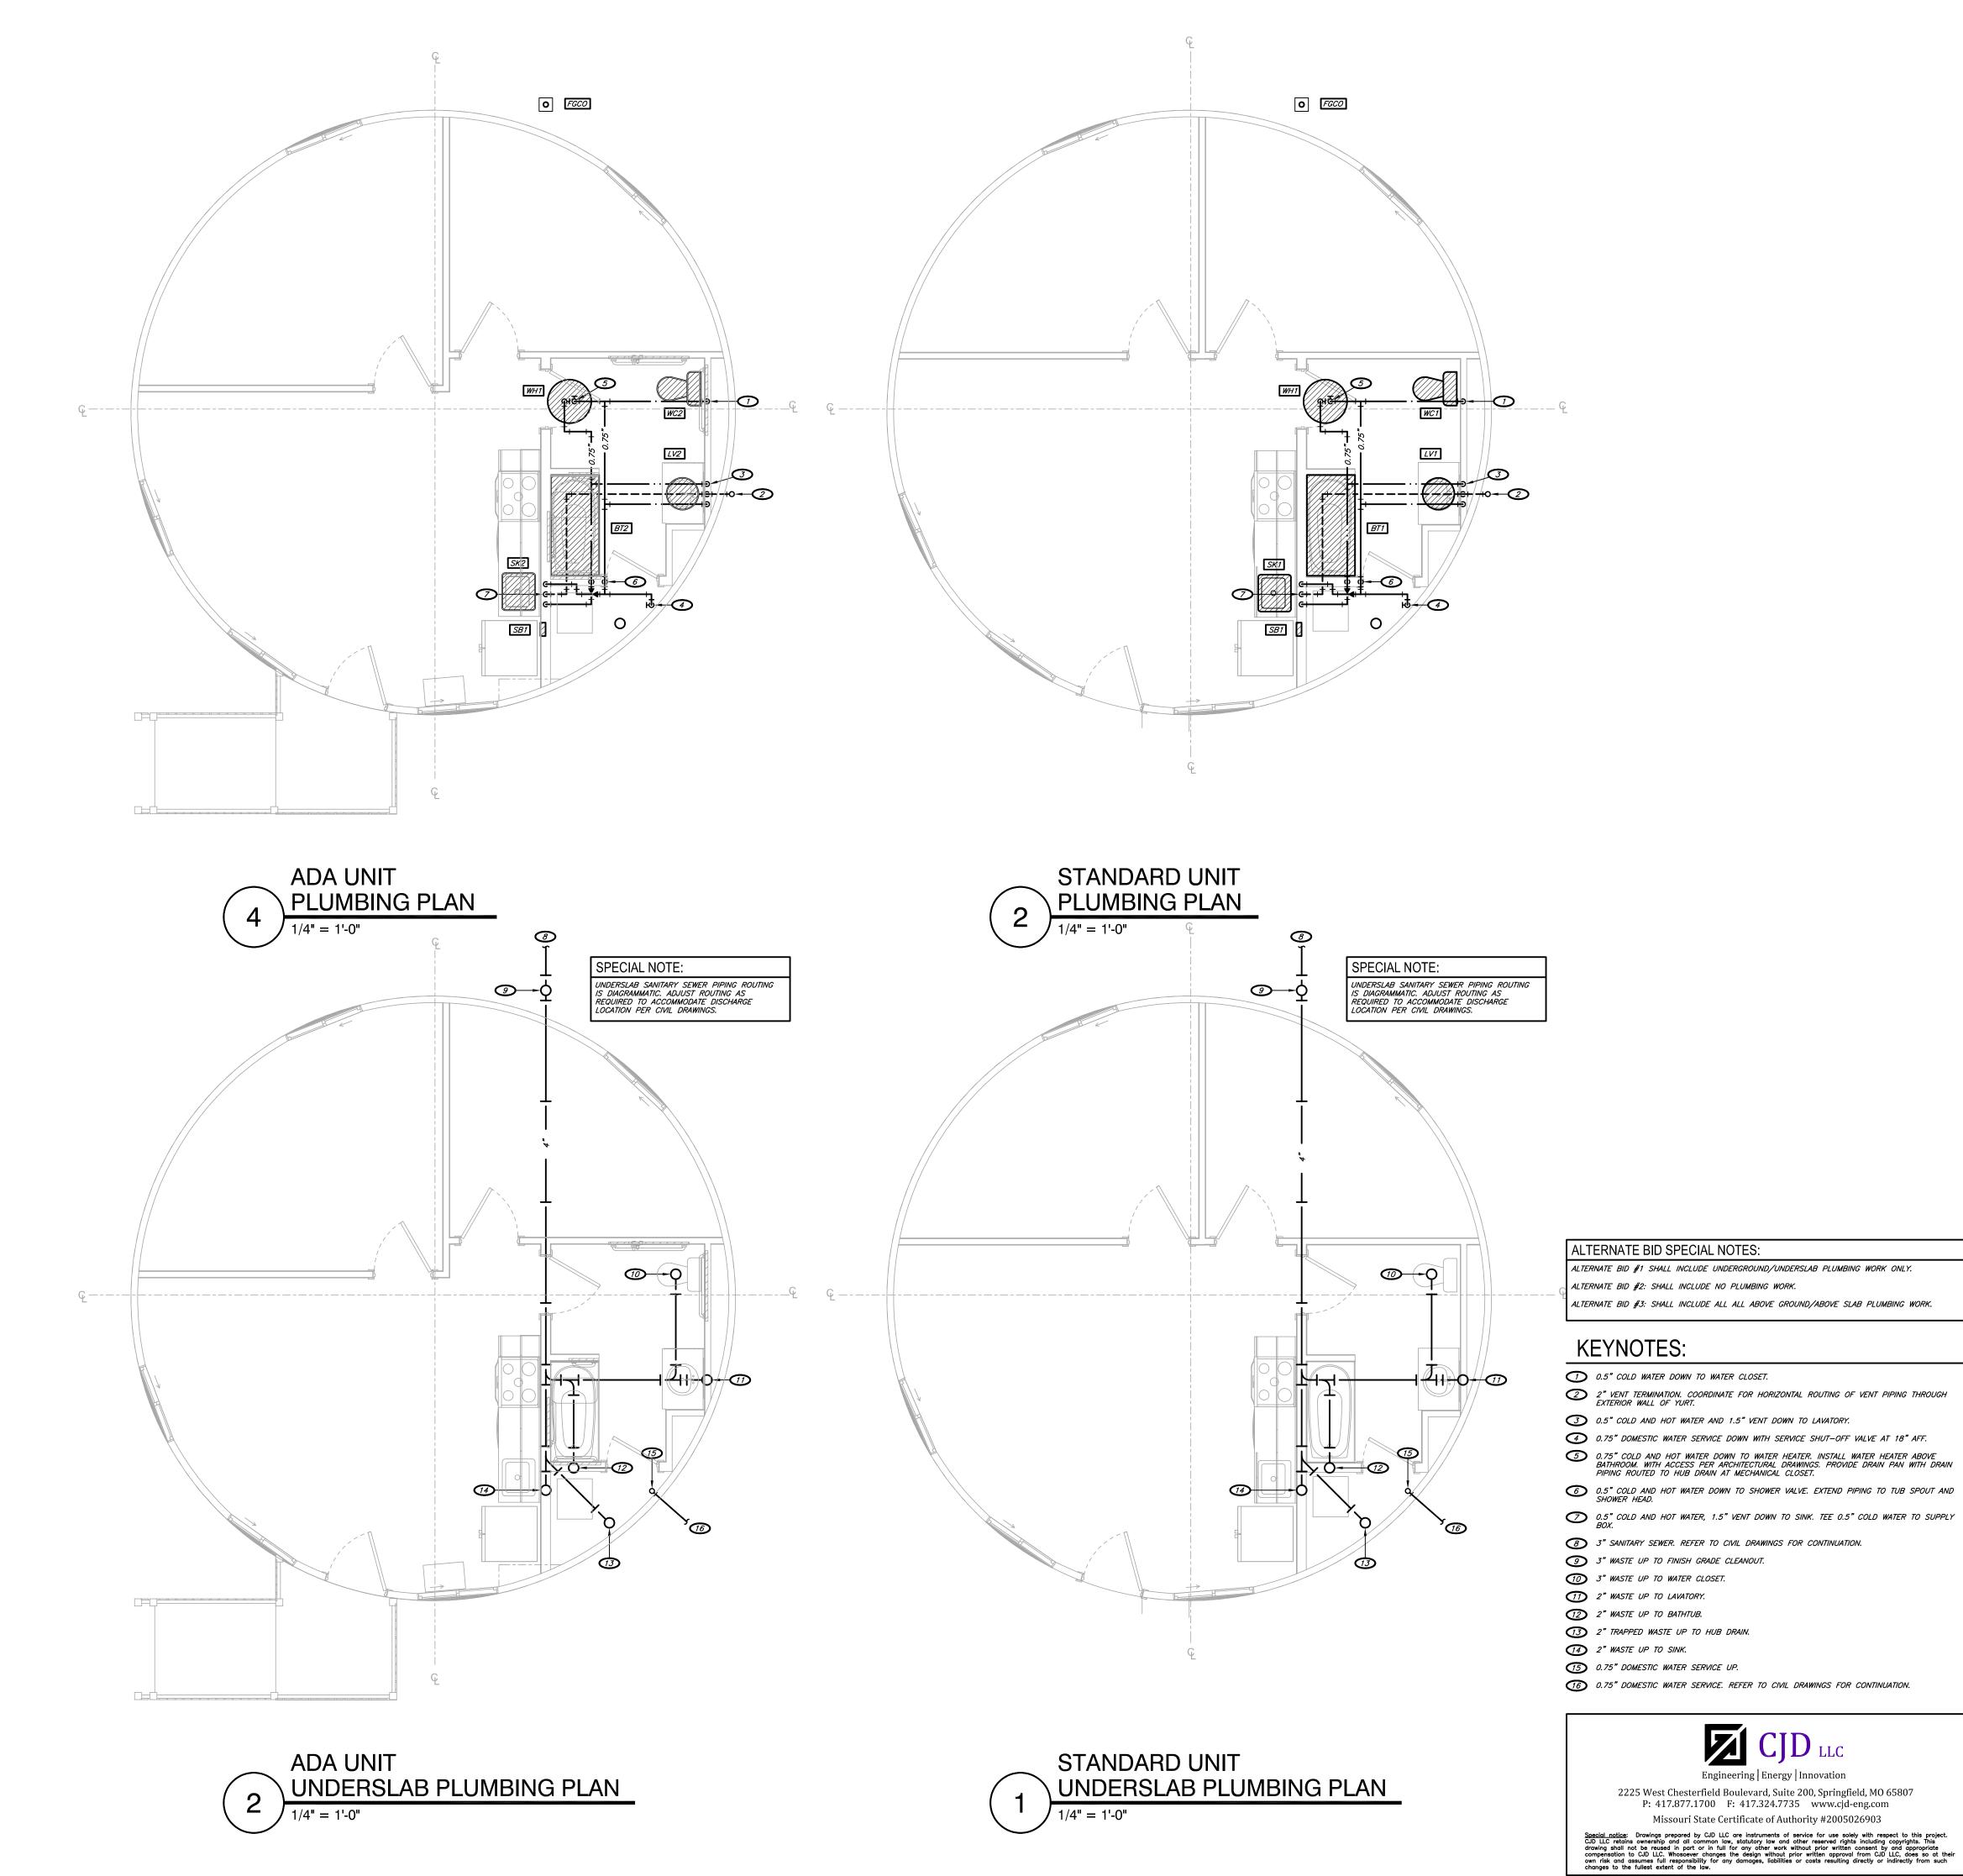





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CHECKED BY: AKD DESIGNED BY: AKD

SHEET TITLE: PLUMBING PLANS

SHEET NUMBER:

	FAN SCHEDULE													
MARK	SERVICE	MANUFACTURER	MODEL#	CFM	ESP (IN. W.C.)	MOUNTING	FINISH	DAMPER	VOLTAGE/ PHASE	MOTOR HP/WATTS	NOTES & ACCESSORIES			
EF1	BATHROOM	COOK	GC-146	75	0.25"	CEILING	WHITE	GBD	120/1	24 W	1,2,10,11,12,13,14			
NOTES & AC	CESSORIES:													

PROVIDE MULTI-SPEED (WITH TIME DELAY) MODULE.

PROVIDE 14" (ABOVE TOP OF ROOF SURFACE) INSULATED ROOF CURB WITH HINGED BASE, SLOPE AS REQUIRED.

SEE KITCHEN EQUIPMENT DRAWINGS FOR ALL REQUIREMENTS. DEMAND CONTROL VENTILATION VIA HOOD CONTROL PANEL. VFD INTEGRAL TO HOOD. SEE KITCHEN EQUIPMENT SUBMITTALS FOR ALL REQUIREMENTS.

LORENIZED FINISH OR APPROVED EQUAL.

INCLUDE SPRING VIBRATION ISOLATOR HANGERS. MOTORIZED BACKDRAFT DAMPER WITH MAX LEAK RATE OF 20 CFM/FT^2 AT 1' W.G. PER AMCA 500D. . PROVIDE WALL/SOFFIT VENT CAP OR ROOF JACK. REFER TO PLANS. PAINT TO MATCH EXTERIOR WALL/SOFFIT/ROOF COLOR.

. PROVIDE HOUSING WITH CEILING RADIATION DAMPER.

3. <u>ALL FANS SHALL BE PROVIDED AND INSTALLED BY MECHANICAL CONTRACTOR.</u> . FAN SHALL ACTIVATE WHEN LIGHT SWITCH IS ON.

6. PROVIDE ALL ACCESSORIES REQUIRED BY MANUFACTURER FOR A COMPLETE INSTALLATION INCLUDING BACKDRAFT DAMPER. 7. REFER TO ARCHITECTURAL ENLARGED UNIT PLANS FOR LOCATION OF EQUIPMENT.

			AIR D	EVICE	SCH	EDULE						
MARK	MANUFACTURER	MODEL #	DUCT CONNECTION SIZE	SERVICE	MODULE SIZE	FRAME	FINISH	DAMPER	MAX. NC	THROW (FT)	DELTA P (STATIC)	NOTES
S1	KRUEGER	80	12x6: 0-300 CFM	SUPPLY	-	SURFACE	BY ARCH	OBD	30	15	0.1"	-
S2	KRUEGER	S5DMGSR	12x6: 0-300 CFM	SUPPLY	-	SURFACE	BY ARCH	OBD	30	15	0.1"	-
R1	KRUEGER	S80	22x22: 1,600 CFM	RETURN	-	SURFACE	BY ARCH	-	30	-	0.1"	-

GRILLE/DIFFUSER SHALL MATCH ADJACENT FINISHES UNLESS NOTED OTHERSWISE. COORDINATE TO PAINT DIFFUSER AS REQUIRED. PROVIDE CEILING ASSEMBLY.
WHERE INSTALLED AT CEILING MEMBRANC OF RATED CEILING ASSEMBLY.
WHERE BALANCE DAMPERS ARE INSTALLED ABOVE HARD CEILINGS AND CANNOT BE ACCESSIBLE THROUGH THE DIFFUSER/GRILLE, PROVIDE "BOWDEN" 270-301-EZ REMOTE CABLE CONTROL KIT AND DAMPERS WITH 3" COVER PLATE BY YOUNG REGULATOR COMPANY. COORDINATE EXACT CEILING LOCATION FOR OPERATOR/COVER PLATE WITH ARCHITECT BEFORE INSTALLATION. PLASTER FRAME FOR DRYWALL INSTALLATION.

		DUCT IN	NSULATION SCHEDULE		
SYSTEM	SERVICE	CONFIGURATION	INSULATION THICKNESS	LOCATION	NOTES
AHU/SPLIT SYSTEM	SUPPLY MAIN/BRANCHES	RECTANGULAR/ROUND	1" LINER (FIRST 10 FEET FROM OUTLET) THEN 1.5" WRAP (R-4)	ALL CONCEALED INDOOR SPACES EXCEPT ATTIC	1
II.	SUPPLY MAIN/BRANCHES	RECTANGULAR/ROUND	1" LINER (R-4)	ALL EXPOSED INDOOR SPACES EXCEPT ATTIC	2,4
ū	SUPPLY MAIN/BRANCHES	RECTANGULAR/ROUND	2" WRAP (R-8)	ATTIC SPACES	1,7
ii .	SUPPLY MAIN/BRANCHES	RECTANGULAR	2" BOARD (R-8)	ALL OUTDOOR SPACES	5,6
н	RETURN MAIN/BRANCHES	RECTANGULAR/ROUND	2" WRAP (R-8)	ATTIC SPACES	1,7
II .	OUTDOOR MAIN/BRANCHES	RECTANGULAR/ROUND	2" WRAP (R-8)	ALL INDOOR/ATTIC SPACES	1

<u>NOTES:</u> 1. EXTERNAL FIBERGLASS INSULATION WRAP (1.0 LB) W/ FOIL-SCRIM-KRAFT FACING.

INTERNAL RECTANGULAR DUCT LINER (2.0 LB) WITH DUST/DIRT/MICROBIAL RESISTANT COATING ("QUIET R", "LINACOUSTIC RC", "TOUGHGARD R", "AP ARMAFLEX" OR APPROVED EQUAL.).

3. INTERNAL SPIRAL DUCT LINER (2.0 LB) INSULATION WITH PERFORATED INNER LINING AND DUST/DIRTMICROBIAL RESISTANT COATING ("QUIET R","SPIRACOUSTIC PLUS", "TOUGHGARD ULTRA","AP SPIRALFLEX" OR APPROVED EQUAL).
4. VERIFY WITH ARCHITECT WHERE EXPOSED DUCT SHALL BE PAINTED. PAINTED EXPOSED DUCT SHALL BE CLEANED OF ALL LABELS AND OIL. EXTERNAL INSULATION BOARD (1.6 LB) W/ FOIL-SCRIM-KRAFT FACING.

. PROVIDE POLYGUARD "ALUMAGUARD" DUCT WEATHER PROOF CLADDING APPLIED TO EXTERIOR DUCT INSULATION SURFACE. EXTERNAL FIBERGLASS INSULATION WRAP (1.5 LB) W/ FOIL-SCRIM-KRAFT FACING.

1. ALL METAL DUCTWORK SPECIFIED TO RECEIVE INTERIOR THERMAL AND ACOUSTICAL LINER IS SIZED ON PLANS TO EXCLUDE THE PROPER THICKNESS OF INSULATION.

DD HEIGHT AND WIDTH OF DUCTWORK TO ACCOMMODATE THICKNESS OF INSULATION AS INDICATED IN THE SCHEDULE ABOV ROVED INSULATION MANUFACTURERS: KNAUF, OWENS-CORNING, JOHNS-MANSVILLE, CERTAINTEED, ARMACELL AP. MINIMUM R-4.2/INCH. NOT TO EXCEED 25/50 FLAME/SMOKE DEVELOPMENT TESTING.

MARK	MANUFACTURER	MODEL #	SA (CFM)	OA (CFM)	EXTERNAL STATIC	ELEC HEAT (KW/STAGES)	VOLTAGE/ PHASE	MCA	моср	NOTES
AH1	DAIKIN	DV59PTCD14	1600	245	0.5"	10/1	240/1	56.5	75	1,2,3
	<u>.ER NOTES:</u> NAL STATIC PRESSU	RE INCLUDES WE	TON EXCLUDES	EII TER I OSS						
. EXTER P. PROVI	NAL STATIC PRESSU DE FRONT ACCESSIB	LE FILTER RACK	AND 2" FILTER EQ	UAL TO FARR S	30/30 WITH MER					
. EXTER P. PROVI	NAL STATIC PRESSU	LE FILTER RACK	AND 2" FILTER EQ	UAL TO FARR S	30/30 WITH MER			NG MEANS.		
. EXTER P. PROVI	NAL STATIC PRESSU DE FRONT ACCESSIB	ELE FILTER RACK R MULTI POINT W	AND 2" FILTER EQ	UAL TO FARR S POWER CONN	30/30 WITH MER NECTION WITH C	CIRCUIT BREAKER	DISCONNECTI	NG MEANS.		
. EXTER P. PROVI	NAL STATIC PRESSU DE FRONT ACCESSIB	ELE FILTER RACK R MULTI POINT W	AND 2" FILTER EQI HERE INDICATED)	UAL TO FARR S POWER CONN	30/30 WITH MER NECTION WITH C	CIRCUIT BREAKER	DISCONNECTI	NG MEANS.	МОСР	NOTES

		WA	TER	HEA	TER SCHE	DULE	Ξ		
MARK	MANUFACTURER	MODEL#	TYPE	GALLON CAPACITY	RECOVERY (GPH @ 100 F RISE)	KW	MCA	VOLTAGE/ PHASE	NOTES / ACCESSORIES
WH1	BRADFORD WHITE	LE140L3-3	ELEC	40	18	4.5	21.6	240/1	1,2,3
2. DRA 3. PRO	RMAL EXPANSION TAN AIN VALVE WITH THREA DVIDE ASME PRESSUR	IK EQUIVALENT TO AMT ADED HOSE CONNECTIO E AND TEMPERATURE F ACKET FOR FULL WEIG	N RELIEF VAL	VE.					

	PIPING MATERIAL SCHEDULE														
			PIPINO	€			FITTINGS		MAXIMUM WORKING		FIELD TEST				
SYSTEM	SIZE	TYPE	SCHEDULE	GRADE	ASTM / ANSI	MATERIAL	MATERIAL	TYPE	PRESSURE (PSI)	TEMP (DEG. F)	PRESSURE (PSI)	TIME (HOURS)	NOTES		
CONDENSATE DRAIN ABOVE GRADE	ALL	М	-	-	B88	COPPER	COPPER	DR/SJ	10 FT	40-70	10 FT	1	-		
DOMESTIC WATER ABOVE GRADE	0.5"-2"	PEX	-	-	F877	PEX	BRONZE	MJ	120	40-180	150	1	7		
DOMESTIC WATER SERVICE BELOW GRADE	ALL	PVC	-	-	AWWA C900	PVC	PVC	MJ	200	50-90	200	2	6		
REFRIGERANT PIPING	ALL	ACR			B280	CP	CP	SJ	150	40-180	200	4	-		
SANITARY WASTE BELOW GRADE	ALL	DWV	40	-	2665	PVC	PVC	DR/SW	10 FT	50-180	10 FT	1	1		
SANITARY WASTE AND VENT ABOVE GRADE	ALL	DWV	40	-	2665	PVC	PVC	DR/SW	10 FT	50-180	10 FT	1	1,3		
TEMPERATURE & PRESSURE RELIEF DRAIN	ALL	М	-	-	B88	COPPER	COPPER	DR/SJ	10 FT	40-70	10 FT	1	-		

PROVIDE REFRIGERANT LINE SET(S) SIZED PER MANUFACTURER'S RECOMMENDATIONS.

PROVIDE ALL REFRIGERATION SYSTEM ACCESSORIES REQUIRED BY MANUFACTURER FOR GIVEN LINE SET ROUTING. PROVIDE ENERGY STAR RATED, 7-DAY PROGRAMMABLE THERMOSTAT WITH REMOTE SENSOR WHERE INDICATED.

THE USE OF CELLULAR CORE PVC WASTE AND VENT PIPING IS STRICTLY PROHIBITED.

SANITARY WASTE AND VENT PIPING LOCATED WITHIN RETURN AIR PLENUMS SHALL BE CAST IRON OR SHALL BE ENCLOSED IN A GYPSUM BOARD SOFFIT. NATURAL GAS PIPING INSTALLED IN RETURN AIR PLENUMS AND CONCEALED SPACES SHALL HAVE APPROVED FITTINGS ONLY. VALVES, UNIONS, THREADED FITTINGS, ETC. ARE NOT PERMITTED.

NATURAL GAS INSTALLED OUTSIDE SHALL BE PAINTED WITH TWO COATS OF UV RESISTANT ENAMEL PAINT. COLOR TO MATCH WALL COLOR ON EXTERIOR WALL VERTICAL RUNS AND YELLOW ON THE ROOF.

PROVIDE PIPING MATERIAL PER LOCAL WATER COMPANY REQUIREMENTS IF DIFFERENT THAN SCHEDULED.

<u>.PPROVED PIPE & FITTING MANUFACTURERS:</u> :AST IRON - CHARLOTTE, TYLER, CENTERAL FOUNDRY OR PRE-BID APPROVED EQUAL. OPPER - CERRO, CHASE, MUELLER, REVERE COPPER OR PRE-BID APPROVED EQUAL.

12"0

4

ADA UNIT

OVIDE INGERSOL RAND SIMILAIR COMPRESSED AIR PIPING EQUIVALENT.

PVC (SOLID) - CHARLOTTE, TYLER, CHEMTROL OR PRE-BID APPROVED EQUAL. PVC (PERFORATED) - CHARLOTTE, TYLER, ADS 3000 (HDPE) OR PRE-BID APPROVED EQUAL. CARBON STEEL - ARMCO, YOUNGSTOWN, UNITED STATES STEEL OR PRE-BID APPROVED EQUAL.

BBREVIATIONS:

- DRAINAGE FITTING

I - CAST IRON CS - CARBON STEEL CW - CONTINUOUS WELD

DWV - DRAINAGE WASTE AND VENT HDPE - HIGH DENSITY POLYETHYLENE MJ - MECHANICAL JOINT - NEOPRENE GASKET CSST - CORRUGATED STAINLESS STEEL

- 95-5 TIN-ANTIMONY SOLDER JOINT - STANDARD STRENGTH / SERVICE WEIGHT

PIPE INSULATION SCHEDULE						
SERVICE	SIZE	TYPE	INSULATION THICKNESS	LOCATION	NOTES	
CONDENSATE PIPING	0.5"-1.25"	ELASTOMERIC	0.5"	INTERIOR	2,5	
DOMESTIC COLD WATER	0.5"-1.25"	ELASTOMERIC	0.5"	INTERIOR	1,5	
DOMESTIC HOT WATER/RECIRCULATION	0.5"-1.25"	ELASTOMERIC	1"	INTERIOR	1	
REFRIGERANT SUCTION LINES	ALL SIZES	ELASTOMERIC	0.5"	ALL	1,5	
REFRIGERANT HOT GAS/DISCHARGE	ALL SIZES	ELASTOMERIC	0.75"	INTERIOR	1,4,5	
	•			•		

ON THE STANDARD OF THE STANDAR FIBERGLASS INSULATION WRAP (1.0 LB) W/ FOIL-SCRIM-KRAFT FACING, PREFORMED, ASTM C547, CLASS 1, "K" = 0.23 AT 75 DEG. KNAUF, OWENS-CORNING, CERTAINTEED OR

FLEXIBLE ELASTOMERIC FOAMPLASTIC, SHEET MATERIAL, ASTM C534, TYPE I, "k" = 0.28 AT 75 DEG, PLENUM RATED. ARMSTRONG AP ARMAFLEX SHEET, AEROCEL EDPM SHEET, 4. VERIFY WITH EQUIPMENT MANUFACTURER'S INSTALLATION MANUAL FOR ANY ADDITIONAL INSULATION REQUIREMENTS ABOVE AS INDICATED ON THIS SCHEDULE.
5. INSULATION SHALL COVER ALL JOINTS, FITTINGS, ETC. AND SHALL BE VAPOR TIGHT.

PIPING LOCATED OUTDOORS SHALL BE PROVIDED WITH A SMOOTH ALUMINUM JACKET WITH SEAM ON TOPSIDE OF PIPE AT 2 OR 10 O'CLOCK POSITION OF HORIZONTAL RUNS. FITTINGS SHALL HAVE FORMED ALUMINUM COVERS.

	PLUMBING FIXTURE SCHEDULE									
MARK	DESCRIPTION	*******	110051 #	DESCRIPTION (ACCESSORIES	PIPI	NG CONN	IECTION S	IZES	NOTES &	FOUNDATION AND SACREDO
MARK	DESCRIPTION	MANUF.	MODEL#	DESCRIPTION / ACCESSORIES CO		нот	DRAIN	VENT	ACCESSORIES	EQUIVALENT MANUFACTURERS
BT1	BATHTUB	STERLING	71150110-0	KOHLER CFG 48003CGR TUB/SHOWER TRIM WITH 45311 ROUGH VALVE. ALL FINISHES SHALL BE POLISHED CHROMENO DOOR, CURTAIN BY OWNER.	0.5"	0.5"	2"	1.5"	1,9,14,15,17,18	AMERICAN STANDARD, KOHLER, MOEN
BT2	ADA BATHTUB	STERLING	71240115-0	KOHLER CFG 48003CGR TUB/SHOWER TRIM WITH 45311 ROUGH VALVE, MOEN UT2081 TRANSFER VALVE TRIM AND MOEN U231X TRANSFER ROUGH VALVE, CFG 40124 HANDHELD SHOWER WITH GRAB/SLIDE BAR. ALL FINISHES SHALL BE POLISHED CHROME. NO DOOR, CURTAIN BY OWNER.	0.5"	0.5"	2"	1.5"	1,8,9,14,15,17,18	AMERICAN STANDARD, KOHLER. MOEN
FFCO	FINISH FLOOR CLEANOUT	ZURN	ZN1400	CARPET FLANGE WHERE REQUIRED	-	-	SEE PLAN	-	13	JOSAM, WADE, JR SMITH, SOUIX CHIEF
FGCO	FINISH GRADE CLEANOUT	ZURN	ZN1400-HD	-	-	-	SEE PLAN	-	-	JOSAM, WADE, JR SMITH, SOUIX CHIEF
FWCO	FINISH WALL CLEANOUT	ZURN	Z1446	STAINLESS STEEL COVER	-	-	SEE PLAN	-	1,16	JAY R. SMITH, WADE, SIOUX CHIEF, MIFAB
SB1	ICE-MAKER SUPPLY BOX	GUY GRAY	AB9702	QUARTER TURN VALVE, WATTS 7C DUAL CHECK BACKFLOW PREVENTER, FLEXIBLE SUPPLY	05"	-	-	-	1,19	OATEY
LV1	UNDERMOUNT LAVATORY	KOHLER	K-20000	DELTA 538-MPU-DST FAUCET, TRAP, STOPPER, SUPPLY AND STOP VALVES. FINISH SHALL BE POLISHED CHROME	0.5"	0.5"	2"	1.5"	1,3,4,5,7,9,15	AMERICAN STANDARD, KOHLER, MOEN
LV2	ADA UNDERMOUNT LAVATORY	KOHLER	K-20000	DELTA 538-MPU-DST FAUCET, TRAP, STOPPER, SUPPLY AND STOP VALVES. FINISH SHALL BE POLISHED CHROME	0.5"	0.5"	2"	1.5"	1,3,4,5,6,7,8,9,15	AMERICAN STANDARD, KOHLER, MOEN
SK1	SINGLE COMPARTMENT DUAL MOUNT SINK	ELKAY	ECTSR25229TBG	MOEN 7585 PULL OUT FAUCET IN POLISHED CHROME FINISH, SUPPLY AND STOP VALVES. PROVIDE HAMMER ARRESTOR FOR DISHWASHER SUPPLY LINE CONFORMING TO ASSE 1010.	0.5"	0.5"	2"	1.5"	1,3,4,7,9,10	JUST, DELTA, KOHLER
SK2	ADA SINGLE COMPARTMENT DUAL MOUNT SINK	ELKAY	ECTSRAD25226TBG	MOEN 7585 PULL OUT FAUCET IN POLISHED CHROME FINISH, SUPPLY AND STOP VALVES. PROVIDE HAMMER ARRESTOR FOR DISHWASHER SUPPLY LINE CONFORMING TO ASSE 1010.	0.5"	0.5"	2"	1.5"	1,3,4,7,9,10	JUST, DELTA, KOHLER
WC1	FLUSH TANK WATER CLOSET	AMERICAN STANDARD	747AA.107SC	WHITE, 1.28-GPF, ELONGATED FRONT, SOFT-CLOSE, CLOSED FRONT, PLASTIC SEAT WITH LID	0.5"	-	4"	SEE PLAN	4,9,15,18	KOHLER, TOTO, ZURN
WC2	ADA FLUSH TANK WATER CLOSET	AMERICAN STANDARD	747AA.107SC	WHITE, 1.28-GPF, ELONGATED FRONT, SOFT-CLOSE, CLOSED FRONT, PLASTIC SEAT WITH LID	0.5"	-	4"	SEE PLAN	4,8,9,15,18	KOHLER, TOTO, ZURN

1. REFER TO ARCHITECTURAL DRAWINGS FOR MOUNTING HEIGHT.

2. PROVIDE TRUEBRO HANDI-LAV-GUARD INSULATION KIT AT ALL PUBLIC RESTROOMS AND ADA UNITS. COLOR SHALL BE SELECTED BY THE ARCHITECT. . PROVIDE PVC WASTE, TAILPIECE, AND P-TRAP AS REQUIRED. PROVIDE PLATED ESCUTCHEONS AT WALL PENETRATIONS

. PROVIDE SUPPLIES WITH CHROME PLATED BRASS ANGLE COMPRESSION VALVES AND CHROME PLATED RISER TUBES. PROVIDE PLATED ESCUTCHEONS AT WALL PENETRATIONS. PROVIDE DRAIN WITH PERFORATED GRID STRAINER AT PUBLIC AREAS.

6. INSTALL ASSE 1070 MIXING VALVE ON HOT WATER SUPPLY TO LAVATORY FAUCET. SET AT 110 DEG. F. MAXIMUM. PROVIDE SINK WITH FAUCET HOLE OPENINGS TO MATCH FAUCET.

8. INSTALL ACCESSORIES AS RECOMMENDED BY MANUFACTURER FOR ADA COMPLIANCE. MATALE ACCESSORIES SHALL BE SAME MANUFACTURER AS FIXTURE / EQUIPMENT UNLESS NOTED OTHERWISE.
 PROVIDE SINK WITH IN-SINK-ERATOR BADGER 5, 1/2 H.P. FOOD WASTE GRINDER

1. PROVIDE WITH STRAINER, AIR GAP FITTING AND DRAIN PIPING TO FLOOR DRAIN, PIT, OR MOP SINK. 2. PROVIDE STRUCTURAL STEEL CARRIER AS RECOMMENDED BY MANUFACTURER FOR SUPPORT FROM STRUCTURE 13. INSTALL FLUSH WITH SLAB AS RECOMMENDED BY EQUIPMENT MANUFACTURER.


14. FIELD COORDINATE/VERIFY FRAMING ROUGH-IN DIMENSIONS WITH ASSOCIATED CONTRACTOR BEFORE ORDERING.

5. PROVIDE PROTECTION FOR FIXTURE DURING CONSTRUCTION. UNITS DAMAGED DURING CONSTRUCTION SHALL BE REPLACED 16. PROVIDE FIRE-RATED ACCESS PANEL IN LIEU OF STAINLESS STEEL COVER WHERE CLEANOUT IS INSTALLED IN FIRE-RATED WALL.

17. PROVIDE SUPPORT FROM STRUCTURE AS RECOMMENDED BY MANUFACTURER.

18. PROVIDE RIGHT OR LEFT HAND CONFIGURATION AS REQUIRED BY PLAN. REFER TO ARCHITECTURAL DRAWINGS.

19. 604.9 WATER HAMEMR. THE FLOW VELOCITY OF THE WATER DISTRIBUTION SYSTEM SHALL BE CONTROLLED TO REDUCE THE POSSIBILITY OF WATER HAMMER. A WATER HAMMER ARRESTOR SHALL BE INSTALLED WHERE QUICK CLOSING VALVES ARE UTILIZIED. WATER HAMMER ARRESTORS SHALL BE INSTALLED IN ACCORDANCE WITH THE MANUFACTURER'S INSTRUCTIONS. WATER HAMMER ARRESTORS SHALL CONFROM TO ASSE 1010.

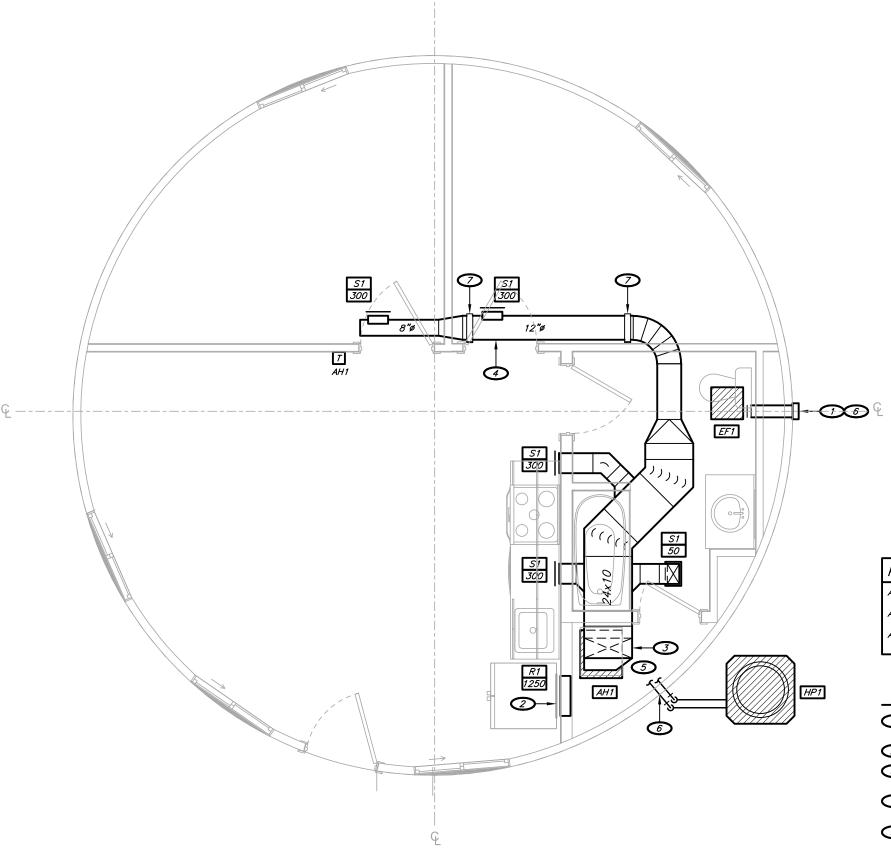

STANDARD UNIT **HVAC PLAN**

ALL MANUFACTURER'S LISTED FOR PRODUCTS, EQUIPMENT, ETC. SHALL BE CONSIDERED BASIS OF DESIGN. REFER TO GENERAL NOTES AND SPECIFICATIONS FOR LISTING OF PRE-APPROVED EQUIVALENT MANUFACTURERS. SUBMIT OTHER MANUFACTURER'S FOR APPROVAL PRIOR TO BID.

ALTERNATE BID SPECIAL NOTES: ALTERNATE BID #1 SHALL INCLUDE NO HVAC WORK.

ALTERNATE BID #2: SHALL INCLUDE NO HVAC WORK. ALTERNATE BID #3: SHALL INCLUDE ALL HVAC WORK.

KEYNOTES:

4" EXHAUST DUCT TO WALL CAP. COORDINATE FOR HORIZONTAL ROUTING OF EXHAUST DUCT THROUGH EXTERIOR WALL OF YURT. 2 INSTALL RETURN GRILLE AS HIGH AS POSSIBLE.

3 24x10 SUPPLY DUCT DOWN. TRANSITION TO AIR HANDLING UNIT OPENING. INSTALL UNIT ON FULL—SIZE RETURN PLENUM WITH SIDE OPENING.

GALVANIZED DOUBLE—WALL SPIRAL DUCTWORK WITH PERFORATED INTERIOR LINING AND PAINT GRIP FINISH. COORDINATE FOR FIELD PAINTING IN COLOR SELECTED BY ARCHITECT.

TERRIGERANT LINES TO AIR HANDLING UNIT. SIZE AND INSTALL PER MANUFACTURER'S RECOMMENDATIONS.


6 REFER TO ARCHITECTURAL DRAWINGS FOR PENETRATION DETAIL.

PROVIDE PAINTED TUBE STEEL, WALL-MOUNTED DUCT SUPPORT. DETAILING SUBJECT TO APPROVAL BY ARCHITECT. COLOR SELECTED BY ARCHITECT TO MATCH DUCTWORK.



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STATE OF MISSOURI MICHAEL L. PARSON, **GOVERNOR**

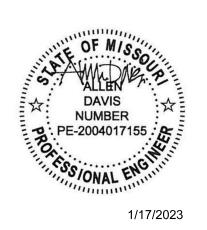

OFFICE OF ADMINISTRATION DIVISION OF FACILITIES MANAGEMENT, DESIGN AND CONSTRUCTION

DEPARTMENT OF NATURAL RESOURCES MISSOURI STATE PARKS

TABLE ROCK STATE PARK REPLACE 5 BASIC SITES WITH 5 PREMIUM YURTS

TABLE ROCK STATE PARK CAMPGROUND #2 5272 STATE HWY 165 BRANSON, MISSOURI 65616


PROJECT # X2216-01 5603 **FACILITY** # 7815603031

REVISION:
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ISSUE DATE: JANUARY 17, 2023

CAD DWG FILE: X2216-01 E-101 DRAWN BY: AKD DRAWN BY: CHECKED BY: AKD DESIGNED BY: AKD

SHEET TITLE: HVAC PLANS


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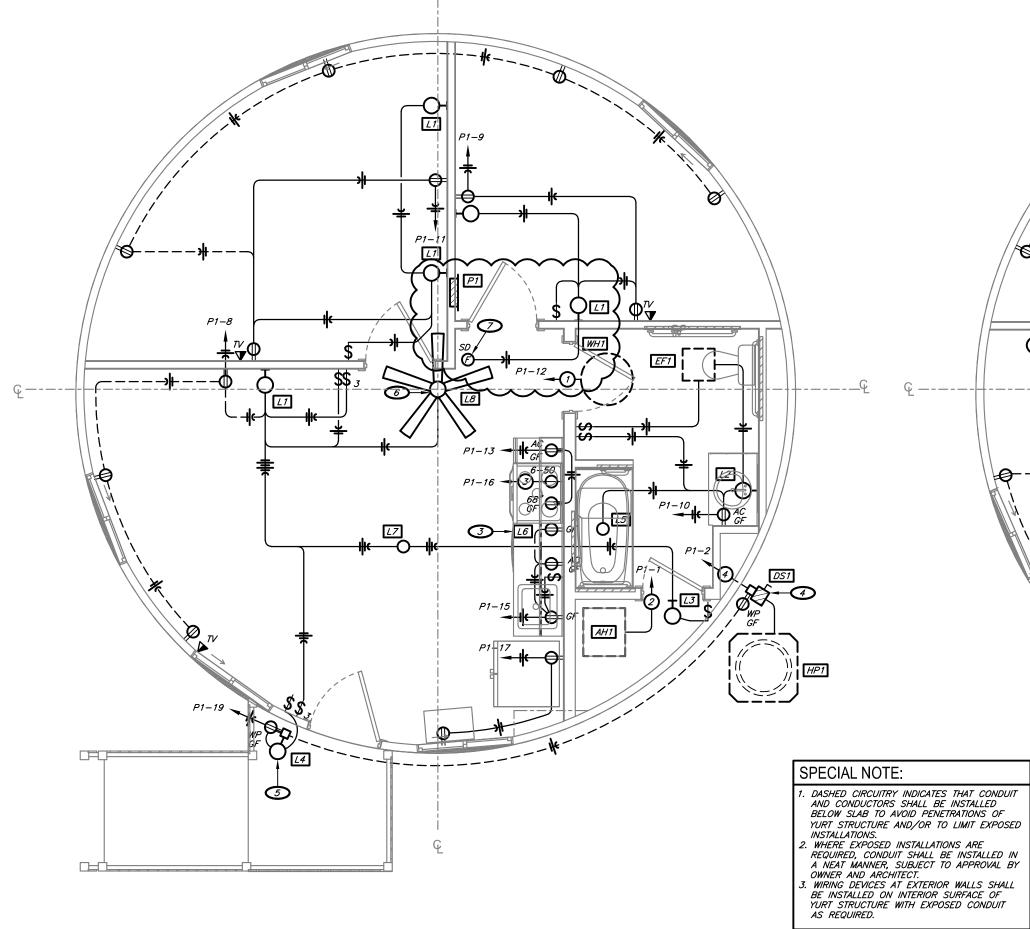


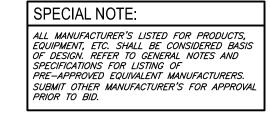			_									
MARK -	LOAD		SWITCH			OVERCU	RRENT PRO	DTECTION		NEMA	NOTES 8	
MAIN	EQUIPMENT SERVED	VOLTAGE	DUTY	AMP	POLE	TYPE	MFR	MODEL	AMP	KAIC	ENCLOSURE	ACCESS
DSA	HEAT PUMP HP1	208	GD	60	2	NF	-	-	-	-	3R	1
ACCESSORIES: ABBREVIATIONS:												
ACCESSORIE	<u>S:</u>						ABBREVIAT.	IONS:				
ACCESSORIE 1. GROUND I	_							<u>IONS:</u> OSED CIRCUIT	BREAKER			
	 .UG KIT							OSED CIRCUIT	BREAKER			
GROUND I SOLID NEG	 .UG KIT						CB - ENCL	OSED CIRCUIT	BREAKER			


PANE	LBOARD SCHED	ULE												Ρ
OLTAGE:	120/208	POLES	ì:			16		MOUNTIN	'G:		F	LUSH	LOCATION: B	BEDROO
PHASE / WII	RE: 1/3	KAIC A	MPS (F	RMS):		10		ENCLOSU	IRE:		N	EMA 1	MANUFACTURER: S	SQUARE
AMPS:	100	MCB/	MLO:	,		100		FED FROI	M:			MDP1	MODEL: H	HOMELII
	E ACCESSORIES: CH, FL							PANELBO	ARD AC	CESSOR			CL, GB, TPB	
CIRC.			C/B	C/B			PHASE I	OADS (VA)			C/B	C/B		CIR
NO.	EQUIPMENT SERVED		AMPS	POLES	C/B ACC.	LOAD (VA)	A	B	LOAD (VA)	C/B ACC.	POLES	AMPS	EQUIPMENT SERVED	NO
1	AIR HANDLER AHA		75	2	HACR	5424	7974		2550	HACR	2	20	HEAT PUMP HPA	2
3	n .					5424		7974	2550				"	4
5	REFRIGERATOR		20	1	AFCI	1000	2500		1500	AFCI	1	20	MICROWAVE	6
7	KITCHEN LIGHTS AND RECEPTACLE	S	20	1	AFCI	700		2260	1560	AFCI	1	20	LIVING ROOM RECEPTACLES	8
9	BEDROOM LIGHTS AND RECEPTACE	.ES	20	1	AFCI	1400	1900		500	AFCI	1	20	BATHROOM LIGHTS AND RECEPTACLES	10
11	BEDROOM LIGHTS & RECEPTACLES	:	20	1	AFCI	1300		3550	2250	_	2	25	WATER HEATER	12
13	APPLIANCE RECEPTACLES		20	1	-	1000	3250		2250				п	14
15	APPLIANCE RECEPTACLES		20	1	-	1000		4840	3840	_	2	40	RANGE/OVEN	16
17	APPLIANCE RECEPTACLES		20	1	_	1000	4840		3840				n	18
19	EXTERIOR RECEPTACLES AND LIGH	HTING	20	1	_	800		2600	1800	_	1	_	SEWAGE PUMP	20
21	SPACE		-	1	_			2000	7000	_	1	_	SPACE	22
23	SPACE			1							1		SPACE	24
SPACE		- CONC. - COLUI - HINGE - EXTEN - EXTEN	SSORIES: EALED HINGE IN WIDTH PANEL D DOOR WITHIN HINGED DOOR IDED GUTTER TOP IDED GUTTER BOTTOM IDED GUTTER LEFT HAND SIDE IDED GUTTER RIGHT HAND SIDE				PANELBOARI CL FTL GB GBI NBK PS SB SFR	RD ACCESSORIES - COMPRESSION LUGS - FEED-THRU LUGS - FEED-THRU LUGS - FOUND BAR INSULATOR KIT - GROUND BAR INSULATOR KIT - NEUTRAL BONDING KIT - PREPARED CIRCUIT BREAKER SPACE - SPLIT BUS - SERVICE ENTRANCE RATING			T ER SPACE	SFB - SUB-FEED CIRCUIT BREAKER SFL - SUB-FEED LUGS SPB - SILVER PLATED COPPER BUS BARS TPB - TIN PLATED ALUMINUM BUS BARS TRN - 200% RATED NEUTRAL BUS BAR		

MARK	AAANUEACTURER	MODEL#	FINICIA	MOUNTING		LAMPS		FIXTURE	VOLTACE	APPROVED	NOTES
MARK	MANUFACTURER	MODEL #	FINISH	MOUNTING	TYPE	PE CODE		WATTS	VOLTAGE	MANUFACTURERS	
L1	MAXIM LIGHTING	52126WTBK	BLACK	SURFACE	LED	WITH FIXTURE	-	18	120	SUBMIT FOR APPROVAL	-
L2	MAXIM LIGHTING	52004BK	BLACK	SURFACE	LED	WITH FIXTURE	-	20	120	SUBMIT FOR APPROVAL	-
L3	MAXIM LIGHTING	52125WTBK	BLACK	SURFACE	LED	WITH FIXTURE	-	15	120	SUBMIT FOR APPROVAL	-
L4	MAXIM LIGHTING	86199BK	BLACK	SURFACE	LED	WITH FIXTURE	-	6	120	SUBMIT FOR APPROVAL	-
L5	HALO	SMD6-9S-WH	WHITE	RECESSED	LED	WITH FIXTURE	-	10	120	SUBMIT FOR APPROVAL	-
L6	MAXIM LIGHTING	89804AL, HARD-WIRED DRIVER	WHITE	UNDER CABINET	LED	WITH FIXTURE	-	20	120	SUBMIT FOR APPROVAL	-
L7	TROY LIGHTING	F7644	BLACK	PENDANT	LED	WITH FIXTURE	-	15	120	SUBMIT FOR APPROVAL	-
L8	MINKAAIRE	F833-BK	BLACK	PENDANT	-	-	-	75	120	SUBMIT FOR APPROVAL	-
NOTES: 1. REFER TO PLANS FOR MOUNTING TYPE, FACE ORIENTATION AND CHEVRON DIRECTION. 2. FIXTURE SHALL BE IC RATED WHERE INSTALLED IN CONTACT WITH INSULATION. 3. PROVIDE INTERNAL BATTERY FOR 90 MINUTES OF EMERGENCY OPERATION. 4. VERIFY EXACT MOUNTING HEIGHT AND LOCATION WITH ARCHITECT PRIOR TO ROUGH-IN. 5. PROVIDE CLIPS OR MEAN OF SUPPORT AS REQUIRED TO COMPLY WITH N.E.C. ARTICLE 410-16. 6. FIXTURE LAMP AND BALLAST SHALL BE CAPABLE OF OPERATING DOWN TO 0 DEGREES FAND UP TO 110 DEGREES F. FIXTURE THAN BALL BE LISTED FOR OUTDOOR USE AND SHALL BE ULISTED FOR DAMP OR WET LOCATION AS REQUIRED. 8. PROVIDE ALL PARTS AND PIECES, TRANSFORMERS, COMPONENTS, ETC. FOR A FULLY FUNCTIONING SYSTEM. 9. FIXTURE TO BE INSTALLED LID IN SUPPORE CILING. 10. PROVIDE 25' SQUARE STRAIGHT STEEL POLES WITH ALL MOUNTING ACCESSORIES AS REQUIRED FOR CONFIGURATION SHOWN ON PLANS, FINISH SHALL MATCH FIXTURE. 11. PROVIDE 10' ROUND STRAIGHT STEEL POLES WITH ALL MOUNTING ACCESSORIES AS REQUIRED FOR CONFIGURATION SHOWN ON PLANS, FINISH SHALL MATCH FIXTURE. 11. PROVIDE 10' ROUND STRAIGHT STEEL POLES WITH ALL MOUNTING ACCESSORIES AS REQUIRED FOR CONFIGURATION SHOWN ON PLANS, FINISH SHALL MATCH FIXTURE. 12. FIXTURE FOR ARMY EXPRENSIVE OF MANUFACTURES REQUIREMENTS AND PIECES. AS REQUIRED FOR CONFIGURATION SHOWN ON PLANS, FINISH SHALL MATCH FIXTURE.							NSTALLED WHERE THEY MAY BE IN DIREC	ET CONTACT W			



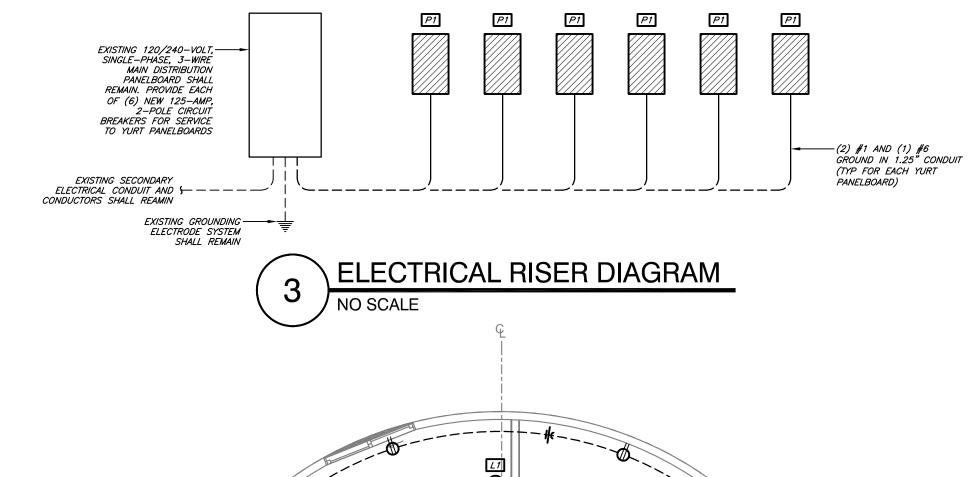

ADA UNIT ELECTRICAL PLAN

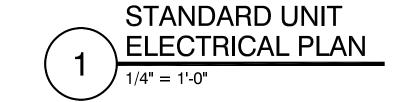

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ALTERNATE BID SPECIAL NOTES:

ALTERNATE BID #1 SHALL INCLUDE UNDERGROUND/UNDERSLAB ELECTRICAL CONDUITS.

ALTERNATE BID #2: SHALL INCLUDE NO ELECTRICAL WORK. ALTERNATE BID #3: SHALL INCLUDE ALL ALL UNDGROUND CONDUCTORS AND ABOVE GROUND/ABOVE SLAB ELECTRICAL WORK.

KEYNOTES:

- POWER FOR MICROWAVE/RANGE HOOD. FIELD COORDINATE EXACT LOCATION.
- INSTALL LIGHTING FIXTURE AT STRUCTURAL POST. REFER TO ARCHITECTURAL DRAWINGS FOR LOCATION.
- 3 UNDERCABINET LIGHTING. FIELD COORDINATE EXACT LOCATION AND DETAILING. INSTALL ELECTRICAL EQUIPMENT AND DEVICES ON 6x6 TREATED WOOD POST WITH TOP OF POST AT 2'-0" ABOVE FINISH GRADE AND WITH 12" DIAMETER, 18" DEEP CONCRETE BASE. INSTALL HOME RUN CONDUIT AND CONDUCTORS BELOW GRADE/SLAB WITH NO PENETRATIONS OF YURT STRUCTURE.
- 5) INSTALL ELECTRICAL DEVICE AND LIGHTING FIXTURE ON 6x6 TREATED WOOD POST WITH TOP OF POST AT 8'-0" ABOVE FINISH GRADE AND WITH 12" DIAMETER, 18" DEEP CONCRETE BASE OR CONNECTION TO DECK FRAMING AS APPLICABLE. INSTALL HOME RUN CONDUIT AND CONDUCTORS BELOW GRADE/SLAB WITH NO PENETRATIONS OF YURT STRUCTURE.
- 6 INSTALL CEILING FAN AT SUPPORT STRUCTURE PROVIDED WITH YURT. FIELD COORDINATE

	EXACT REQUIREMENTS.
\mathcal{O}	SMOKE DETECTOR WITHIN 12" OF BOTTOM OF DOME. SMOKE DETECTOR IN STANDARD
\ \	(NON-ADA) YURTS SHALL BE 120-VOLT, BATTERY BACKUP WITH SOUNDER ALARM. SMOK
(DETECTOR IN ADA YURT SHALL BE 120-VOLT, BATTERY BACKUP WITH SOUNDER ALARM.
(STROBE.



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STATE OF MISSOURI MICHAEL L. PARSON, **GOVERNOR**



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TABLE ROCK STATE PARK REPLACE 5 BASIC SITES WITH 5 PREMIUM YURTS

TABLE ROCK STATE PARK CAMPGROUND #2 5272 STATE HWY 165

BRANSON, MISSOURI 65616


PROJECT # X2216-01 **FACILITY** # 7815603031

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CAD DWG FILE	:X2216-01	E-10
DRAWN BY:	AKD	
CHECKED BY:	AKD	
DESIGNED BY:	AKD	

SHEET TITLE: ELECTRICAL **PLANS**

SHEET NUMBER:



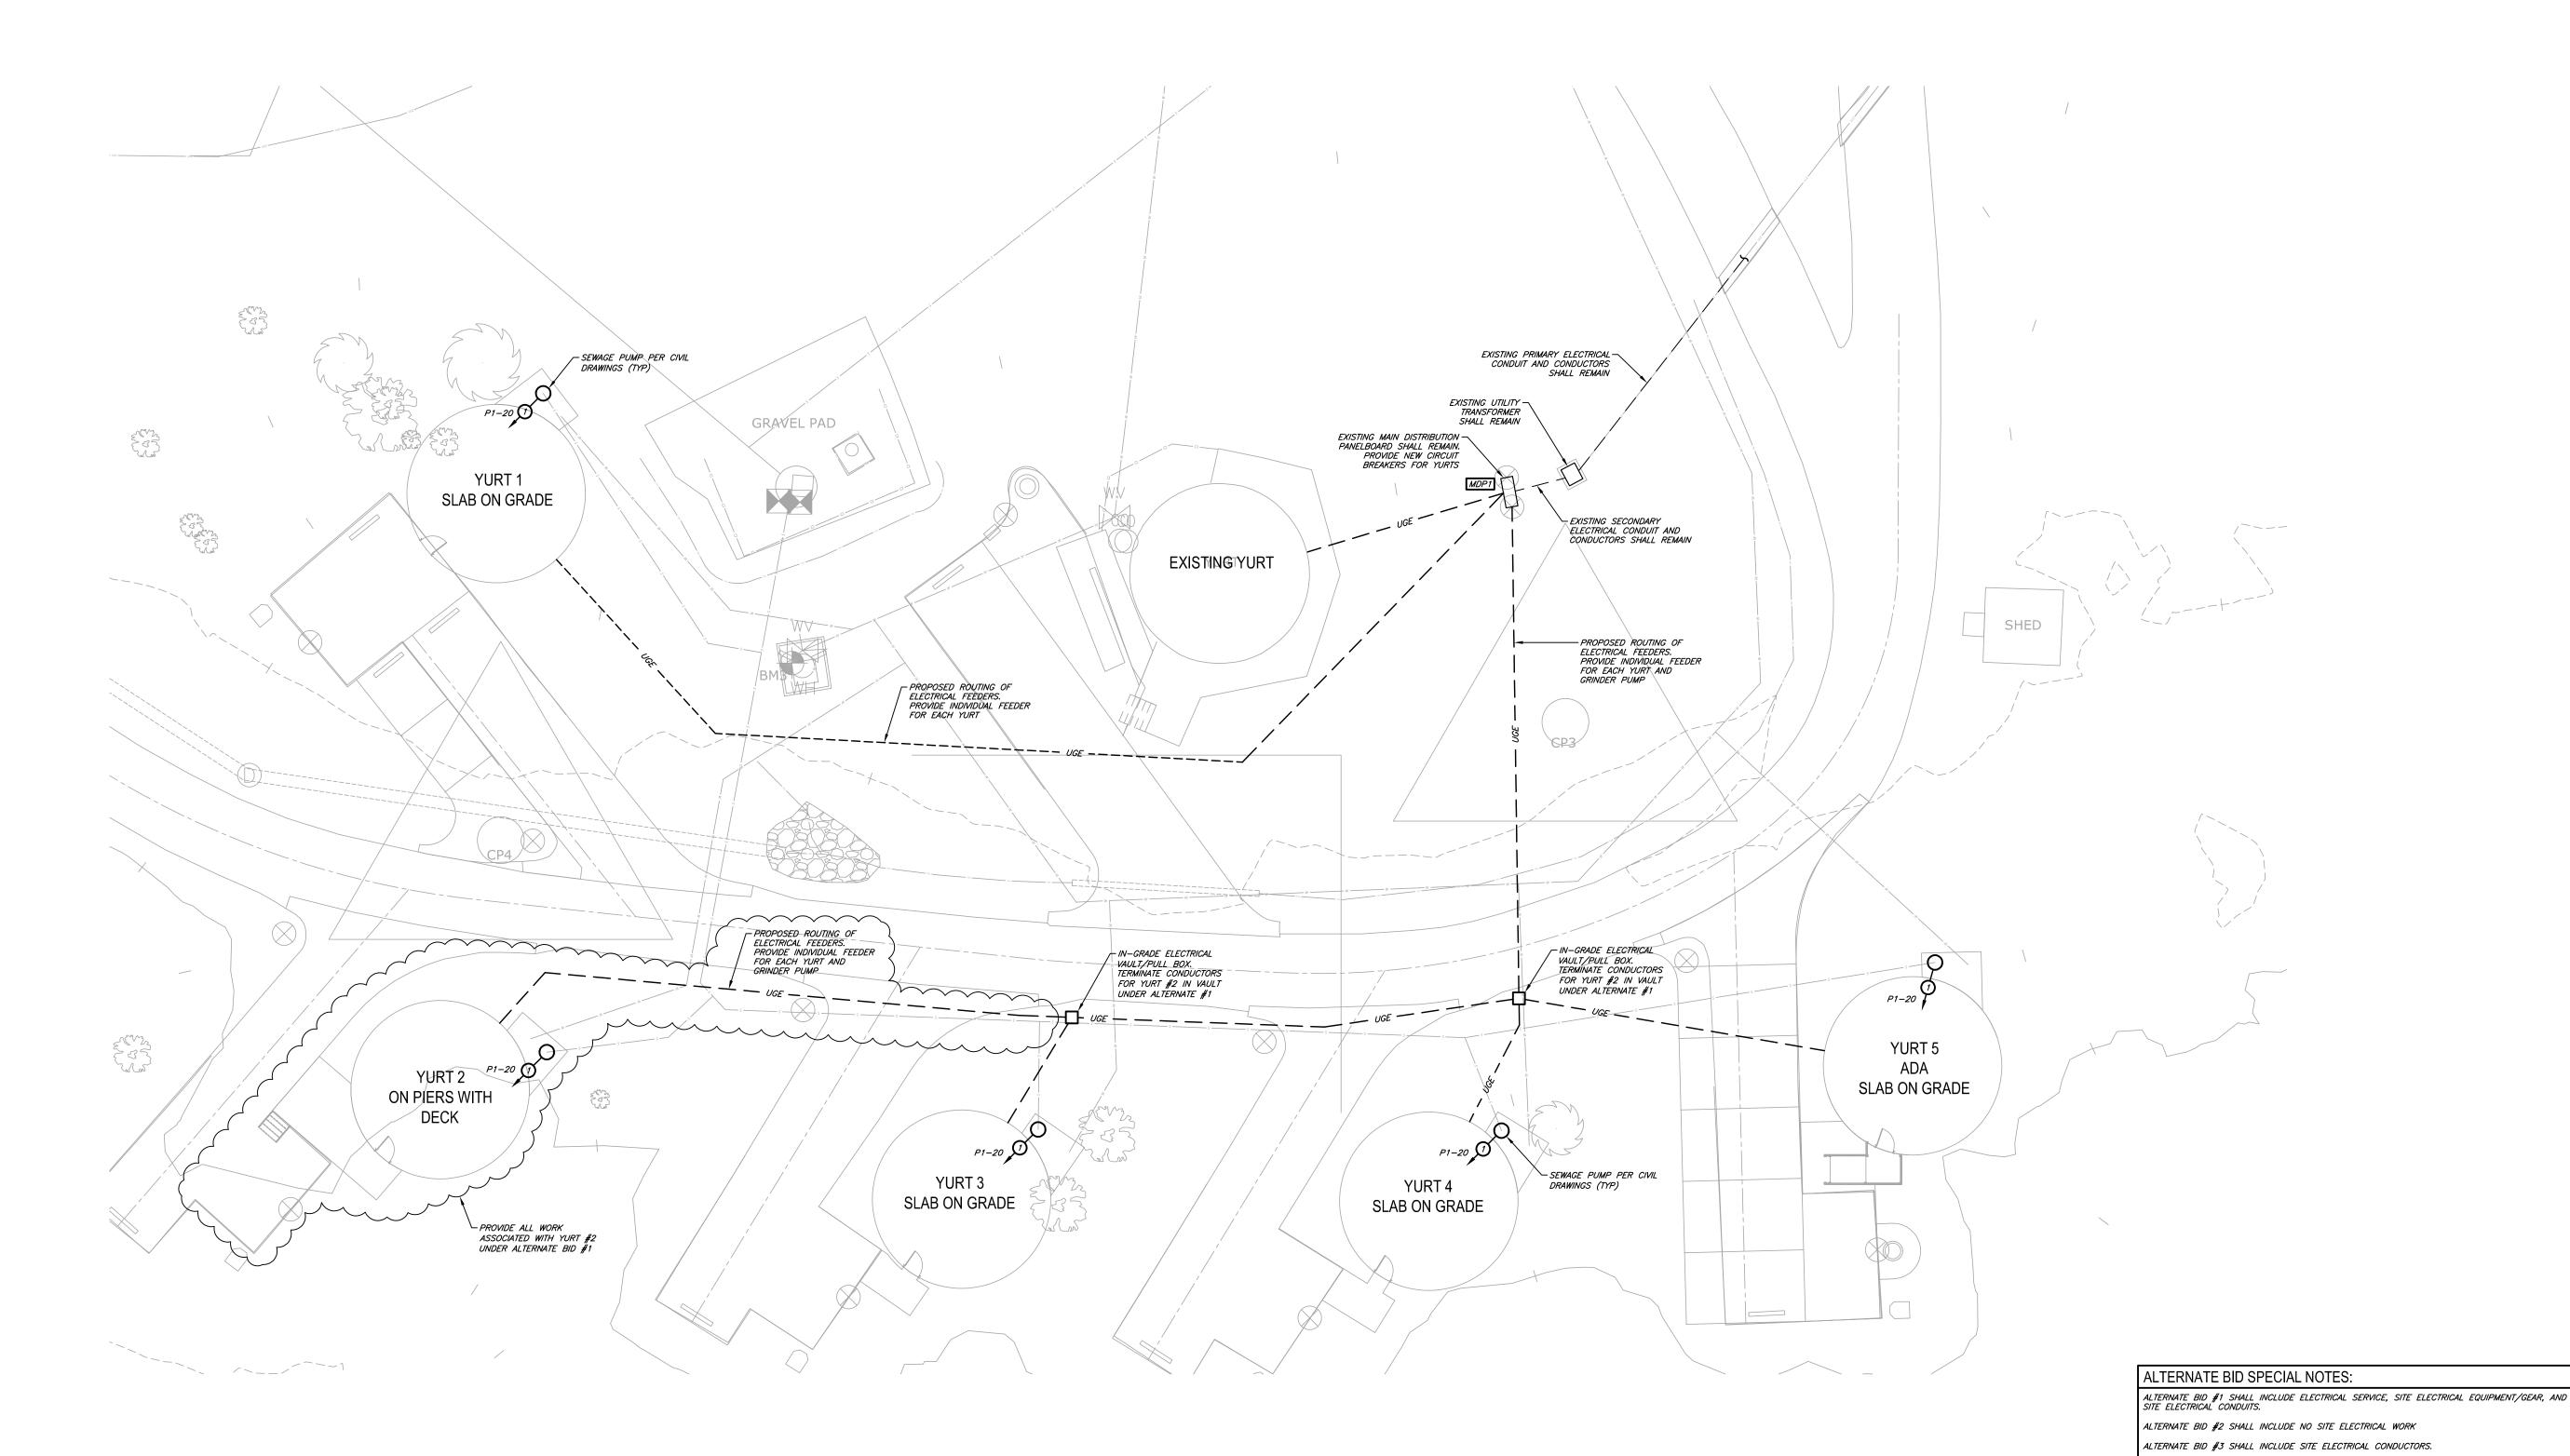

hdesigngroup



OFFICE OF ADMINISTRATION DIVISION OF FACILITIES MANAGEMENT, DESIGN AND CONSTRUCTION

DEPARTMENT OF NATURAL RESOURCES MISSOURI STATE PARKS

TABLE ROCK STATE PARK REPLACE 5 BASIC SITES WITH 5 PREMIUM YURTS

TABLE ROCK STATE PARK CAMPGROUND #2 5272 STATE HWY 165 BRANSON, MISSOURI 65616

PROJECT # X2216-01 SITE # 5603 FACILITY # 7815603031

REVISION:
DATE:
REVISION:
DATE:
REVISION:
DATE:
ISSUE DATE: JANUARY 17, 2023

CAD DWG FILE: X2216-01 SE-101
DRAWN BY: AKD
CHECKED BY: AKD
DESIGNED BY: AKD

SHEET TITLE:
SITE ELECTRICAL

SHEET NUMBER:

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PLAN

SE-101

32 OF 32 SHEETS

1 SITE ELECTRICAL PLAN

1"=150'-0"

NOR